

505 PENOBSCOT DRIVE RWC, LLC

505 PENOBSCOT PROJECT

505 Penobscot Dr, 301 Penobscot Dr and 701 Galveston Dr, Redwood City, CA 94063

ENTITLEMENT APPLICATION 10/24/2025

WRNSSTUDIO

501 SECOND STREE 4TH FLOOR, STE. 40 SAN FRANCISC CALIFORNIA 9410 415.489.2224 TE 415.358.9100 FA

swa





WATT



G-001 DRAWING INDEX, PROJECT DIRI G-002 PROJECT INFORMATION G-003 BUILDING CODE INFORMATION G-004 EXISTING SITE PHOTOS

 01 ARCHITECTURAL SITE

 A-100
 EXISTING SITE PLAN

 A-101
 PROPOSED SITE PLAN - LEVEL

 A-106
 PROPOSED SITE PLAN - ROOF

 A-110
 PROPOSED SETBACKS PLAN

A-112 CONCEPTUAL FIRE ACCESS PLAN
A-201 CONCEPTUAL RENDERINGS
A-202 CONCEPTUAL RENDERINGS
A-301 STREET ELEVATIONS

01 CIVIL

C-001 COVER SHEET

C-002 NOTES, LEGEND, ABBREVIATIOI

C-100 EXISTING CONDITIONS PLAN

C-200 PROPOSED DEMOLITION PLAN

C-400 PROPOSED SITE PLAN
C-401 CROSS SECTIONS
C-500 PROPOSED GRADING PLAN
C-600 PROPOSED UTILITY PLAN

 02 LANDSCAPE

 L-001
 OPEN SPACE FRAMEWORK

 L-101
 OVERALL LANDSCAPE SITE PLAN

04 NORTH BUILDING
AN-101 NORTH BUILDINGS AXON
AN-101 NORTH BUILDING FLOOR PLANS
AN-102 NORTH BUILDING FLOOR PLANS
AN-103 NORTH BUILDING FLOOR PLANS
AS-100 SOUTH BUILDING SAXON
AN-301 NORTH BUILDING ELEVATIONS
AN-302 NORTH BUILDING ELEVATIONS
AN-321 NORTH BUILDING SECTIONS
8

06 SOUTH BUILDING

AS-101 SOUTH BUILDING FLOOR PLANS
AS-102 SOUTH BUILDING FLOOR PLANS
AS-103 SOUTH BUILDING FLOOR PLANS
AS-104 SOUTH BUILDING FLOOR PLANS
AS-301 SOUTH BUILDING ELEVATIONS
AS-302 SOUTH BUILDING ELEVATIONS

AS-321 SOUTH BUILDING SECTIONS

PS-330 NORTH PARKING - SECTIONS

TOTAL SHEETS: 74

LT-101 ILLUSTRATIVE SITE LIGHTING PLAN
LT-102 SITE LIGHTING CHARACTER

10% PUBLIC ACCESS DIAGRAM
REGIONAL CIRCULATION DIAGRAM

CENTRAL LANDSCAPE ENLARGEMENT PLAN LANDSCAPE SITE SECTIONS - WATERFRONT LANDSCAPE SITE SECTIONS - STREETSCAPE

G-010 NORTH BLD AREA PLANS
G-012 SOUTH BLD AREA PLANS
G-021 CONTEXT DIAGRAMS AND SITE ANALYSIS

G-022 PROJECT GOALS & CONCEPT DIAGRAMS

PROPOSED SETBACKS SECTIONS

C-300 EXISTING PARCELIZATION PLAN
C-301 PROPOSED PARCELIZATION PLAN
C-302 EXISTING BOUNDARY AND EASEMENTS PLAN
C-303 PROPOSED BOUNDARY AND EASEMENTS PLAN

C-700 PROPOSED STORMWATER MANAGEMENT PLAN
C-701 PROPOSED STORMWATER MANAGEMENT DATA AND DETAILS

SHEET#

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ISSUES	DATE
ENTITLEMENT APPLICATION	09/25/2025



505 PENOBSCOT PROJECT

505 Penobscot Dr, 301 Penobscot Dr and 701 Galveston Dr, Redwood City, CA 94063

PROJECT NO.: 24040.00 DATE: 10/17/2025

SCALE: 12" = 1'-0"

SHEET TITLE:

DRAWING INDEX, PROJECT DIRECTORY, PROJECT INFO

SHEET NO:

G-001

PROJECT SUMMARY THE 13.65 ACRE PROJECT SITE IS CURRENTLY DEVELOPED WITH THREE LIFE SCIENCE/OFFICE BUILDINGS AND 463 SURFACE PARKING SPACES. THE PROJECT SITE ENCOMPASSES THE FOLLOWING PARCELS:

505 PENOBSCOT DRIVE APN: 054-320-260 83,320 GSF YEAR BUILT: 1986 301 PENOBSCOT DRIVE APN: 054-320-250 APN: 054-320-160 156,529 GSF YEAR BUILT: 1987 YEAR BUILT: 1987 701 GALVESTON DRIVE APN: 054-320-080 APN: 054-320-090 87,649 GSF YEAR BUILT: 1985

THE EXISTING BUILDINGS WOULD BE DEMOLISHED TO PREPARE FOR TWO NEW FIVE-STORY LIFE SCIENCE/OFFICE BUILDINGS TOTALING UP TO 600K GSF, TWO PARKING STRUCTURES WITH A TOTAL OF 1,499 PARKING STRUCTURE. WITH A TOTAL OF 1,499 PARKING STALLS, OPEN SPACE, SUPPORTING UTILITIES AND INFRASTRUCTURE. PEDESTRIAN AND BICYCLE PATHS, AND NEW LANDSCAPING AND TREES. THE OVERALL BUILDING HEIGHT TO PARAPET WOULD BE A MAXIMUM OF 90-100 FEET, EXCLUDING THE MECHANICAL PENTHOUSE. THE PROJECT PROPOSES VACATING TWO EXISTING PUBLIC RIGHT-OF-WAYS (PENOBSCOT DRIVE AND GALVESTON DRIVE) TO PRIVATELY MAINTAINED STREETS.

ENTITLEMENTS / PERMITS REQUESTED

1. ARCHITECTURAL PERMIT (AP): FOR NONRESIDENTIAL NEW CONSTRUCTION 2. PLANNED DEVELOPMENT PERMIT (PD/PDA): FOR NEW OFFICE DEVELOPMENT "SEEKING MINOR SETBACK MODIFICATION AS A PART OF PLANNED DEVELOPMENT PERMIT SEE 2/ A-111, PARCEL APN 054-320-260

LAND SUBDIVISION:

2. VESTING TENTATIVE PARCEL MAP FOR RECONFIGURATION OF EXISTING LOTS AND STREET GRID

DEFERRED PERMITS

- EXTERIOR SIGNAGE
 INTERNAL FIRE SPRINKLER / STANDPIPE LAYOUT & CALCULATIONS
 FIRE ALARM SYSTEMS
 LELEVATOR LOBBY / WAITING AREA TWO WAY COMMUNICATION SYSTEM
 ERRCS SYSTEM
 SOLAR PV SYSTEM

THE INTENT OF THE DRAWINGS AND SPECIFICATIONS IS TO CONSTRUCT REFERENCED PROJECT IN ACCORDANCE WITH CALIFORNIA CODE OF REGULATIONS TITLE 24. SHOULD ANY CONDITION DEVELOP NOT COVERED BY THE CONTRACT DOCUMENTS WHEREIN THE FINISHED WORK WILL NOT COMPLY WITH SAID CALIFORNIA CODE OF REGULATIONS TITLE 24, A CHANGE ORDER DETAILING AND SPECIFYING THE REQUIRED WORK SHALL BE SUBMITTED TO AND APPROVED BY THE AGENCY HAVING JURISDICTION BEFORE PROCEEDING WITH THE WORK

CALIFORNIA CODE OF REGULATIONS (CCR)

2022 CALIFORNIA ELECTRICAL CODE - PART 3, TITLE 24, CCR

2022 CALIFORNIA MECHANICAL CODE - PART 4, TITLE 24, CCR (BASED UPON 2021 UNIFORM MECHANICAL CODE)

2022 CALIFORNIA ENERGY CODE - PART 6, TITLE 24, CCR

2022 CALIFORNIA FIRE CODE - PART 9. TITLE 24. CCR (BASED UPON 2021 INTERNATIONAL FIRE CODE)

2025 REDWOOD CITY ZONING CODE, AS AMENDED

2025 REDWOOD CITY MUNICIPAL CODE. AS AMENDED

2020.09.21 ORDINANCE 2521 "REDWOOD CITY REACH CODES"

IILE 19 CCI	R, PUBLIC SAPETT, STATE FIRE WARSHAL REGULATIONS	
FPA 13	AUTOMATIC SPRINKLER SYSTEMS W/ CA AMENDMENTS	2016 EDITION
FPA 14	STANDPIPE SYSTEMS W/ CA AMENDMENTS	2016 EDITION
FPA 17A	WET CHEMICAL SYSTEMS	2016 EDITION
FPA 20	STATIONARY PUMPS	2016 EDITION
FPA 24	PRIVATE FIRE MAINS W/ CA AMENDMENTS	2016 EDITION
FPA 72	NATIONAL FIRE ALARM DOE W/ CA AMENDMENTS	2016 EDITION
FPA 2001	CLEAN AGENT FIRE EXTINGUISHING SYSTEMS	
	W/ CA AMENDMENTS	2016 EDITION

PROPERTY OWNER

METROPOLITAN LIFE INSURANCE COMPANY 425 MARKET STREET SUITE 1050 SAN FRANCISCO, CA 94105 415-489-2224

OWNER REPRESENTATIVE

ARCHITECT

WRNS STUDIO 501 SECOND STREET SUITE 402 SAN FRANCISCO, CA 94107 415-489-2224

CIVIL

BKF ENGINEERS 255 SHORELINE DRIVE SUITE 200 REDWOOD CITY, CA 94065 650-482-6453

PARKING

WATRY DESIGN INC. 2099 GATEWAY PLACE SUITE 550 SAN JOSE, CA 95110 833-917-7275

LANDSCAPE


SWA 530 BUSH STREET 6TH FLOOR SAN FRANCISCO, CA 94108 415-836-8770

LIGHTING

WATT SEATTLE, WASHINGTON

ARBORIST

HORTSCIENCE | BARTLETT CONSULTING 2550 NINTH STREET, SUITE 112, BERKELEY, CA 94710 925-785-4321

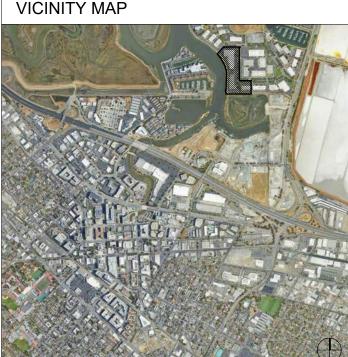



LOCATION MAP

All drawings and written material appearing herein constitute original and unpublished work of the Architect/Engineer and may not be duplicated, used or disclosed without consent of Architect/Engineer.

NORTH PENOBSCOT

505 PENOBSCOT DRIVE

EXISTING PARCELS

REFERENCE ADDRESS: ASSESSOR'S PARCEL #: PARCEL SF: CURRENT ZONING: CURRENT USE: SURROUNDING USES: PARKING:

COMMERCIAL / INDUSTRIAL 82,320 SF BUSINESS / R&D 232 SURFACE STALLS 301 PENOBSCOT DRIVE

301 PENOBSCOT DRIVE 054-320-250 054-320-160 REFERENCE ADDRESS: 156,529 SF CP COMMERCIAL / INDUSTRIAL 47,900 SF BUSINESS / R&D 123 SURFACE STALLS

PARCELS SF: CURRENT ZONING: CURRENT USE: CURRENT BUILDING GSF: SURROUNDING USES: PARKING: 701 GALVESTON DRIVE

REFERENCE ADDRESS: ASSESSOR'S PARCEL #: PARCEL SF: CURRENT ZONING:
CURRENT USE:
CURRENT BUILDING GSF:
SURROUNDING USES:

505 PENOBSCOT DRIVE 054-320-260 251,916 SF CP

ZONING:
USE:
BUILDING GSF:
FAR:
PARKING:
PARKING RATIO:
SETBACKS:
FRONT
REAR
SIDE 1.0 702 STALLS 702 STALLS / 1K GSF 2.57 STALLS / 1K GSF 25' + 1' FOR HEIGHT ABOVE 35' 25' + 1' FOR HEIGHT ABOVE 35' 15' PER SIDE = 30' TOTAL SEE A-110 / 111 FOR INFO


SOUTH PENOBSCOT REFERENCE ADDRESS: ASSESSOR'S PARCEL #:

PARCEL SF:
ZONING:
USE:
BUILDING GSF:
FAR
PARKING:
PARKING RATIO:
SETBACKS: FRON
REAR
SIDE

505 PENOBSCOT DRIVE 054-320-260 272,916 SF CP

COMMERCIAL / INDUSTRIAL 272,916 SF

301 PENOBSCOT DRIVE 054-320-250 054-320-160 054-320-080 054-320-090 321,788 SF CP COMMERCIAL / INDUSTRIAL 321,788 SF 797 STALLS / 1K GSF
2.48 STALLS / 1K GSF
NO FRONT YARD
NO REAR YARD
10' MIN PER SIDE = 40' TOTAL
SEE A-110 / 111 FOR INFO PROJECT BUILDING MAP

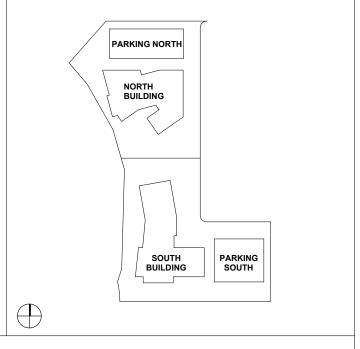

WRNSSTUDIO

501 SECOND STREET 4TH FLOOR, STE. 402 SAN FRANCISCO CALIFORNIA 94107 415.489.2224 TEL 415.358.9100 FAX www.wrnsstudio.com

swa **WATRY DESIGN, INC.**



WATT

ISSUES	DATE
ENTITLEMENT APPLICATION	09/25/2025

#	REVISION LIST	DAT

PROJECT TECHNICAL SUMMARY

701 GALVESTON DRIVE 054-320-080 054-320-090 87,649 SF

CP COMMERCIAL / INDUSTRIAL 23,880 SF BUSINESS / R&D

98 SURFACE STALLS

NORTH BUILDING

BUILDING TECHNICAL INFORMATION:			
ITEM	PROPOSED	ALLOWED	REF
CONST TYPE:	1A		CBC 601
OCCUPANCY TYPE	B, ACCESSORY A-2 (PLANNED FOR L)	ALL	
HEIGHT TO TOP OCC. FLOOR:	70'-6"	UNLIMITED	CBC 502
ZONING HEIGHT:	91'-6"	100'-0"	ARTICLE 16
ZONING STORIES:	5	UNLIMITED	CBC 504
TOTAL AREA	270K	UNLIMITED	CBC 506
LARGEST SINGLE FLOOR AREA	58K	UNLIMITED	CBC 506
SPRINKLERED:	YES		CBC 903

BUILDING AREA TABULATION

10/2/2025 5:30:31 PM

Level	Nam	e	Area
LEVEL 1	EXTERIOR COV	ERED GSF	2,158 SF
LEVEL 2	EXTERIOR COV	ERED GSF	1,537 SF
LEVEL 3	EXTERIOR COV	ERED GSF	436 SF
LEVEL 4	EXTERIOR COV	ERED GSF	999 SF
LEVEL 5	EXTERIOR COV	ERED GSF	969 SF
EXTERIOR COVER	ED GSF		6,099 SF
LEVEL 1	INTERIOR GSF		57,699 SF
LEVEL 2	INTERIOR GSF		54,580 SF
LEVEL 3	INTERIOR GSF		51,942 SF
LEVEL 4	INTERIOR GSF		50,970 SF
LEVEL 5	INTERIOR GSF		50,636 SF
ROOF	INTERIOR GSF		989 SF
INTERIOR GSF			266,816 SF
TOTAL PLANNING	GSF		272,916 SF

SOUTH BUILDING

BUILDING TECHNICAL INFORMATION:			
ITEM	PROPOSED	ALLOWED	REF
CONST TYPE:	1A		CBC 601
OCCUPANCY TYPE	B, ACCESSORY A-2 (PLANNED FOR L)	ALL	
HEIGHT TO TOP OCC. FLOOR:	70'-0"	UNLIMITED	CBC 502
ZONING HEIGHT:	90'-8"	100'-0"	ARTICLE 16
ZONING STORIES:	5 + 1 BASEMENT	UNLIMITED	CBC 504
TOTAL AREA	270K	UNLIMITED	CBC 506
LARGEST SINGLE FLOOR AREA	58K	UNLIMITED	CBC 506
SPRINKLERED:	YES		CBC 903

BUILDING AREA TABULATION

Level	Name	Area
LEVEL 1	EXTERIOR COVERED GSF	2,716 SF
LEVEL 2	EXTERIOR COVERED GSF	822 SF
LEVEL 3	EXTERIOR COVERED GSF	987 SF
LEVEL 4	EXTERIOR COVERED GSF	927 SF
EXTERIOR COVERE	D GSF	5,451 SF
LEVEL 1	INTERIOR GSF	69,632 SF
LEVEL 2	INTERIOR GSF	66,069 SF
LEVEL 3	INTERIOR GSF	59,398 SF
LEVEL 4	INTERIOR GSF	59,505 SF
LEVEL 5	INTERIOR GSF	60,689 SF
ROOF	INTERIOR GSF	1,043 SF
INTERIOR GSF		316,337 SF
TOTAL PLANNING G	SF	321,788 SF

NORTH GARAGE

BILLI DING TECHNICAL INCORMATION

BOILDING TECHNICAL INFORMATION.			
ITEM	PROPOSED	ALLOWED	REF
CONST TYPE:	IIB		CBC 601
OCCUPANCY TYPE	S-2	ALL	
HEIGHT TO TOP OCC. FLOOR:	60'-0"	75	CBC 504
ZONING HEIGHT:	60'-6"	100'-0"	ARTICLE 16
ZONING STORIES:	6	8	CBC 406
AREA PER FLOOR:	40K	50K	CBC 406
SPRINKLERED:	YES		CBC 903

BUILDING AREA TABULATION

NOTE: ALL PARKING GSF EXEMPT AND OMITTED FROM FAR CALCULATIONS

Level	Name	Area
LEVEL 01 - PN	GARAGE	40,259 SF
LEVEL 02 - PN	GARAGE	40,979 SF
LEVEL 03 - PN	GARAGE	40,259 SF
LEVEL 04 - PN	GARAGE	40,259 SF
LEVEL 05 - PN	GARAGE	40,259 SF
LEVEL 06 - PN	GARAGE	31,439 SF
GARAGE		233,454 SF

SOUTH GARAGE

BUILDING TECHNICAL INFORMATION:			
ITEM	PROPOSED	ALLOWED	REF
CONST TYPE:	IIB		CBC 601
OCCUPANCY TYPE	S-2	ALL	
HEIGHT TO TOP OCC. FLOOR:	68'-4"	75	CBC 504
ZONING HEIGHT:	68'-1"	100'-0"	ARTICLE 16
ZONING STORIES:	6.5	8	CBC 406
AREA PER FLOOR:	40K	50K	CBC 406
SPRINKI ERED:	YES		CBC 903

BUILDING AREA TABULATION

NOTE: ALL PARKING GSF EXEMPT AND OMITTED FROM FAR CALCULATIONS

Level	Name	Area
LEVEL 01 - PN	GARAGE	40,852 SF
LEVEL 2 PS	GARAGE	39,917 SF
LEVEL 3 PS	GARAGE	39,917 SF
LEVEL 4 PS	GARAGE	39,917 SF
LEVEL 5 PS	GARAGE	39,917 SF
LEVEL 6 PS	GARAGE	39,917 SF
LEVEL 6.5 PS	GARAGE	4,545 SF
GARAGE		244.984 SF

505 PENOBSCOT PROJECT

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**HIGHEST OCCP. FLOOR MEASURED FROM LOWEST POINT OF EVA ACCESS (i.e. LOWEST ADJ. EVA GUTTER).

* ZONING HEIGHT MEASURED FROM AVERAGE ADJ. GRADE TO TOP OF STRUCTURAL ROOF

***REFER TO BUILDING SECTIONS FOR ALL BUILDING HEIGHT MEASUREMENTS TO THEIR RESPECTIVE DATUMS

* ZONING HEIGHT MEASURED FROM AVERAGE ADJ. GRADE TO TOP OF STRUCTURAL ROOF **HIGHEST OCCP. FLOOR MEASURED FROM LOWEST POINT OF EVA ACCESS (i.e. LOWEST ADJ. EVA GUTTER). ***REFER TO BUILDING SECTIONS FOR ALL BUILDING HEIGHT MEASUREMENTS TO THEIR RESPECTIVE DATUMS * ZONING HEIGHT MEASURED FROM AVERAGE ADJ. GRADE TO TOP OF STRUCTURAL ROOF **HIGHEST OCCP. FLOOR MEASURED FROM LOWEST POINT OF EVA ACCESS (i.e. LOWEST ADJ. EVA GUTTER). ***REFER TO BUILDING SECTIONS FOR ALL BUILDING HEIGHT MEASUREMENTS TO THEIR RESPECTIVE DATUMS

* ZONING HEIGHT MEASURED FROM AVERAGE ADJ. GRADE TO TOP OF STRUCTURAL ROOF **HIGHEST OCCP. FLOOR MEASURED FROM LOWEST POINT OF EVA ACCESS (i.e. LOWEST ADJ. EVA GUTTER). ***REFER TO BUILDING SECTIONS FOR ALL BUILDING HEIGHT MEASUREMENTS TO THEIR RESPECTIVE DATUMS

PROJECT NO.: 24040.00 DATE: 09/25/2025 SCALE: 12" = 1'-0"

SHEET TITLE:

PROJECT INFORMATION

SHEET NO:

G-002

PARKING TECHNICAL SUMMARY

Level	Count	Level	Count	Level	Count
VEL B1	70	LEVEL 01	99	LEVEL 01	88
TAL PARKING STALI	_S: 70	LEVEL 02	121	LEVEL 02	123
		LEVEL 03	122	LEVEL 03	124
OTORCYCLE: (5%)		LEVEL 04	122	LEVEL 04	124
UNDER 100 STALLS - NOT REQ'D		LEVEL 05	122	LEVEL 05	124
		LEVEL 06	141	LEVEL 06	119
		TOTAL PARKING STAL	LS: 727	TOTAL PARKING STALLS: 702	
		*SEE PS-101 FOR STA	LL COUNT BREAKDOWNS	*SEE PN-101 FOR STALL COU	NT BREAKDOWNS
		MOTORCYCLE: (5%) = :	36 stalls	MOTORCYCLE: (5%) = 36 stall	<u>s</u>
		SOUTH GARAGE BICY	CLE PARKING	SOUTH GARAGE BICYCLE PA	ARKING
		LONG TERM (5%): 36 SHORT TERM (1:5000 s	f): 65	LONG TERM (5%): 36 SHORT TERM (1:5000 sf): 55	

SOUTH AND NORTH BUILDING CODE INDEX

TYPE OF CONSTRUCTION	TYPE IA				SECTION REFERENCE	602.2
REQUIRED FIRE RESISTIVE RATINGS	PRIMARY STRUCTURAL FF	RAME	3 HOUR			CHAPTER 6 TABLE 601
	PRIMARY STRUCTURAL FF SUPPORTING ROOF LOAD	S ONLY	1.5 HOUR			11.022.001
STEEL NOT REQ'D TO BE RATED: COLUMN BRACING	BEARING WALLS - EXTERIOR BEARING WALLS - INTERIOR		3 HOUR 3 HOUR			
BEAM BRACES & KICKERS	BEARING WALLS - INTERIO	OR .	1.5 HOUR			
MECH EQUIP SUPPORT CANOPY FRAMING	SUPPORTING ROOF LOAD		NO DATINO DE OLUBER	(EIDE 0EDAD	1.T.O.L	TABLE 705 5
STAIRS ELEVATOR RAIL SUPPORTS & DIVIDER BEAMS	NON-BEARING WALLS - EX		NO RATING REQUIRED DISTANCE GREATER T		ATION	TABLE 705.5
	NON-BEARING WALLS - INT	TERIOR	0 HOUR	D 003)		
	ROOF CONSTRUCTION		2 HOUR (UL DESIGN #E			
	STAIRWAY ENCLOSURE		2 HOUR, SEE BELOW			
	SHAFT ENCLOSURES		2 HOUR, SEE BELOW			
OCCUPANCY CLASSIFICATION	PERMITTED AS GROUP B,	ACCESSOR	RY A-3, ANTICIPATED GR	ROUP L		CHAPTER 3
ALLOWABLE BUILDING HEIGHT & AREA	ALLOWABLE HEIGHT		IMITED			TABLE 504.3
	ALLOWABLE NO. OF STOR ALLOWABLE AREA		IMITED IMITED			TABLE 504.4 TABLE 506.2
	ACTUAL HEIGHT	UNL	91'-6" (70'-6" TO TOP O	CCLIBIED EI OC	ND) @ NODTH	TABLE 300.2
ACTUAL BUILDING HEIGHT & AREA	ACTUAL REIGHT		90'-8" (70'-0" TO TOP O	CCUPIED FLOO	OR) @ SOUTH	
	ACTUAL NO. OF STORIES		5 OCCUPIED STORIES 6 OCCUPIED STORIES (INCL. BASEMENT)			
	ACTUAL AREA (PER FLOOI ACTUAL AREA (TOTAL BUI		SEE PROJECT TECHNI SEE PROJECT TECHNI			
		RATING				
FIRE SEPARATION RATING REQUIREMENTS FOR	****	1 HR				CHAPTER 6 & 7 TABLE 705.5
ON FIRE SEPARATION DISTANCE		1 HR 1 HR				
J. J	30 FT ≤ X =	0 HR				
MAXIMUM AREA OF EXTERIOR WALL	MAXIMUM AREA OF EXTER	RIOR WALL	OPENINGS (AS PERCEN	ITAGE OF WAL	L AREA)	TABLE 705.8
OPENINGS BASED ON FIRE SEPARATION DISTANCE	SEPARATION (FT): 0 -	<3 3 - <	5 5 - <10 10 - <15	15 - <20 20 -	<25 25 - <30 >30	
	UNPROTECTED, SPRINKLERED (UP,S) NF	P 15%	25% 45%	75% N	L NL NL	
	PROTECTED (P) NF	P 15%	25% 45%	75% N	L NL NL	
	(NP=NOT PERMITTED, NL=	NO LIMIT)				
FLOOR OPENINGS & SHAFTS	2 HOUR SHAFT ENCLOSURES SHA FLOOR ASSEMBLY PENET				THAN THE	CHAPTER 7 713.4
INTERIOR OPENING AND			DOOR VISION	DOOR SIDE		TABLE 716.5
WINDOW FIRE PROTECTION RATINGS	TYPE OF ASSEMBLY 1 HR FIRE PARTITION	20 MIN.	TING PANEL SIZE MAX TESTED	TRANSOM 45 MIN.	WINDOW 45 MIN.	TABLE 716.6
	1 HR FIRE BARRIER	60 MIN.	100 IN ²	NP	NOT PERMITTED	
	1 HR SMOKE BARRIER	20 MIN.				
			MAX TESTED	45 MIN.	45 MIN.	
	2HR PARTITION/SHAFT	90 MIN.	MAX TESTED 100 IN ²	45 MIN. NP	45 MIN. NP	
OCCUPANT LOAD	2HR PARTITION/SHAFT OCCUPANCY CLASSIFICATION	90 MIN.				TABLE 1004.5
OCCUPANT LOAD	OCCUPANCY	90 MIN.	100 IN ² IN OF SPACE		NP OCCUPANT LOAD	TABLE 1004.5
OCCUPANT LOAD	OCCUPANCY CLASSIFICATION	90 MIN. FUNCTION BUSINES ACCESSO	100 IN ² IN OF SPACE S AREAS DRYS/M (STORAGE/ME	NP	NP OCCUPANT LOAD (SF PER OCCUPANT)	TABLE 1004.5
OCCUPANT LOAD	OCCUPANCY CLASSIFICATION	90 MIN. FUNCTIO BUSINES ACCESSO ACCESSO	100 IN ² IN OF SPACE S AREAS	NP	NP OCCUPANT LOAD (SF PER OCCUPANT) 150 GROSS	TABLE 1004.5
OCCUPANT LOAD	OCCUPANCY CLASSIFICATION BUSINESS GROUP B	90 MIN. FUNCTION BUSINES ACCESSO (LESS THASSEMB)	100 IN ² IN OF SPACE IS AREAS ORY S / M (STORAGE/ME ORY A-2, UNCONCENTRA IAN 750 SF/50 OCC) LY, UNCONCENTRATED	NP	NP OCCUPANT LOAD (SF PER OCCUPANT) 150 GROSS 300 GROSS 15 NET	TABLE 1004.5
OCCUPANT LOAD	OCCUPANCY CLASSIFICATION BUSINESS GROUP B	90 MIN. FUNCTION BUSINES ACCESSO (LESS THASSEMB)	100 IN ² IN OF SPACE S AREAS DRY S / M (STORAGE/ME DRY A-2, UNCONCENTRA IAN 750 SF/50 OCC)	NP	NP OCCUPANT LOAD (SF PER OCCUPANT) 150 GROSS 300 GROSS 15 NET	TABLE 1004.5
OCCUPANT LOAD	OCCUPANCY CLASSIFICATION BUSINESS GROUP B ASSEMBLY GROUP A-2 LABORATORY GROUP L AGGREGATE ACCESSORY THE FLOOR AREA OF THE	90 MIN. FUNCTIC BUSINES ACCESSI ACCESSI (LESS TH ASSEMBI RESEAR OCCUPAN STORY IN V	IN OF SPACE S AREAS ORY S / M (STORAGE/ME ORY A-2, UNCONCENTRA IAN 750 SF/50 OCC) LY, UNCONCENTRATED CH SPACES CIES SHALL NOT OCCUP WHICH THEY ARE LOCAT	NP ECH/ELEC) ATED PY MORE THAITED	NP OCCUPANT LOAD (SF PER OCCUPANT) 150 GROSS 300 GROSS 15 NET 15 NET 200 GROSS	508.2.3
OCCUPANT LOAD	OCCUPANCY CLASSIFICATION BUSINESS GROUP B ASSEMBLY GROUP A-2 LABORATORY GROUP L AGGREGATE ACCESSORY	90 MIN. FUNCTIC BUSINES ACCESSI ACCESSI (LESS TH ASSEMBI RESEAR OCCUPAN STORY IN V	IN OF SPACE S AREAS ORY S / M (STORAGE/ME ORY A-2, UNCONCENTRA IAN 750 SF/50 OCC) LY, UNCONCENTRATED CH SPACES CIES SHALL NOT OCCUP WHICH THEY ARE LOCAT	NP ECH/ELEC) ATED PY MORE THAITED	NP OCCUPANT LOAD (SF PER OCCUPANT) 150 GROSS 300 GROSS 15 NET 15 NET 200 GROSS	508.2.3 508.2.4
OCCUPANT LOAD ESTIMATED OCCUPANT LOAD	OCCUPANCY CLASSIFICATION BUSINESS GROUP B ASSEMBLY GROUP A-2 LABORATORY GROUP L AGGREGATE ACCESSORY THE FLOOR AREA OF THE	90 MIN. FUNCTIC BUSINES ACCESSI ACCESSI (LESS TH ASSEMBI RESEAR OCCUPAN STORY IN V	IN OF SPACE S AREAS ORY S / M (STORAGE/ME ORY A-2, UNCONCENTRA IAN 750 SF/50 OCC) LY, UNCONCENTRATED CH SPACES CIES SHALL NOT OCCUP WHICH THEY ARE LOCAT	NP ECH/ELEC) ATED PY MORE THAITED	NP OCCUPANT LOAD (SF PER OCCUPANT) 150 GROSS 300 GROSS 15 NET 15 NET 200 GROSS	508.2.3 508.2.4
ESTIMATED OCCUPANT	OCCUPANCY CLASSIFICATION BUSINESS GROUP B ASSEMBLY GROUP A-2 LABORATORY GROUP L AGGREGATE ACCESSORY THE FLOOR AREA OF THE PER CBC 508.2.4 ACCESSORY NORTH BUILDING SCENARIO 1 - ALL OFFICE LARGEST FLOOR ARE 90% B OCCUPANCY	90 MIN. FUNCTIC BUSINES ACCESSIC ACCESSIC ASSEMBIC RESEAR OCCUPAN STORY IN V ORY OCCUP TENANCY EA = 57,000 9 150 GRO	IN OF SPACE S AREAS DRY S / M (STORAGE/ME DRY A -2, UNCONCENTRATED CH SPACES CIES SHALL NOT OCCUP WHICH THEY ARE LOCAT PANCIES NEED NOT BE S O SF SS = 3422 PERSONS	NP ECH/ELEC) ATED PY MORE THAI TED SEPARATED	NP OCCUPANT LOAD (SF PER OCCUPANT) 150 GROSS 300 GROSS 15 NET 15 NET 200 GROSS	508.2.3 508.2.4
ESTIMATED OCCUPANT	OCCUPANCY CLASSIFICATION BUSINESS GROUP B ASSEMBLY GROUP A-2 LABORATORY GROUP L AGGREGATE ACCESSORY THE FLOOR AREA OF THE PER CBC 508.2.4 ACCESSORY NORTH BUILDING SCENARIO 1 - ALL OFFICE LARGEST FLOOR ARE 90% B OCCUPANCY	90 MIN. FUNCTIC BUSINESS ACCESSIC ACCESSIC ASSEMBI RESEAR OCCUPAN STORY IN V DRY OCCUP TENANCY EA = 57,000 20 150 GRO ACCESSOR	IN OF SPACE S AREAS DRY S / M (STORAGE/ME DRY A -2, UNCONCENTRATED CH SPACES CIES SHALL NOT OCCUP WHICH THEY ARE LOCAT PANCIES NEED NOT BE S O SF SS = 342 PERSONS RY TO B) @ 15 NET = 380	NP ECH/ELEC) ATED PY MORE THAI TED SEPARATED	NP OCCUPANT LOAD (SF PER OCCUPANT) 150 GROSS 300 GROSS 15 NET 15 NET 200 GROSS 110 PERCENT OF	508.2.3 508.2.4
ESTIMATED OCCUPANT	OCCUPANCY CLASSIFICATION BUSINESS GROUP B ASSEMBLY GROUP A-2 LABORATORY GROUP L AGGREGATE ACCESSORY THE FLOOR AREA OF THE PER CBC 508.2.4 ACCESSO NORTH BUILDING SCENARIO 1 - ALL OFFICE LARGEST FLOOR AR 90% B OCCUPANCY 10% A-2 ASSEMBLY CLEAR OF THE LARGEST FLOOR AR 65% L OCCUPANCY 25% B OCCUPANCY 25% B OCCUPANCY 25% B OCCUPANCY	90 MIN. FUNCTIC BUSINES ACCESSI ACCESSI (LESS THANCY ASSEMBI RESEARI OCCUPAN STORY IN V DRY OCCUP TENANCY EA = 57,000 @ 150 GRO ACCESSOP DFFICE TE EA = 57,000 @ 200 GRO @ 200 GRO @ 150 GRO	IN OF SPACE S AREAS DRY S / M (STORAGE/ME DRY A-2, UNCONCENTR/ IAN 750 SF/50 OCC) LY, UNCONCENTRATED CH SPACES CIES SHALL NOT OCCUF WHICH THEY ARE LOCAT PANCIES NEED NOT BE S O SF SS = 342 PERSONS RY TO B) @ 15 NET = 380 NANCY ISF SS = 95 PERSONS S = 95 PERSONS S = 95 PERSONS S = 95 PERSONS S = 95 PERSONS	NP ECH/ELEC) ATED PY MORE THAI TED PERSONS PERSONS	NP OCCUPANT LOAD (SF PER OCCUPANT) 150 GROSS 300 GROSS 15 NET 15 NET 200 GROSS 110 PERCENT OF	508.2.3 508.2.4
ESTIMATED OCCUPANT	OCCUPANCY CLASSIFICATION BUSINESS GROUP B ASSEMBLY GROUP A-2 LABORATORY GROUP L AGGREGATE ACCESSORY THE FLOOR AREA OF THE PER CBC 508.2.4 ACCESSO NORTH BUILDING SCENARIO 1 - ALL OFFICE LARGEST FLOOR AR 90% B OCCUPANCY (10% A-2 ASSEMBLY (25% B OCCUPANCY (10% A-2 SSEMBLY (A	90 MIN. FUNCTIC BUSINES ACCESSI ACCESSI (LESS THANCY ASSEMBI RESEARI OCCUPAN STORY IN V DRY OCCUP TENANCY EA = 57,000 @ 150 GRO ACCESSOP DFFICE TE EA = 57,000 @ 200 GRO @ 200 GRO @ 150 GRO	IN OF SPACE S AREAS DRY S / M (STORAGE/ME DRY A-2, UNCONCENTR/ IAN 750 SF/50 OCC) LY, UNCONCENTRATED CH SPACES CIES SHALL NOT OCCUP WHICH THEY ARE LOCAT PANCIES NEED NOT BE S O SF SS = 342 PERSONS TY TO B) @ 15 NET = 380 NANCY ISF SS (SEPARATED) = 186 F	NP ECH/ELEC) ATED PY MORE THAI TED PERSONS PERSONS	NP OCCUPANT LOAD (SF PER OCCUPANT) 150 GROSS 300 GROSS 15 NET 15 NET 200 GROSS 10 PERCENT OF	508.2.3 508.2.4
ESTIMATED OCCUPANT	OCCUPANCY CLASSIFICATION BUSINESS GROUP B ASSEMBLY GROUP A-2 LABORATORY GROUP L AGGREGATE ACCESSORY THE FLOOR AREA OF THE PER CBC 508.2.4 ACCESSO NORTH BUILDING SCENARIO 1 - ALL OFFICE LARGEST FLOOR ARE 90% B OCCUPANCY 10% A-2 ASSEMBLY (A LARGEST FLOOR AR 65% L OCCUPANCY 25% B OCCUPANCY 10% A-2 SSEMBLY (A SOUTH BUILDING SCENARIO 1 - ALL OFFICE	90 MIN. FUNCTIC BUSINES ACCESSI ACCESSI (LESS TI ASSEMBI RESEAR: OCCUPAN STORY INV. ORY OCCUP TENANCY © 150 GRO © 200 GRO © 150 GRO CCESSORY TENANCY TENANCY TENANCY TENANCY TENANCY TENANCY	IN OF SPACE S AREAS DRY S / M (STORAGE/ME DRY A -2, UNCONCENTRATED DRY A-2, UNCONCENTRATED CH SPACES CIES SHALL NOT OCCUP WHICH THEY ARE LOCAT PANCIES NEED NOT BE S SS = 342 PERSONS RY TO B) @ 15 NET = 380 NANCY SS (SEPARATED) = 186 F SS = 95 PERSONS (TO B) @ 15 NET = 380 F	NP ECH/ELEC) ATED PY MORE THAI TED PERSONS PERSONS	NP OCCUPANT LOAD (SF PER OCCUPANT) 150 GROSS 300 GROSS 15 NET 15 NET 200 GROSS 10 PERCENT OF	508.2.3 508.2.4
ESTIMATED OCCUPANT	OCCUPANCY CLASSIFICATION BUSINESS GROUP B ASSEMBLY GROUP A-2 LABORATORY GROUP L AGGREGATE ACCESSORY THE FLOOR AREA OF THE PER CBC 508.2.4 ACCESSORY NORTH BUILDING SCENARIO 1 - ALL OFFICE LARGEST FLOOR AR 65% L OCCUPANCY (25% B OCCUPANCY (10% A-2 SSEMBLY (A SOUTH BUILDING SCENARIO 1 - ALL OFFICE LARGEST FLOOR AR 65% L OCCUPANCY (10% A-2 SSEMBLY (A SOUTH BUILDING SCENARIO 1 - ALL OFFICE LARGEST FLOOR AR 90% B O CCUPANCY (BOUTH BUILDING SCENARIO 1 - ALL OFFICE LARGEST FLOOR AR 90% B O CCUPANCY (BOUTH BUILDING SCENARIO 1 - ALL OFFICE LARGEST FLOOR AR 90% B O CCUPANCY (BOUTH BUILDING SCENARIO 1 - ALL OFFICE LARGEST FLOOR AR 90% B O CCUPANCY (BOUTH BUILDING BOU	90 MIN. FUNCTIC BUSINES ACCESSI ACCESSI (LESS TI ASSEMBI RESEAR: OCCUPAN STORY INV. ORY OCCUP 20 150 GRO CCESSOR TENANCY EA = 57,000 20 150 GRO CCESSOR TENANCY TENANCY EA = 70,000 20 150 GRO TENANCY TENANCY TENANCY EA = 70,000 TENANCY TEN	IN OF SPACE IN OF SPACE IS AREAS DRY A-2, UNCONCENTRATED DRY A-2, UNCONCENTRATED CH SPACES CIES SHALL NOT OCCUP WHICH THEY ARE LOCAT PANCIES NEED NOT BE S O SF SS = 342 PERSONS PAY TO B) @ 15 NET = 380 VANCY O SF SS = 95 PERSONS VANCY O SF SS = 95 PERSONS VANCY O SF SS = 95 PERSONS O SF	NP ECH/ELEC) ATED PPY MORE THAI TED SEPARATED PERSONS PERSONS PERSONS	NP OCCUPANT LOAD (SF PER OCCUPANT) 150 GROSS 300 GROSS 15 NET 15 NET 200 GROSS 10 PERCENT OF	508.2.3 508.2.4
ESTIMATED OCCUPANT	OCCUPANCY CLASSIFICATION BUSINESS GROUP B ASSEMBLY GROUP A-2 LABORATORY GROUP L AGGREGATE ACCESSORY THE FLOOR AREA OF THE PER CBC 508.2.4 ACCESSO NORTH BUILDING SCENARIO 1 - ALL OFFICE LARGEST FLOOR AR 90% B OCCUPANCY (10% A-2 ASSEMBLY (A 25% B OCCUPANCY (25% B OCCUPANCY (10% A-2 SSEMBLY (A SOUTH BUILDING SCENARIO 1 - ALL OFFICE LARGEST FLOOR AR 90% B OCCUPANCY (10% A-2 SSEMBLY (A SOUTH BUILDING SCENARIO 1 - ALL OFFICE LARGEST FLOOR AR 90% B OCCUPANCY (10% A-2 ASSEMBLY (INCOMPANCY (INCOMPANC	90 MIN. FUNCTIC BUSINES ACCESSI (LESS TI ASSEMBI RESEAR: OCCUPAN STORY IN IN DRY OCCUF TENANCY EA = 57,000 @ 150 GRO ACCESSOR TENANCY EA = 70,000 @ 150 GRO CCESSOR TENANCY EA = 70,000 @ 150 GRO CCESSOR TENANCY EA = 70,000 © 150 GRO CCESSOR	IN OF SPACE S AREAS DRY A-2, UNCONCENTRATED ORY A-2, UNCONCENTRATED ORY A-2, UNCONCENTRATED CH SPACES CIES SHALL NOT OCCUP WHICH THEY ARE LOCAT PANCIES NEED NOT BE S OSF SS = 342 PERSONS Y TO B) @ 15 NET = 380 F NANCY OSF SS (SEPARATED) = 186 F SS = 95 PERSONS Y TO B) @ 15 NET = 380 F OSF SS = 95 PERSONS Y TO B) @ 15 NET = 380 F	NP ECH/ELEC) ATED PPY MORE THAI TED SEPARATED PERSONS PERSONS PERSONS	NP OCCUPANT LOAD (SF PER OCCUPANT) 150 GROSS 300 GROSS 15 NET 15 NET 200 GROSS 10 PERCENT OF	508.2.3 508.2.4
ESTIMATED OCCUPANT	OCCUPANCY CLASSIFICATION BUSINESS GROUP B ASSEMBLY GROUP A-2 LABORATORY GROUP L AGGREGATE ACCESSORY THE FLOOR AREA OF THE PER CBC 508.2.4 ACCESSO NORTH BUILDING SCENARIO 1 - ALL OFFICE LARGEST FLOOR AR 65% L OCCUPANCY (25% B OCCUPANCY (10% A-2 ASSEMBLY (ASOUTH BUILDING SCENARIO 2 - 66/35 LAB / (LARGEST FLOOR AR 90% B OCCUPANCY (10% A-2 SSEMBLY (ASOUTH BUILDING SCENARIO 1 - ALL OFFICE LARGEST FLOOR AR 90% B OCCUPANCY (10% A-2 ASSEMBLY (CASOLITICAL OFFICE LARGEST FLOOR AR 65% L OCCUPANCY (10% A-2 ASSEMBLY (10% A-2 ASSEMBLY (10% COUPANCY (10% A-2 ASSEMBLY (10% A-2 ASSEMB	BUSINES ACCESSI ACCESSI ACCESSI ASSEMBI RESEAR: OCCUPAN STORY IN: ORY OCCUP TENANCY EA = 57,000 © 150 GRO CCESSOR TENANCY EA = 70,000 © 150 GRO ACCESSOR TENANCY EA = 70,000 CCESSOR	IN OF SPACE S AREAS DRY S / M (STORAGE/ME DRY A -2, UNCONCENTRATED DRY A -2, UNCONCENTRATED CH SPACES CIES SHALL NOT OCCUP WHICH THEY ARE LOCAT PANCIES NEED NOT BE S SS = 342 PERSONS RY TO B) @ 15 NET = 380 ANCY SS (SEPARATED) = 186 F SS (SEPARATED) = 186 F SS = 55 PERSONS RY TO B) @ 15 NET = 467 NANCY SS = 420 PERSONS RY TO B) @ 15 NET = 467 NANCY SS = 58 (SEPARATED) = 228 F SS (SEPARATED) =	NP ECH/ELEC) ATED PPY MORE THAI TED PERSONS PERSONS PERSONS PERSONS	NP OCCUPANT LOAD (SF PER OCCUPANT) 150 GROSS 300 GROSS 15 NET 15 NET 200 GROSS 10 PERCENT OF	508.2.3 508.2.4
ESTIMATED OCCUPANT	OCCUPANCY CLASSIFICATION BUSINESS GROUP B ASSEMBLY GROUP A-2 LABORATORY GROUP L AGGREGATE ACCESSORY THE FLOOR AREA OF THE PER CBC 508.2.4 ACCESSO NORTH BUILDING SCENARIO 1 - ALL OFFICE LARGEST FLOOR AR 65% L OCCUPANCY (25% B OCCUPANCY (10% A-2 ASSEMBLY (ASOUTH BUILDING SCENARIO 2 - 66/35 LAB / (LARGEST FLOOR AR 90% B OCCUPANCY (10% A-2 SSEMBLY (ASOUTH BUILDING SCENARIO 1 - ALL OFFICE LARGEST FLOOR AR 90% B OCCUPANCY (10% A-2 ASSEMBLY (CASOLITICAL OFFICE LARGEST FLOOR AR 65% L OCCUPANCY (10% A-2 ASSEMBLY (10% A-2 ASSEMBLY (10% COUPANCY (10% A-2 ASSEMBLY (10% A-2 ASSEMB	BUSINES ACCESSI ACCESSI ACCESSI ASSEMBI RESEAR: OCCUPAN STORY IN: ORY OCCUP TENANCY EA = 57,000 © 150 GRO CCESSOR TENANCY EA = 70,000 © 150 GRO ACCESSOR TENANCY EA = 70,000 CCESSOR	IN OF SPACE IN OF SPACE IS AREAS DRY A-2, UNCONCENTRATED DRY A-2, UNCONCENTRATED CH SPACES CIES SHALL NOT OCCUP PANCIES NEED NOT BE S OSF SS = 342 PERSONS YO TO B) @ 15 NET = 380 P NANCY ISF SS = 95 PERSONS Y TO B) @ 15 NET = 380 P OSF SS = 420 PERSONS YO TO B) @ 15 NET = 467 NANCY ISF SS = 420 PERSONS YO B) @ 15 NET = 467 NANCY ISF SS = 420 PERSONS YO B) @ 15 NET = 467 NANCY ISF SS (SEPARATED) = 228 F NANCY ISF SS (SEPARATED) = 228 F	NP ECH/ELEC) ATED PPY MORE THAI TED PERSONS PERSONS PERSONS PERSONS	NP OCCUPANT LOAD (SF PER OCCUPANT) 150 GROSS 300 GROSS 15 NET 15 NET 200 GROSS 10 PERCENT OF 722 PERSONS 661 PERSONS	508.2.3 508.2.4
ESTIMATED OCCUPANT	OCCUPANCY CLASSIFICATION BUSINESS GROUP B ASSEMBLY GROUP A-2 LABORATORY GROUP L AGGREGATE ACCESSORY THE FLOOR AREA OF THE PER CBC 508.2.4 ACCESSO NORTH BUILDING SCENARIO 1 - ALL OFFICE LARGEST FLOOR AR 65% L OCCUPANCY (25% B OCCUPANCY (10% A-2 ASSEMBLY (ASOUTH BUILDING SCENARIO 2 - 66/35 LAB / (LARGEST FLOOR AR 90% B OCCUPANCY (10% A-2 SSEMBLY (ASOUTH BUILDING SCENARIO 1 - ALL OFFICE LARGEST FLOOR AR 90% B OCCUPANCY (10% A-2 ASSEMBLY (CASOLITICAL OFFICE LARGEST FLOOR AR 65% L OCCUPANCY (10% A-2 ASSEMBLY (10% A-2 ASSEMBLY (10% COUPANCY (10% A-2 ASSEMBLY (10% A-2 ASSEMB	90 MIN. FUNCTIC BUSINES ACCESSI ACCESSI ACCESSI CLESS TI ASSEMBI RESEAR: OCCUPAN STORY INV. ORY OCCUP TENANCY EA = 57,000 20 150 GRO CCESSOR TENANCY TENANCY EA = 70,000 20 150 GRO ACCESSOR TENANCY EA = 70,000 20 150 GRO ACCESSOR TENANCY EA = 70,000 20 150 GRO ACCESSOR	IN OF SPACE S AREAS DRY S / M (STORAGE/ME DRY A -2, UNCONCENTRATED DRY A-2, UNCONCENTRATED CH SPACES CIES SHALL NOT OCCUP WHICH THEY ARE LOCAT PANCIES NEED NOT BE S SS = 342 PERSONS RY TO B) @ 15 NET = 380 NANCY SS (SEPARATED) = 186 F SS = 95 PERSONS RY TO B) @ 15 NET = 380 F SS = 420 PERSONS RY TO B) @ 15 NET = 467 NANCY SS (SEPARATED) = 228 F SS (SEPARATED) = 218 F SS	NP ECH/ELEC) ATED PPY MORE THAI TED PERSONS PERSONS PERSONS PERSONS	NP OCCUPANT LOAD (SF PER OCCUPANT) 150 GROSS 300 GROSS 15 NET 15 NET 200 GROSS N 10 PERCENT OF 722 PERSONS 887 PERSONS 812 PERSONS	508.2.3 508.2.4
ESTIMATED OCCUPANT LOAD	OCCUPANCY CLASSIFICATION BUSINESS GROUP B ASSEMBLY GROUP A-2 LABORATORY GROUP L AGGREGATE ACCESSORY THE FLOOR AREA OF THE PER CBC 508.2.4 ACCESSO NORTH BUILDING SCENARIO 1 - ALL OFFICE LARGEST FLOOR AR 90% B OCCUPANCY (10% A-2 ASSEMBLY (A 25% B OCCUPANCY (10% A-2 ASSEMBLY (A SOUTH BUILDING SCENARIO 1 - ALL OFFICE LARGEST FLOOR AR 90% B OCCUPANCY (10% A-2 ASSEMBLY (A SOUTH BUILDING SCENARIO 1 - ALL OFFICE LARGEST FLOOR AR 90% B OCCUPANCY (10% A-2 ASSEMBLY (A 55% L OCCUPANCY (25% B OCCUPANCY (10% A-2 ASSEMBLY (A SOUTH BLD., MAX OCCP. 8	90 MIN. FUNCTIC BUSINES ACCESSI ACCESSI ACCESSI CLESS TI ASSEMBI RESEAR: OCCUPAN STORY INV. ORY OCCUP TENANCY EA = 57,000 20 150 GRO CCESSOR TENANCY TENANCY EA = 70,000 20 150 GRO ACCESSOR TENANCY EA = 70,000 20 150 GRO ACCESSOR TENANCY EA = 70,000 20 150 GRO ACCESSOR	IN OF SPACE IN OF SPACE IS AREAS DRY S / M (STORAGE/ME DRY A-2, UNCONCENTRATED DRY A-2, UNCONCENTRATED CH SPACES CIES SHALL NOT OCCUP WHICH THEY ARE LOCAT PANCIES NEED NOT BE S OSF SS = 342 PERSONS RY TO B) @ 15 NET = 380 NANCY ISF SS = 95 PERSONS RY TO B) @ 15 NET = 380 F OSF SS = 95 PERSONS RY TO B) @ 15 NET = 467 NANCY ISF SS = 420 PERSONS RY TO B) @ 15 NET = 467 NANCY ISF SS = 117 PERSONS RY TO B) @ 15 NET = 467 NANCY ISF SS (SEPARATED) = 228 F SS = 117 PERSONS RY TO B) @ 15 NET = 467 NANCY ISF SS (SEPARATED) = 228 F SS = 117 PERSONS RY TO B) @ 15 NET = 467 NS # OF EXITS NS # OF EXITS NS # OF EXITS	NP ECH/ELEC) ATED PY MORE THAI TED PERSONS PERSONS PERSONS PERSONS PERSONS # OF EXIT	NP OCCUPANT LOAD (SF PER OCCUPANT) 150 GROSS 300 GROSS 15 NET 15 NET 200 GROSS N 10 PERCENT OF 722 PERSONS 887 PERSONS 812 PERSONS	508.2.3 508.2.4 TABLE 1004.1.2

	ORTH PARKING		/\		SECTION REFERENCE	
REQUIRED FIRE	TYPE IIB PRIMARY STRUCTURAL FRA	ME	0 HOUR			602.2 CHAPTER 6
RESISTIVE RATINGS			0 HOUR 0 HOUR			TABLE 601
	PRIMARY STRUCTURAL FRA SUPPORTING ROOF LOADS		UHOUK			
STEEL NOT REQ'D TO BE RATED:	BEARING WALLS - EXTERIOR	R	2 HOUR			
COLUMN BRACING BEAM BRACES &	BEARING WALLS - INTERIOR	t	0 HOUR			
KICKERS MECH EQUIP SUPPORT	BEARING WALLS - INTERIOR SUPPORTING ROOF LOADS		0 HOUR			
CANOPY FRAMING STAIRS	NON-BEARING WALLS - EXT		NO RATING REQUIRED (FI	RE SEPARA	ATION	TABLE 705.5
ELEVATOR RAIL SUPPORTS & DIVIDER			DISTANCE GREATER THAN			
BEAMS	NON-BEARING WALLS - INTE	RIOR	0 HOUR			
	FLOOR CONSTRUCTION		0 HOUR (UL DESIGN #D-90			
	ROOF CONSTRUCTION		0 HOUR (UL DESIGN #D-90	2)		
	STAIRWAY ENCLOSURE		0 HOUR, SEE BELOW			
	SHAFT ENCLOSURES		0 HOUR, SEE BELOW			
CCUPANCY LASSIFICATION	S-2					CHAPTER 3
LLOWABLE BUILDING	ALLOWABLE HEIGHT					TABLE 406
EIGHT & AREA	ALLOWABLE NO. OF STORIE	S 8				
	ALLOWABLE AREA		00 / FLOOR			
CTUAL BUILDING EIGHT & AREA	ACTUAL NO OF STORIES		68'-1" @ SOUTH AND 60'-6		1	
	ACTUAL NO. OF STORIES		6.5 @ SOUTH AND 6 @ NO		TION	
	ACTUAL AREA (PER FLOOR)		SEE PROJECT TECHNICAL			
	ACTUAL AREA (TOTAL BUILD		SEE PROJECT TECHNICAL	. INFURMA	IION	
	DISTANCE RAT					
TIRE SEPARATION RATING REQUIREMENTS FOR		HR				CHAPTER 6 & TABLE 705.5
XTERIOR WALLS BASED ON FIRE SEPARATION	5 FT ≤ X < 10 FT = 1 H	HR				
ISTANCE	10 FT ≤ X < 30 FT = 1 H	HR				
	30 FT ≤ X = 0 H	HR				
AXIMUM AREA OF XTERIOR WALL	MAXIMUM AREA OF EXTERIOR	OR WALL	OPENINGS (AS PERCENTAG	SE OF WALI	_AREA)	TABLE 705.8
OPENINGS BASED ON FIRE SEPARATION DISTANCE	SEPARATION (FT): 0 - <3	3 - <5	5 - <10 10 - <15 15 -	<20 20 -	<25 25 - <30 >30	
	UNPROTECTED,					
	SPRINKLERED (UP,S) NP	15%		5% N		
	PROTECTED (P) NP	15%	25% 45% 75	5% N	IL NL NL	
000 005111100 4	(NP=NOT PERMITTED, NL=N	O LIMIT)				OLIA DTED 7
LOOR OPENINGS & HAFTS	0 HOUR	NOTUA	/E A FIDE DEGICTANCE DAT	INO 1 E00 :	THAN THE	CHAPTER 7 713.4
	SHAFT ENCLOSURES SHALL FLOOR ASSEMBLY PENETRA				INAN INE	
ITERIOR OPENING AND	TYPE OF ASSEMBLY D	OOR RAT		OOR SIDEI	LITE/ WINDOW	TABLE 716.5 TABLE 716.6
ROTECTION RATINGS		0 MIN.		5 MIN.	45 MIN.	TABLE 7 10.0
		0 MIN.	100 IN ² N	P	NOT PERMITTED	
	1 HR SMOKE BARRIER 2	0 MIN.	MAX TESTED 4	5 MIN.	45 MIN.	
	2HR PARTITION/SHAFT 9	0 MIN.	100 IN ² N	Р	NP	
CCUPANT LOAD	OCCUPANCY	FLINCTIO	N OF SPACE		OCCUPANT LOAD	TABLE 1004.5
CCOPAINT LOAD	CLASSIFICATION	FUNCTIO	N OF SPACE		(SF PER OCCUPANT)	TABLE 1004.5
	STORAGE S-2	LOW HAZ	ARD, PUBLIC PARKING GAR	AGE	200 GROSS	
		ACCESSO	DRY M (MECH/ ELEC)		300 GROSS	
	AGGREGATE ACCESSORY O	CCUPAN	CIES SHALL NOT OCCUPY M	IORE THAN	N 10 PERCENT OF	508.2.3
	THE FLOOR AREA OF THE ST	FORY IN V	VHICH THEY ARE LOCATED			
	PER CBC 508 2.4 ACCESSOR	Y OCCUP	ANCIES NEED NOT BE SEPA	ARATED		508.2.4
	353 000.2.4 AUGLOSUR					TABLE 1004.1
		OR ARE	A (NORTH) = 41 000 SF		205 PERSONS	TABLE 1004.1.
	TYPICAL GARAGE LEVEL FLO S-2 OCCUPANCY @ 20	OOR ARE	A (NORTH) = 41,000 SF = 205 PERSONS		205 PERSONS	TABLE 1004.1.
	TYPICAL GARAGE LEVEL FLC S-2 OCCUPANCY @ 20	0 GROSS	= 205 PERSONS		205 PERSONS	TABLE 1004.1.
	TYPICAL GARAGE LEVEL FLO	0 GROSS	= 205 PERSONS A (SOUTH) = 41,000 SF		205 PERSONS 205 PERSONS	TABLE 1004.1.
	TYPICAL GARAGE LEVEL FLC S-2 OCCUPANCY @ 20 TYPICAL GARAGE LEVEL FLC	0 GROSS	= 205 PERSONS A (SOUTH) = 41,000 SF			TABLE 1004.1.
	TYPICAL GARAGE LEVEL FLC S-2 OCCUPANCY @ 20 TYPICAL GARAGE LEVEL FLC	0 GROSS	= 205 PERSONS A (SOUTH) = 41,000 SF			TABLE 1004.1.
	TYPICAL GARAGE LEVEL FLC S-2 OCCUPANCY @ 20 TYPICAL GARAGE LEVEL FLC	0 GROSS	= 205 PERSONS A (SOUTH) = 41,000 SF			TABLE 1004.1.
	TYPICAL GARAGE LEVEL FLC S-2 OCCUPANCY @ 20 TYPICAL GARAGE LEVEL FLC	0 GROSS	= 205 PERSONS A (SOUTH) = 41,000 SF			TABLE 1004.1.
	TYPICAL GARAGE LEVEL FLC S-2 OCCUPANCY @ 20 TYPICAL GARAGE LEVEL FLC	0 GROSS	= 205 PERSONS A (SOUTH) = 41,000 SF			TABLE 1004.1.
	TYPICAL GARAGE LEVEL FLC S-2 OCCUPANCY @ 20 TYPICAL GARAGE LEVEL FLC	0 GROSS	= 205 PERSONS A (SOUTH) = 41,000 SF			TABLE 1004.1.
	TYPICAL GARAGE LEVEL FLO S-2 OCCUPANCY @ 20 TYPICAL GARAGE LEVEL FLO	0 GROSS	= 205 PERSONS A (SOUTH) = 41,000 SF			TABLE 1004.1.
	TYPICAL GARAGE LEVEL FLO S-2 OCCUPANCY @ 20 TYPICAL GARAGE LEVEL FLO	0 GROSS	= 205 PERSONS A (SOUTH) = 41,000 SF			TABLE 1004.1.
ESTIMATED OCCUPANT OAD	TYPICAL GARAGE LEVEL FLO S-2 OCCUPANCY @ 20 TYPICAL GARAGE LEVEL FLO	0 GROSS	= 205 PERSONS A (SOUTH) = 41,000 SF			TABLE 1004.1.
OAD	TYPICAL GARAGE LEVEL FLO S-2 OCCUPANCY @ 20 TYPICAL GARAGE LEVEL FLO S-2 OCCUPANCY @ 20	0 GROSS	= 205 PERSONS A (SOUTH) = 41,000 SF = 205 PERSONS			
OAD	TYPICAL GARAGE LEVEL FLC S-2 OCCUPANCY @ 20 TYPICAL GARAGE LEVEL FLC S-2 OCCUPANCY @ 20 # OF EXITS LEVEL # OF EXITS	0 GROSS OOR ARE 0 GROSS	= 205 PERSONS A (SOUTH) = 41,000 SF = 205 PERSONS DEEXITS OVIDED			1006.3.1
	TYPICAL GARAGE LEVEL FLC S-2 OCCUPANCY @ 20 TYPICAL GARAGE LEVEL FLC S-2 OCCUPANCY @ 20	0 GROSS OOR ARE 0 GROSS	= 205 PERSONS A (SOUTH) = 41,000 SF = 205 PERSONS			1006.3.1
)AD	TYPICAL GARAGE LEVEL FLC S-2 OCCUPANCY @ 20 TYPICAL GARAGE LEVEL FLC S-2 OCCUPANCY @ 20 # OF EXITS LEVEL # OF EXITS	0 GROSS OOR ARE 0 GROSS	= 205 PERSONS A (SOUTH) = 41,000 SF = 205 PERSONS DEEXITS OVIDED			

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swa **WATRY DESIGN, INC.**



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ISSUES	DATE
ENTITLEMENT APPLICATION	09/25/2025

505 PENOBSCOT PROJECT

505 Penobscot Dr, 301 Penobscot Dr and 701 Galveston Dr, Redwood City, CA 94063

PROJECT NO.: 24040.00 DATE: 09/25/2025

SCALE: 12" = 1'-0"

SHEET TITLE:

BUILDING CODE INFORMATION

SHEET NO:













REVISION LIST


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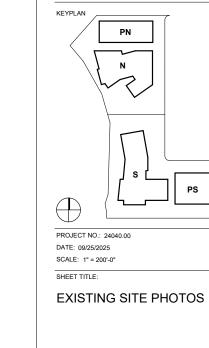


PHOTO 4







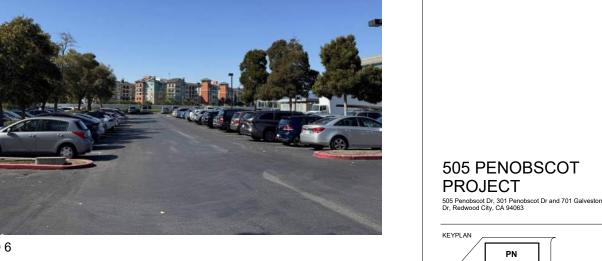

SITE PLAN PHOTO KEY






РНОТО 8

SHEET NO:

Level	Name	Area
LEVEL 1	EXTERIOR COVERED GSF	2,158 SF
LEVEL 2	EXTERIOR COVERED GSF	1,537 SF
LEVEL 3	EXTERIOR COVERED GSF	436 SF
LEVEL 4	EXTERIOR COVERED GSF	999 SF
LEVEL 5	EXTERIOR COVERED GSF	969 SF
EXTERIOR COVE	RED GSF	6,099 SF
LEVEL 1	INTERIOR GSF	57,699 SF
LEVEL 2	INTERIOR GSF	54,580 SF
LEVEL 3	INTERIOR GSF	51,942 SF
LEVEL 4	INTERIOR GSF	50,970 SF
LEVEL 5	INTERIOR GSF	50,636 SF
ROOF	INTERIOR GSF	989 SF
INTERIOR GSF		266,816 SF
TOTAL PLANNIN	G GSF	272,916 SF

Level	Name	Area
LEVEL 1	UNCOVERED OUTDOOR SPACE	2,845 SF
LEVEL 2	UNCOVERED OUTDOOR SPACE	2,024 SF
LEVEL 3	UNCOVERED OUTDOOR SPACE	1,431 SF
ROOF	MECH	3,545 SF
TOTAL NOT CO	DUNTED AGAINST GSF	9.845 SF

20.0.		7 11 0 0
LEVEL 1	UNCOVERED OUTDOOR SPACE	2,845 SF
LEVEL 2	UNCOVERED OUTDOOR SPACE	2,024 SF
LEVEL 3	UNCOVERED OUTDOOR SPACE	1,431 SF
ROOF	MECH	3,545 SF
TOTAL NOT COUN	TED AGAINST GSF	9,845 SF

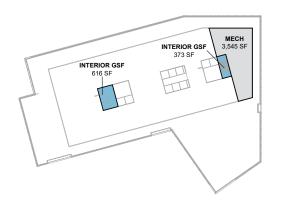



UNCOVERED OUTDOOR SPACE 1,431 SF


NORTH BLD LEVEL 3

EXTERIOR COVERED_ GSF 436 SF


EXTERIOR COVERED_ GSF 452 SF

NORTH BLD LEVEL 4


10/2/2025 11:07:52 AM

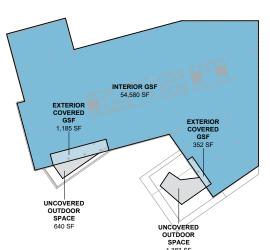

NORTH BLD LEVEL 2

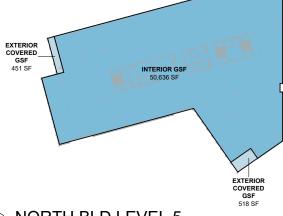

5 NORTH BLD LEVEL 5

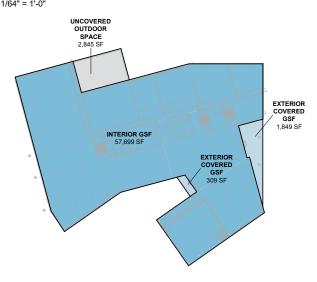

NORTH BLD LEVEL 1

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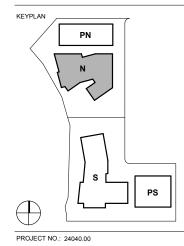
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ISSUES	DATE
ENTITLEMENT APPLICATION	09/25/2025

REVISION LIST

505 PENOBSCOT PROJECT

505 Penobscot Dr, 301 Penobscot Dr and 701 Galveston Dr, Redwood City, CA 94063



DATE: 09/25/2025 SCALE: 1/64" = 1'-0"

SHEET TITLE:

NORTH BLD AREA PLANS

SHEET NO:

	Level	Name	Area
LEVEL	B1	BASEMENT	35,629 SF
LEVEL	B1	PARKING	35,332 SF
LEVEL	1	UNCOVERED OUTDOOR SPACE	3,762 SF
LEVEL	2	UNCOVERED OUTDOOR SPACE	0 SF
LEVEL	3	UNCOVERED OUTDOOR SPACE	1,732 SF
ROOF		MECH	2,649 SF
TOTAL	NOT COUNTE	ED AGAINST GSF	79,104 SF

Level	Name	Area
LEVEL 1	EXTERIOR COVERED GSF	2,716 SF
LEVEL 2	EXTERIOR COVERED GSF	822 SF
LEVEL 3	EXTERIOR COVERED GSF	987 SF
LEVEL 4	EXTERIOR COVERED GSF	927 SF
EXTERIOR COVERE	D GSF	5,451 SF
LEVEL 1	INTERIOR GSF	69,632 SF
LEVEL 2	INTERIOR GSF	66,069 SF
LEVEL 3	INTERIOR GSF	59,398 SF
LEVEL 4	INTERIOR GSF	59,505 SF
LEVEL 5	INTERIOR GSF	60,689 SF
ROOF	INTERIOR GSF	1,043 SF
INTERIOR GSF		316,337 SF
TOTAL PLANNING G	SF	321 788 SE

	ISSUES	DATE
Area	ENTITLEMENT APPLICATION	09/25/2025
35,629 SF		
35,332 SF		
3.762 SF		

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#	REVISION LIST	DATI

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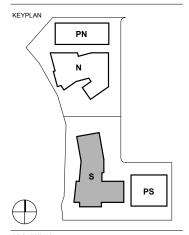
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505 PENOBSCOT PROJECT

505 Penobscot Dr, 301 Penobscot Dr and 701 Galvestor Dr, Redwood City, CA 94063




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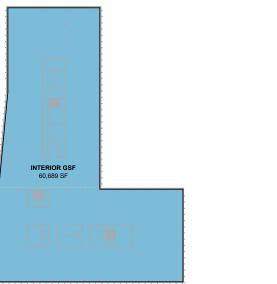
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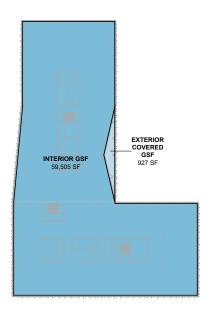
SOUTH BLD AREA PLANS

SHEET NO:


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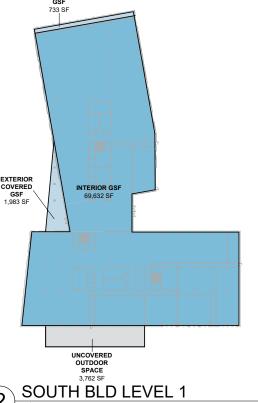







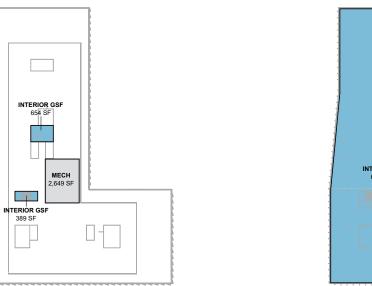



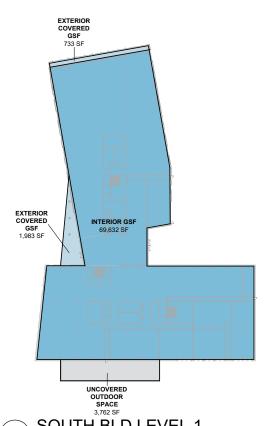

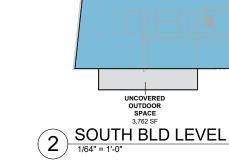

SOUTH BLD LEVEL 3

10/2/2025 11:08:05 AM

SOUTH BLD ROOF

INTERIOR GSF 59,398 SF

SOUTH BLD LEVEL 2

UNCOVERED OUTDOOR SPACE Not Enclosed

SOUTH BLD LEVEL 5

INTERIOR GSF 66,069 SF


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PARKING 35,332 SF

SOUTH BLD LEVEL B1


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SITE ACCESS AND ENTRY




SITE BIKE NETWORK

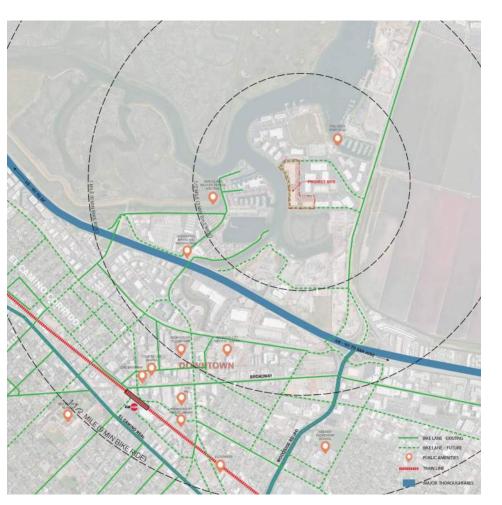10/2/2025 9:25:23 AM

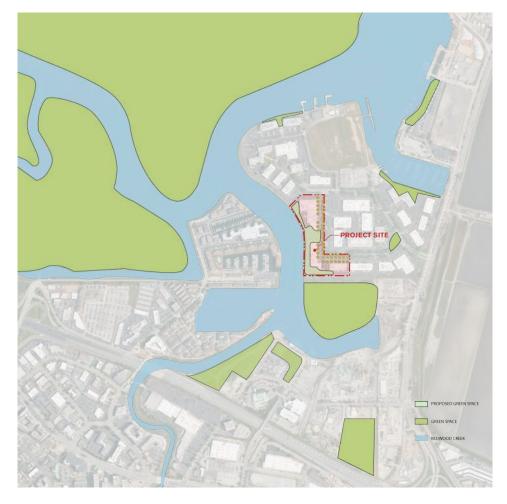

SITE GREEN SPACE AND WATERWAY

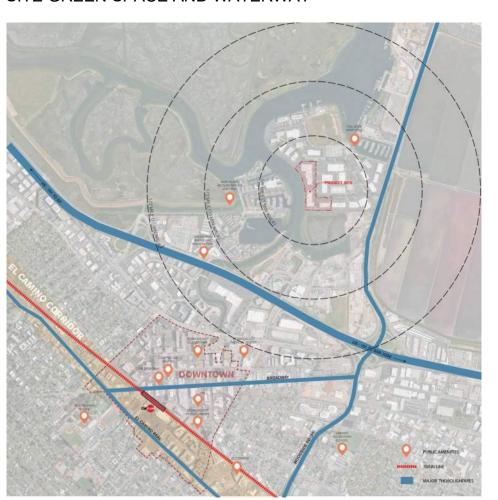

SITE VICINITY

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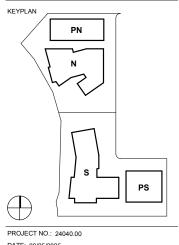
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505 PENOBSCOT PROJECT

505 Penobscot Dr, 301 Penobscot Dr and 701 Galveston Dr, Redwood City, CA 94063





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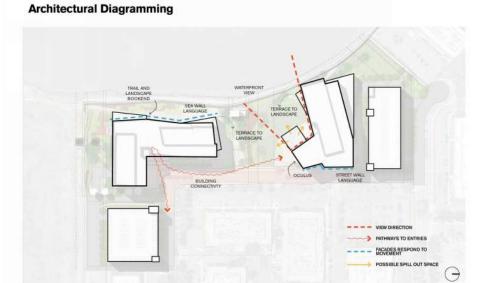
SHEET TITLE:

CONTEXT DIAGRAMS AND SITE ANALYSIS

SHEET NO:



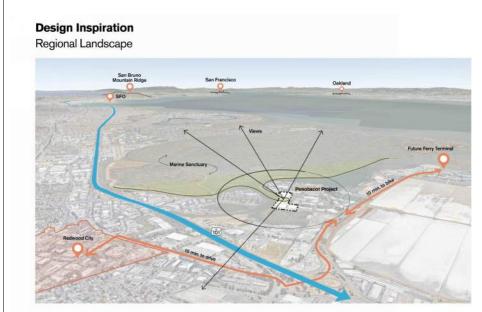

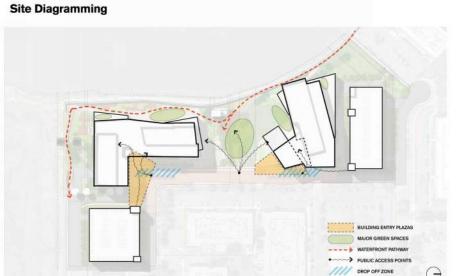

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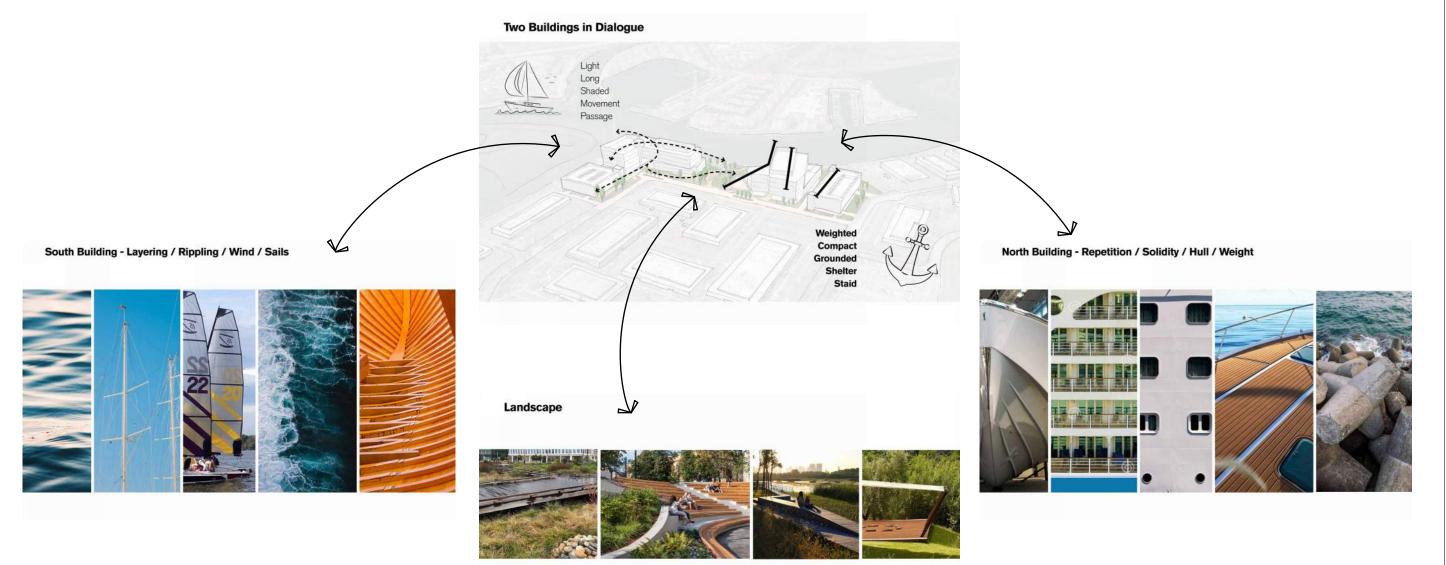
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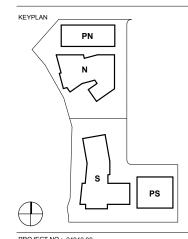
ISSUES	DATE
ENTITLEMENT APPLICATION	09/25/2025

REVISION LIST DATE



505 PENOBSCOT PROJECT

505 Penobscot Dr, 301 Penobscot Dr and 701 Galveston Dr, Redwood City, CA 94063




PROJECT NO.: 24040.00 DATE: 09/25/2025 SCALE:

SHEET TITLE:

PROJECT GOALS & CONCEPT DIAGRAMS

SHEET NO:

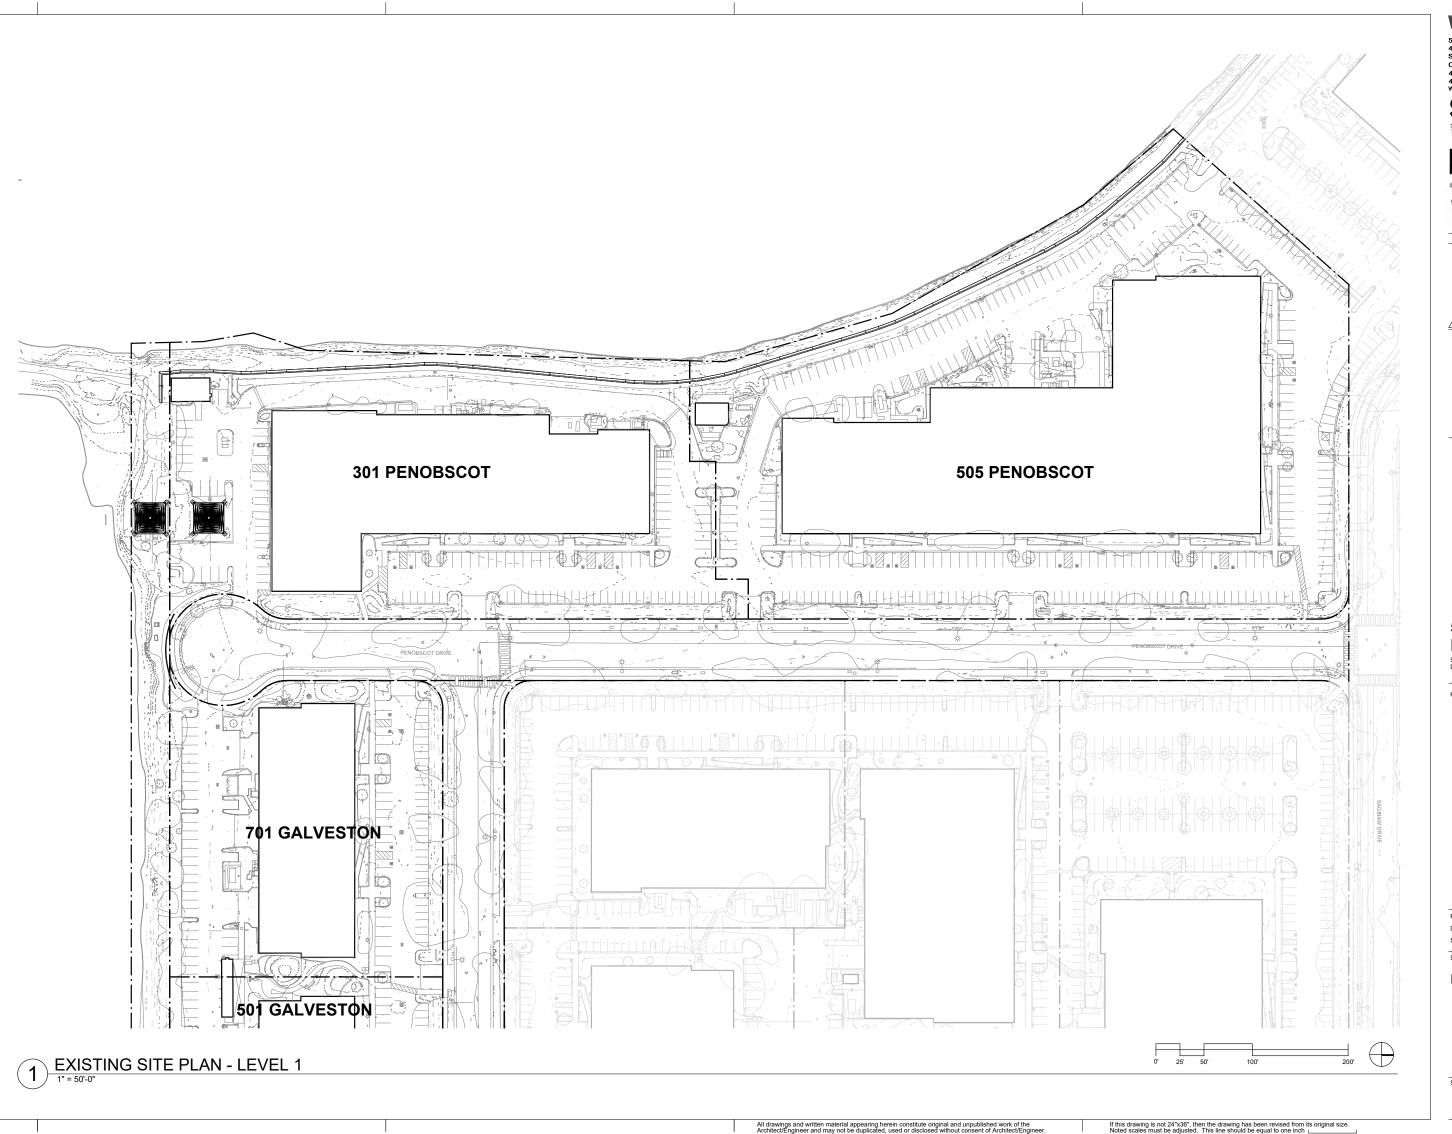

10/2/2025 5:20:50 PM

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ENTITLEMENT APPLICATION	09/25/2025

#	REVISION LIST	DATE
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505 PENOBSCOT PROJECT

505 Penobscot Dr, 301 Penobscot Dr and 701 Galvesto Dr, Redwood City, CA 94063

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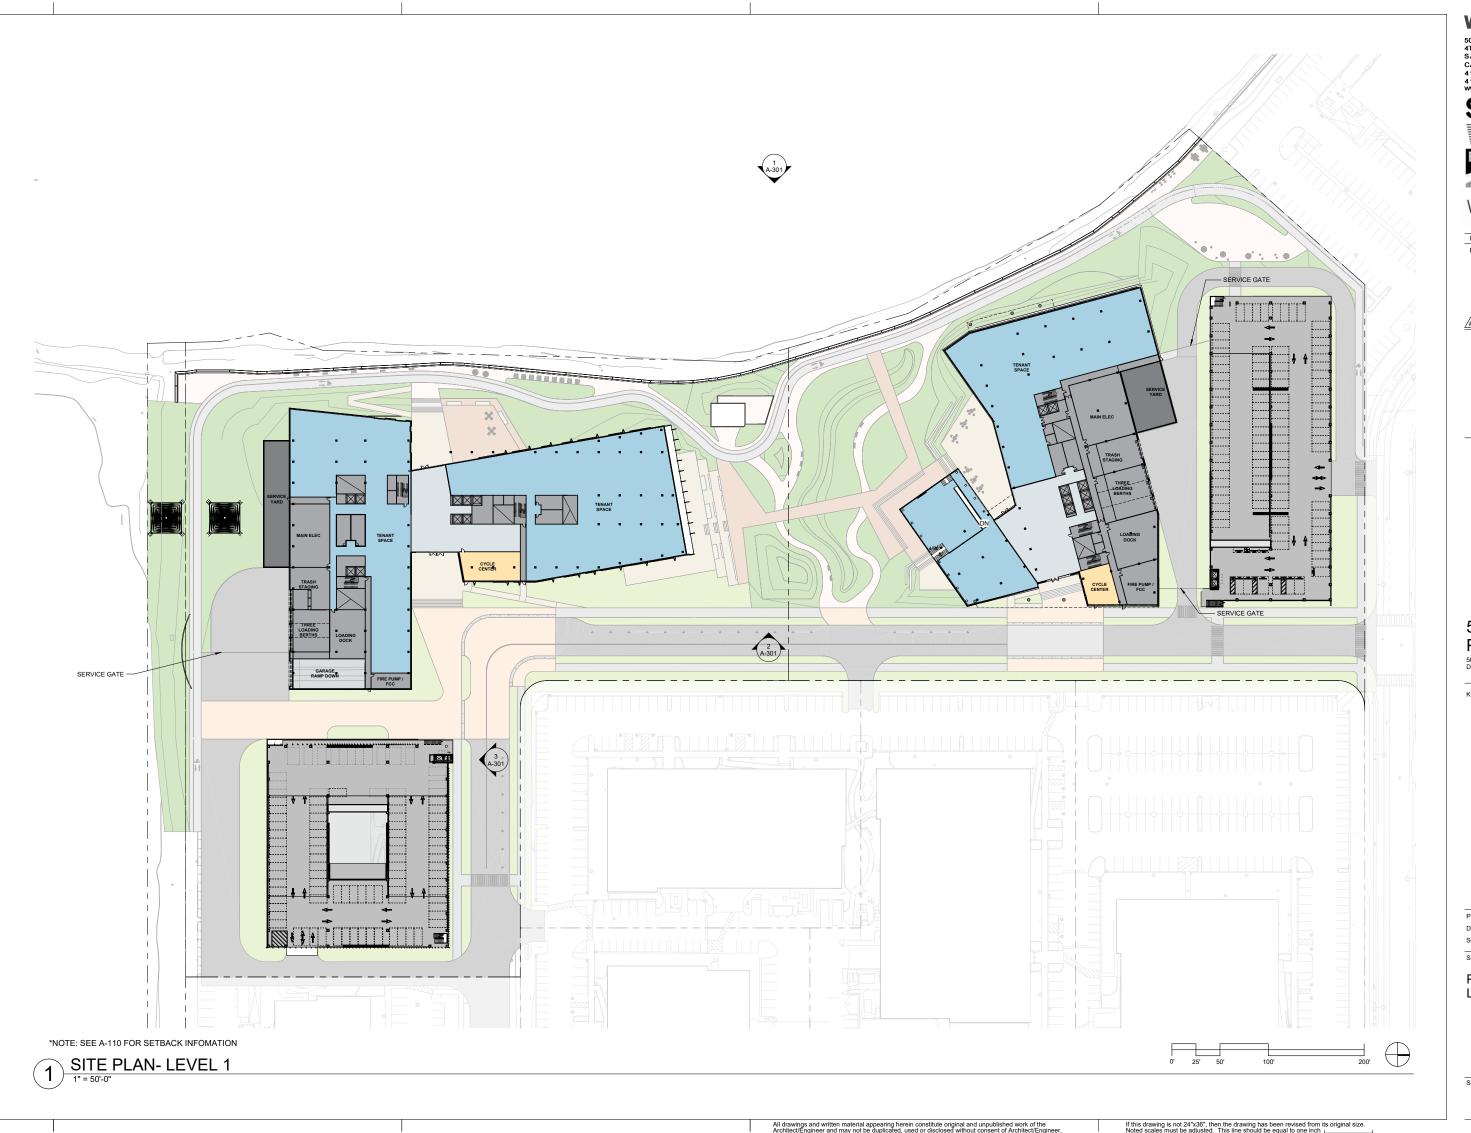
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SCALE: 1" = 50'-0"

SHEET TITLE:

EXISTING SITE PLAN

SHEET NO:



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ENTITI EMENT ADDITION	00/25/2025
ISSUES	DATE

REVISION LIST

505 PENOBSCOT PROJECT

505 Penobscot Dr, 301 Penobscot Dr and 701 Galvestor Dr, Redwood City, CA 94063

PROJECT NO.: 24040.00

SCALE: 1" = 50'-0"

SHEET TITLE:

PROPOSED SITE PLAN -LEVEL 1

SHEET NO:



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ISSUES	DATE
ENTITI EMENT ADDITION	00/25/2025

REVISION LIST DATE

505 PENOBSCOT PROJECT

505 Penobscot Dr, 301 Penobscot Dr and 701 Galveston Dr, Redwood City, CA 94063

VEVDI A

PROJECT NO.: 24040.00 DATE: 09/25/2025

SCALE: 1" = 50'-0"

SHEET TITLE:

PROPOSED SITE PLAN - ROOF


SHEET NO:

ZONING AND SETBACK NOTES

- 1. SETBACKS PER REDWOOD CITY ZONING CODE ARTICLE 16 CP (COMMERCIAL PARK)
- FRONT SETBACK (PER TBL 16-2): <u>25-0"</u>, FOR EVERY 1 FOOT THE BUILDING EXCEEDS 35 FEET IN
 HEIGHT, 1 ADDITIONAL FOOT OF FRONT YARD SHALL BE REQUIRED. MINIMUM FRONT YARDS SHALL
 BE PERMANENTLY LANDSCAPED.
- 3. SIDE SETBACK (PER TBL 16-2): 30'-0" COMBINED FOR BOTH SIDES, NO ONE SIDE SHALL HAVE A WIDTH OF LESS THAN 10 FEET. FOR EVERY 1 FOOT THE BUILDING EXCEEDS 35 FEET IN HEIGHT, 1 ADDITIONAL FOOT OF SIDE YARD SHALL BE REQUIRED ON BACH SIDE. SIDE YARDS ON THE STREET SIDE OF CORNER LOTS SHALL BE EQUAL IN DEPTH TO THE FRONT YARD REQUIREMENT SPECIFIED HEREIN, AND THE 10 FEET OF SUCH SIDE YARD ADJACENT TO THE STREET SHALL BE PERMANENTLY LANDSCAPED.
- 4. REAR SETBACK (PER TBL 16-2): <u>25-0*</u>, FOR EVERY 1 FOOT THE BUILDING EXCEEDS 35 FEET IN HEIGHT, 1 ADDITIONAL FOOT OF REAR YARD SHALL BE REQUIRED.
- MAXIMUM HEIGHT (PER TBL 16-2): 100'-0", BLD HEIGHT MEASURE FROM AVG. ADJACENT GRADE TO TOP OF STRUCTURAL DECK.
- 6. OUTDOOR YARDS PER RCZC 16.4.B.

10/2/2025 5:24:58 PM

ZONING HEIGHT MEASURED FROM AVERAGE EXISTING ADJACENT GRADE TO STRUCTURE. AVERAGE PROPOSED ADJACENT GRADE NOTED FOR REFERENCE AND SETBACK HEIGHT MEASUREMENT.

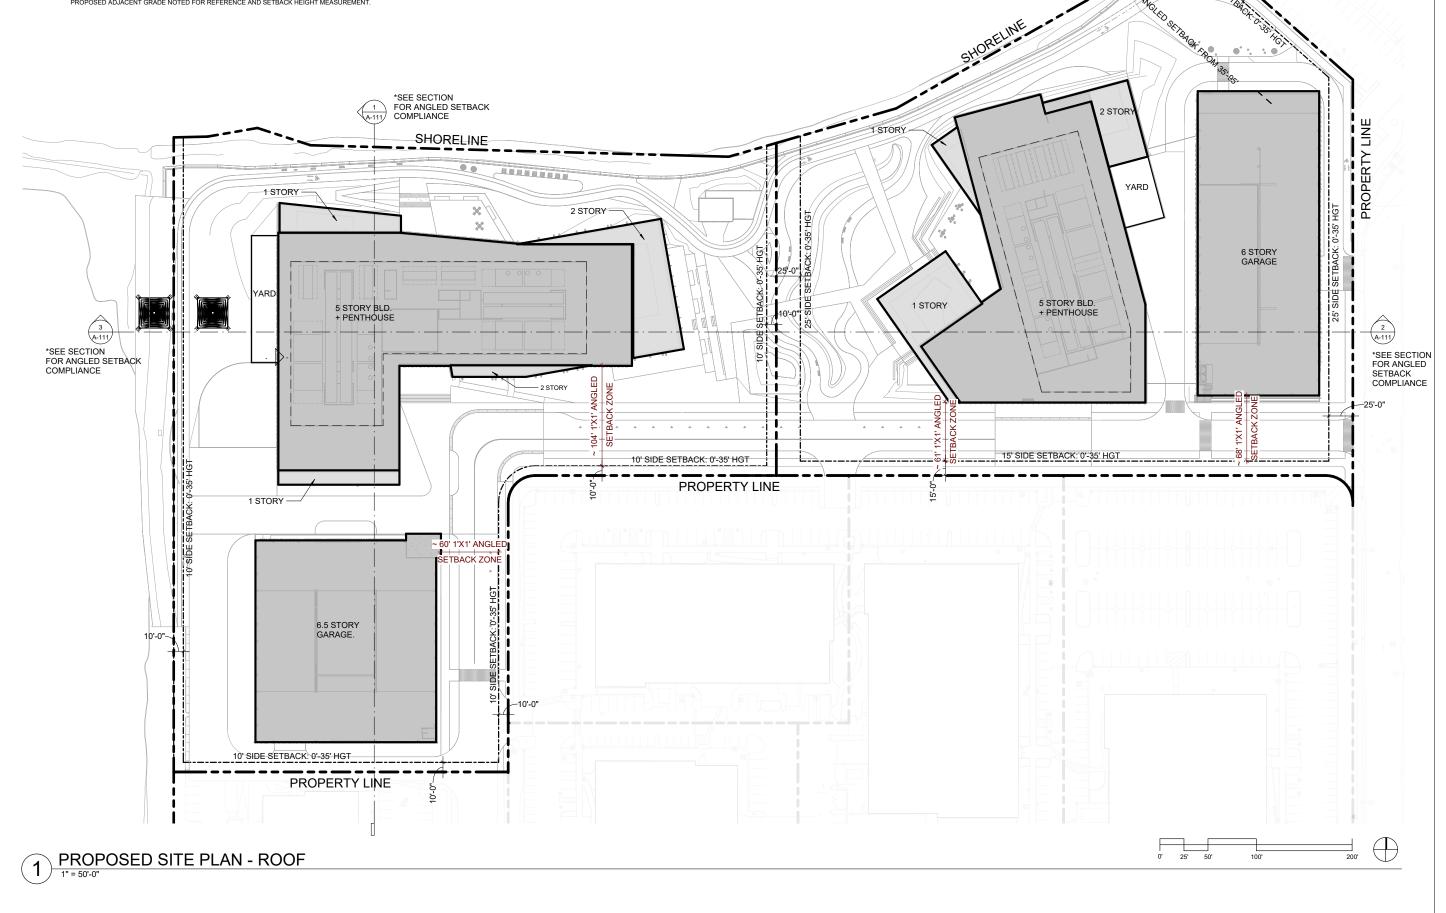

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ISSUES	DATE
ENTITLEMENT APPLICATION	09/25/2025

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505 PENOBSCOT PROJECT

505 Penobscot Dr, 301 Penobscot Dr and 701 Galves

KEADI V

PROJECT NO.: 24040.00 DATE: 09/25/2025


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SHEET TITLE:

PROPOSED SETBACKS PLAN

SHEET NO:


- 1. SETBACKS PER REDWOOD CITY ZONING CODE ARTICLE 16 CP (COMMERCIAL PARK)
- FRONT SETBACK (PER TBL 16-2): 25-0". FOR EVERY 1 FOOT THE BUILDING EXCEEDS 35 FEET IN HEIGHT, 1 ADDITIONAL FOOT OF FRONT YARD SHALL BE REQUIRED. MINIMUM FRONT YARDS SHALL BE PERMANENTLY LANDSCAPED.
- HEREIN, AND THE 10 FEET OF SUCH SIDE YARD ADJACENT TO THE STREET SHALL BE PERMANENTLY LANDSCAPED.
- 4. REAR SETBACK (PER TBL 16-2): <u>25-0"</u>. FOR EVERY 1 FOOT THE BUILDING EXCEEDS 35 FEET IN HEIGHT, 1 ADDITIONAL FOOT OF REAR YARD SHALL BE REQUIRED.
- 5. MAXIMUM HEIGHT (PER TBL 16-2): 100'-0", BLD HEIGHT MEASURE FROM AVG. ADJACENT GRADE TO TOP OF STRUCTURAL DECK.
- 6. OUTDOOR YARDS PER RCZC 16.4.B.
- ZONING HEIGHT MEASURED FROM AVERAGE EXISTING ADJACENT GRADE TO STRUCTURE. AVERAGE PROPOSED ADJACENT GRADE NOTED FOR REFERENCE AND SETBACK HEIGHT MEASUREMENT.



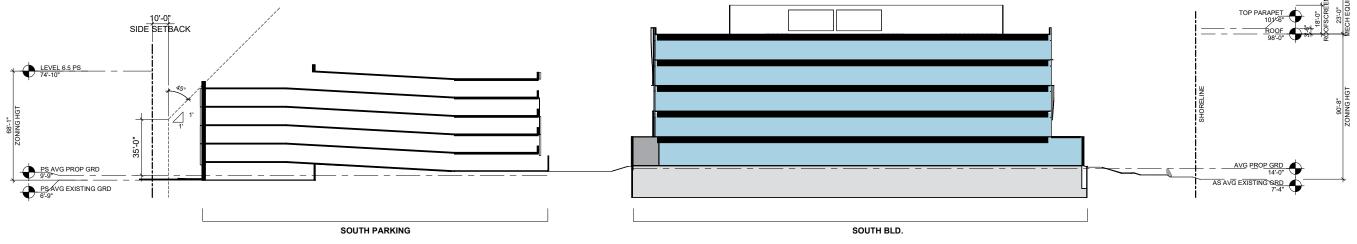





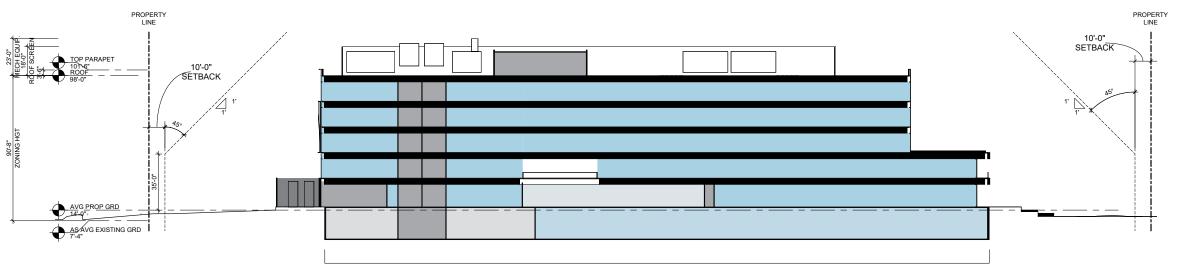

SETBACK SECTION SOUTH TO NORTH

SOUTH BLD.

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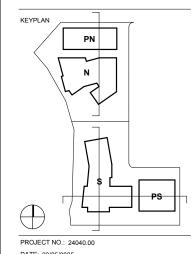


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ISSUES	DATE
ENTITLEMENT APPLICATION	09/25/2025

REVISION LIST DATE

505 PENOBSCOT PROJECT



DATE: 09/25/2025 SCALE: As indicated

SHEET TITLE:

PROPOSED SETBACKS SECTIONS

SHEET NO:

10/2/2025 9:27:01 AM

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ISSUES	DATE
ENTITI EMENT APPLICATION	09/25/2025

#	REVISION LIST	DATE
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505 PENOBSCOT PROJECT

505 Penobscot Dr, 301 Penobscot Dr and 701 Galveston Dr, Redwood City, CA 94063

KEYPL

PROJECT NO.: 24040.00 DATE: 09/25/2025 SCALE: 1" = 50'-0"

SHEET TITLE:

CONCEPTUAL FIRE ACCESS PLAN

SHEET NO:



1 CENTRAL GREEN SPACE AERIAL

10/2/2025 9:27:01 AM

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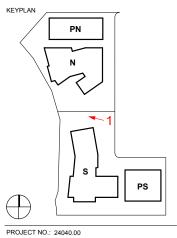
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ISSUES	DATE
ENTITI EMENT ADDITION	00/05/0005

REVISION LIST DATE

505 PENOBSCOT PROJECT

505 Penobscot Dr, 301 Penobscot Dr and 701 Galvestor Dr, Redwood City, CA 94063




PROJECT NO.: 24040 DATE: 09/25/2025 SCALE: 12" = 1'-0"

SHEET TITLE:

CONCEPTUAL RENDERINGS

SHEET NO:

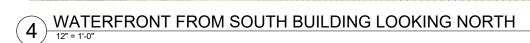



2 CENTRAL GREEN SPACE FROM PENOBSCOT



3 AERIAL VIEW LOOKING EAST



1) PENOBSCOT AT SOUTH BUILDING LOOKING NORTH

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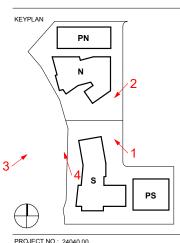
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ISSUES	DATE
ENTITI EMENT APPLICATION	09/25/2025

REVISION LIST DATE

505 PENOBSCOT PROJECT

505 Penobscot Dr, 301 Penobscot Dr and 701 Galve



PROJECT NO.: 24040.00 DATE: 09/25/2025 SCALE: 12" = 1'-0"

SHEET TITLE:

CONCEPTUAL RENDERINGS

SHEET NO:



REDWOOD CREEK ELEVATION
1" = 40'-0"



PENOBSCOT STREET ELEVATION

1" = 40'-0"



GALVESTON STREET ELEVATION

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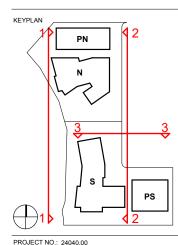
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REVISION LIST

505 PENOBSCOT PROJECT

505 Penobscot Dr, 301 Penobscot Dr and 701 Galvestor Dr, Redwood City, CA 94063



PROJECT NO.: 24040.00 SCALE: 1" = 40'-0"

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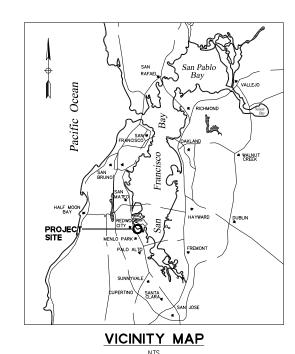
STREET ELEVATIONS

SHEET NO:

301, 505 PENOBSCOT DR AND 701 GALVESTON DR, REDWOOD CITY, CALIFORNIA

SHEET INDEX

OTTLE ! II TE	<u>'LA</u>
SHEET NO	DESCRIPTION
C-001	COVER SHEET
C-002	NOTES, LEGEND, ABBREVIATIONS
C-100	EXISTING CONDITIONS PLAN
C-200	PROPOSED DEMOLITION PLAN
C-300	EXISTING BOUNDARY PLAN (OVERALL)
C-301	PROPOSED BOUNDARY PLAN (OVERALL)
C-302	EXISTING BOUNDARY AND EASEMENTS PLAN (DETAILED)
C-303	PROPOSED BOUNDARY AND EASEMENTS PLAN (DETAILED)
C-400	PROPOSED SITE PLAN
C-401	CROSS SECTIONS
C-500	PROPOSED GRADING PLAN
C-600	PROPOSED UTILITY PLAN
C-700	PROPOSED STORMWATER MANAGEMENT PLAN
C-701	PROPOSED STORMWATER MANAGEMENT DATA AND DETAILS
C-702	BEST MANAGEMENT PRACTICES





LOCATION MAP

MAPPING STATEMENT

THIS PROJECT WILL BE A MERGER OF 6 PARCELS INTO 5 PARCELS. THE EXISTING PUBLIC RIGHT—OF—WAY EASEMENT ALONG PENOBSCOT DRIVE AND GALVESTON DRIVE WILL BE VACATED. THE EXISTING UNDERLYING PROPERTY IS PRIVATELY OWNED AND WOULD REMAIN IN THE SAME LOCATION AND CONFIGURATION, BUT WITH THE PROPOSE VACATION WOULD BE PRIVATELY MAINTAINED ROADWAY WITH A NEW PUBLIC ACCESS EASEMENT.

THE TOTAL NUMBER OF COMMERCIAL CONDOMINIUMS WILL NOT EXCEED 10 UNITS. PURSUANT TO COMMERCIAL AND INDUSTRIAL COMMON INTEREST DEVELOPMENT ACT (CICID ACT), CALIFORNIA CIVIL CODE SECTIONS 6500-6876.

BENCHMARK STATEMENT

CITY OF REDWOOD CITY BENCHMARK SYSTEM.

BENCHMARK NO. 64 - ELEVATION = 6.82 FEET (NAVD 88 \pm 0.1')

RECORD OF SURVEY 1911-A, FILED FOR RECORD ON NOVEMBER 19, 2008, IN VOLUME 32 OF L.L.S. MAPS AT PAGES 50-52.

THE ELEVATIONS SHOWN WERE DERIVED FROM GPS RTK OBSERVATIONS, ADJUSTED TO THE CITY OF REDWOOD CITY BENCHMARK SYSTEM PER THE ABOVE LISTED BENCH

THE BEARING OF NORTH 01'03'51" EAST ALONG THE CENTERLINE OF PENOBSCOT DRIVE BETWEEN THOSE TWO FOUND MONUMENTS INTERSECTING AT CALVESTON DRIVE AND SAGINAW DRIVE AS SHOWN ON THAT MAP RECORDED IN BOOK 112 OF MAPS AT PAGES 04-06 AND FILED FOR RECORD ON AUGUST 31, 1984 IN THE OFFICE OF THE RECORDER OF SAN MATEO COUNTY.


SOURCE OF SURVEY

SITE BOUNDARY LINES, EASEMENTS, OBJECTS SHOWN HEREON ARE BASED ON A SURVEY PERFORMED BY BKF ENGINEERS, DATED 06/02/2023, REFER TO SURVEY DOCUMENT FOR FULL DETAIL.

THE AERIAL MAPPING WAS PREPARED USING COMPUTER ASSISTED, PHOTOGRAMMETRIC METHODS BY VERTICAL MAPPING RESOURSES, IN MESA, ARIZONA. JOB NUMBER 20-3147. IN AREAS OF DENSE VEGETATION, ACCURACY OF CONTOURS MAY DEVIATE FROM ACCEPTED ACCURACY STANDARDS. DATE OF PHOTOGRAPHY ON 10/09/2020, ORIGINAL COMPILED MAP SCALE 1"=20', CONTOUR INTERVAL 1 FOOT.

THE SUBJECT PROPERTY IS SHOWN ON THE FEDERAL EMERGENCY MANAGEMENT AGENCY (FEMA) FLOOD INSURANCE RATE MAP (FIRM) NO. LOMR 23-09-0500P FOR COMMUNITY NUMBER 060325 (CITY OF REDWOOD CITY), WITH EFFECTIVE DATE OCTOBER 2, 2024, AS BEING LOCATED IN FLOOD ZONE "X":

ACCORDING TO FEMA, THE DEFINITION OF ZONE "X" IS: AREAS DETERMINED TO BE OUTSIDE THE 0.2% ANNUAL CHANCE FLOODPLAIN.

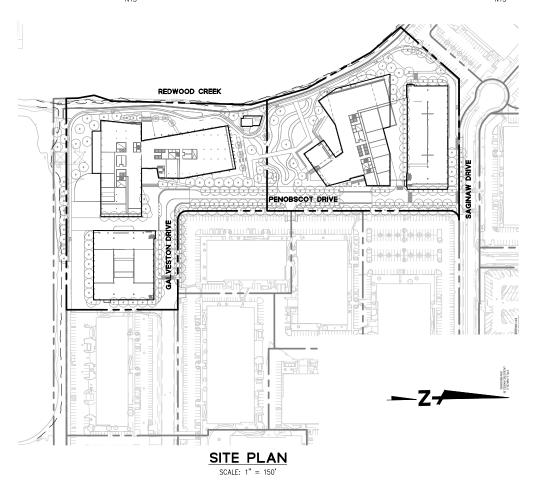

PROJECT DATA

505 PENOBSCOT DRIVE RWC, LLC 425 MARKET STREET STE 1050 SAN FRANCISCO, CA 94105 APPLICANT:

(415)-489-2224

PROJECT MANAGEMENT ADVISORS, INC. OWNER'S REPRESENTATIVE: 1 TOWERS PLACE, SUITE 200 SOUTH SAN FRANCISCO, CA 94080

(650)-491-8800

ARCHITECT:

(415) 489-2224

BKF ENGINEERS CIVIL ENGINEER:

255 SHORELINE DRIVE, SUITE 200 REDWOOD CITY, CA 94065 CONTACT: JAMES DALLOSTA, P.E. (650) 482–6300

054-320-260, 054-320-250, 054-320-160, 054-320-080, 054-320-090

EXISTING LAND USE: OFFICE/LIFE SCIENCE OFFICE/LIFE SCIENCE PROPOSED LAND USE: CP - COMMERCIAL PARK EXISTING ZONING:

SITE ADDRESS: 301 505 PENORSCOT DR AND 701 GALVESTON DR, REDWOOD CITY, CA

CP - COMMERCIAL PARK

SITE AREA:

PROPOSED ZONING:

APN:

LIST OF UTILITIES & PROVIDERS:
SEWAGE DISPOSAL: CITY OF REDWOOD CITY
STORM DRAIN: CITY OF REDWOOD CITY
WATER SUPPLY: CITY OF REDWOOD CITY

REDWOOD CITY FIRE DEPARTMENT GAS & FLECTRIC PACIFIC GAS AND ELECTRIC COMPANY

CABLECOM

ENGINEER'S STATEMENT

THIS VESTING TENTATIVE PARCEL MAP HAS BEEN PREPARED BY ME OR UNDER MY DIRECTION IN ACCORDANCE WITH STANDARD ENGINEERING PRACTICE.

JAMES DALLOSTA, PE PRINCIPAL/VICE PRESIDENT P.E. #72339 EXP 06/30/26 BKF FNGINFERS

ENGINEER'S STATEMENT

THIS VESTING TENTATIVE PARCEL MAP HAS BEEN PREPARED BY ME OR UNDER MY DIRECTION IN ACCORDANCE WITH STANDARD ENGINEERING PRACTICE.

PATRICK C. CONNORS, PE PROJECT MANAGER P.E. #85260 EXP 12/31/26 BKE ENGINEERS

DATE

DATE

C-001

WRNSSTUDIO

WATRY DESIGN, INC.

10/03/2025

DATE

CALIFORNIA 94107 415, 489, 2224 TEL 415.358.9100 FAX

swa

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ISSUES

WATT

REVISION LIST

ENTITLEMENT APPLICATION

505 PENOBSCOT

505 Penobscot Dr, 301 Penobscot Dr and 701 Galvesto Dr, Redwood City, CA 94063

PROJECT

PROJECT NO.: 24040.00

COVER SHEET

SHEET TITLE

GENERAL NOTES

- TENTATIVE MAP: THIS VESTING TENTATIVE PARCEL MAP IS BEING FILED IN ACCORDANCE WITH CHAPTER 3, ARTICLE 2, SECTION 66452, CHAPTER 4.5, AND SECTION 66426(C) OF THE SUBDIVISION MAP ACT.
- 2. FINAL MAP: THE APPLICANT RESERVES THE RIGHT TO FILE MULTIPLE FINAL MAPS FOR THIS PROJECT.
- 3. BOUNDARY: BOUNDARY INFORMATION IS BASED ON SURVEY DATA PREPARED BY BKF.
- 4. RECORD INFORMATION: RECORD OWNERSHIP AND EASEMENT INFORMATION WAS TAKEN FROM:
- A) THE PRELIMINARY TITLE REPORT ISSUED BY FIRST AMERICAN TITLE COMPANY, #NCS-1156461-CHI2, DATED SEPTEMBER 11, 2024.
 B) THE PRELIMINARY TITLE REPORT ISSUED BY CHICAGO TTILE COMPANY, #60604766-606-TEO-JM, DATED MAY 30, 2023.
- GRADING: SITE GRADES AND BUILDING / GARAGE FINISHED FLOOR ELEVATIONS ARE SUBJECT TO FINAL ENGINEERING DESIGN AND GEOTECHNICAL ENGINEER'S REVIEW AND APPROVAL.
- 6. <u>UTILITIES:</u> UTILITY SIZING, LOCATIONS, AND GRADES ARE SUBJECT TO FINAL ENGINEERING DESIGN, GEOTECHNICAL ENGINEERING AND RESPECTIVE UTILITY AGENCY REVIEW AND APPROVAL.
- A. EXISTING UTILITIES SHOWN ARE FROM FIELD OBSERVATION AND RECORD DRAWINGS AND ARE NOT MEANT TO BE A FULL CATALOG OF ACTUAL CONDITIONS.
- B. EXISTING ON—SITE UTILITIES SHOWN ARE TO BE REMOVED UNLESS OTHERWISE NOTED ON THE PLANS.
- C. THE WATER DISTRIBUTION SYSTEM WILL BE DESIGNED AND CONSTRUCTED PER REDWOOD CITY STANDARD SPECIFICATIONS & DETAILS, WHERE APPLICABLE.
- D. THE SANITARY SEWER SYSTEM WILL BE DESIGNED AND CONSTRUCTED PER REDWOOD CITY STANDARD SPECIFICATIONS AND DETAILS, WHERE APPLICABLE.
- E. THE STORM DRAIN SYSTEM WILL BE DESIGNED AND CONSTRUCTED PER REDWOOD CITY STANDARD SPECIFICATIONS AND DETAILS, WHERE APPLICABLE.
- E. THE RECYCLED WATER DISTRIBUTION SYSTEM WILL BE DESIGNED AND CONSTRUCTED PER REDWOOD CITY STANDARD SPECIFICATION & DETAILS (ATTACHMENT U RWC RECYCLED WATER DEVELOPMENT STANDARDS) AND ALL APPLICABLE REGULATIONS.

LEGEND

	PROPOSED	EXISTING
PROPERTY LINE		
ADJACENT PROPERTY LINE		
CENTERLINE		
EASEMENT LINE		
STORM DRAIN LINE	18"SD	SD
SANITARY SEWER LINE	6"SS>	ss
WATER LINE	4"W>	w
FIRE SERVICE LINE	FS	
RECYCLED WATER	PR RW	RW
GAS LINE		— с — с —
OVERHEAD LINE		OHE
COMMUNICATION LINE		
TELEPHONE	т	т
ELECTRICAL	———Е———	——Е
JOINT TRENCH	(PR JT)	
SANITARY SEWER MANHOLE	lacksquare	\circ
STORM DRAIN MANHOLE		©
TELEPHONE MANHOLE		©
FIRE HYDRANT	•	**
FIRE DEPARTMENT CONNECTION	₹`	R
BLOW OFF VALVE	•	•
STORM DRAIN INLET		
SPOT ELEVATION	×101	×101
TRANSFORMER		
ELECTRICAL BOX		E
GAS BOX		G
WATER METER		\square
IRRIGATION METER		IRR
BUILDING LINE		711111111111111111111111111111111111111
FENCE AS NOTED		xxx
ELECTROLIER	\$	
TRAFFIC SIGNAL	¤	0
PARKING METER	0 PM#1	PM ®
STREET LIGHT		\$ \$
TREE (AS NOTED)		
SIGN AS NOTED		
FOUND MONUMENT AS NOTED		•
BACK FLOW PREVENTER		
BOLLARD		\otimes
POWER LINE POLE		PP -0-

WATER VALVE

ABBREVIATIONS:

AC APN	ASPHALT CONCRETE ASSESSOR'S PARCEL NUMBER
BLDG BC	BUILDING BOTTOM OF CURB
3W	DACK OF WALK BOTTOM OF WAL
EDGE	CONCRETE EDGE
- ONC	CENTERLINE CONCRETE
W	DOMESTIC WATER
	EAST
EG FX	EXISTING GRADE EXISTING
FDC	FIRE DEPARTMENT CONNECTION
F	FINISHED FLOOR
⁻G ⁻H	FINISHED GRADE FIRE HYDRANT
-L	FLOW LINE
FS FW	FINISHED SURFACE
rw GR	FIRE WATER GRATE
HP	HIGH POINT
INV JT	INVERT JOINT TRENCH
_G	LIP OF GUTTER
LOW	LIMIT OF WORK
LP N	LOW POINT NORTH
NE	NORTHEAST
1M	NORTHWEST
O.R. PIV	OFFICIAL RECORD POST INDICATOR VALVE
PL	PROPERTY LINE
PM PR	PARCEL MAP PROPOSED
DTD	PRELIMINARY TITLE REPORT
P.U.E. RIM	PUBLIC UTILITY EASEMENT
RW	RIM ELEVATION RECYCLED WATER
S	SOUTH
SD SDDI	STORM DRAIN STORM DRAIN DRAIN INLET
SDMH	STORM DRAIN MANHOLE
SE SLP	SOUTHEAST
SS	SEE LANDSCAPE PLANS SANITARY SEWER
SSMH	SANITARY SEWER SANITARY SEWER MANHOLE
SW TC	SOUTHWEST TOP OF CURB
TW	TOP OF WALL
TYP	TYPICAL
W WM	WEST, WATER WATER METER
W∨	WATER VALVE

WRNSSTUDIO

501 SECOND STREET 4TH FLOOR, STE. 402 S AN FRANCISCO CALIFORNIA 94107 415. 489.2224 TEL 415.358.9100 FAX WWW.WRNSSTUDIO.COM

SWA WATRY DESIGN, INC.



WATT

ISSUES	DATE
ENTITLEMENT APPLICATION	10/03/2025

#	REVISION LIST	

DATE

505 PENOBSCOT PROJECT

505 Penobscot Dr, 301 Penobscot Dr and 701 Galveston Dr, Redwood City, CA 94063

PROJECT NO.: 24040.00 DATE: 10/03/2025 SCALE:


SHEET TITLE:

NOTES, LEGEND, ABBREVIATIONS

SHEET NO:

C-002

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ISSUES	DATE
ENTITI EMENT ADDITION	10/00/0005
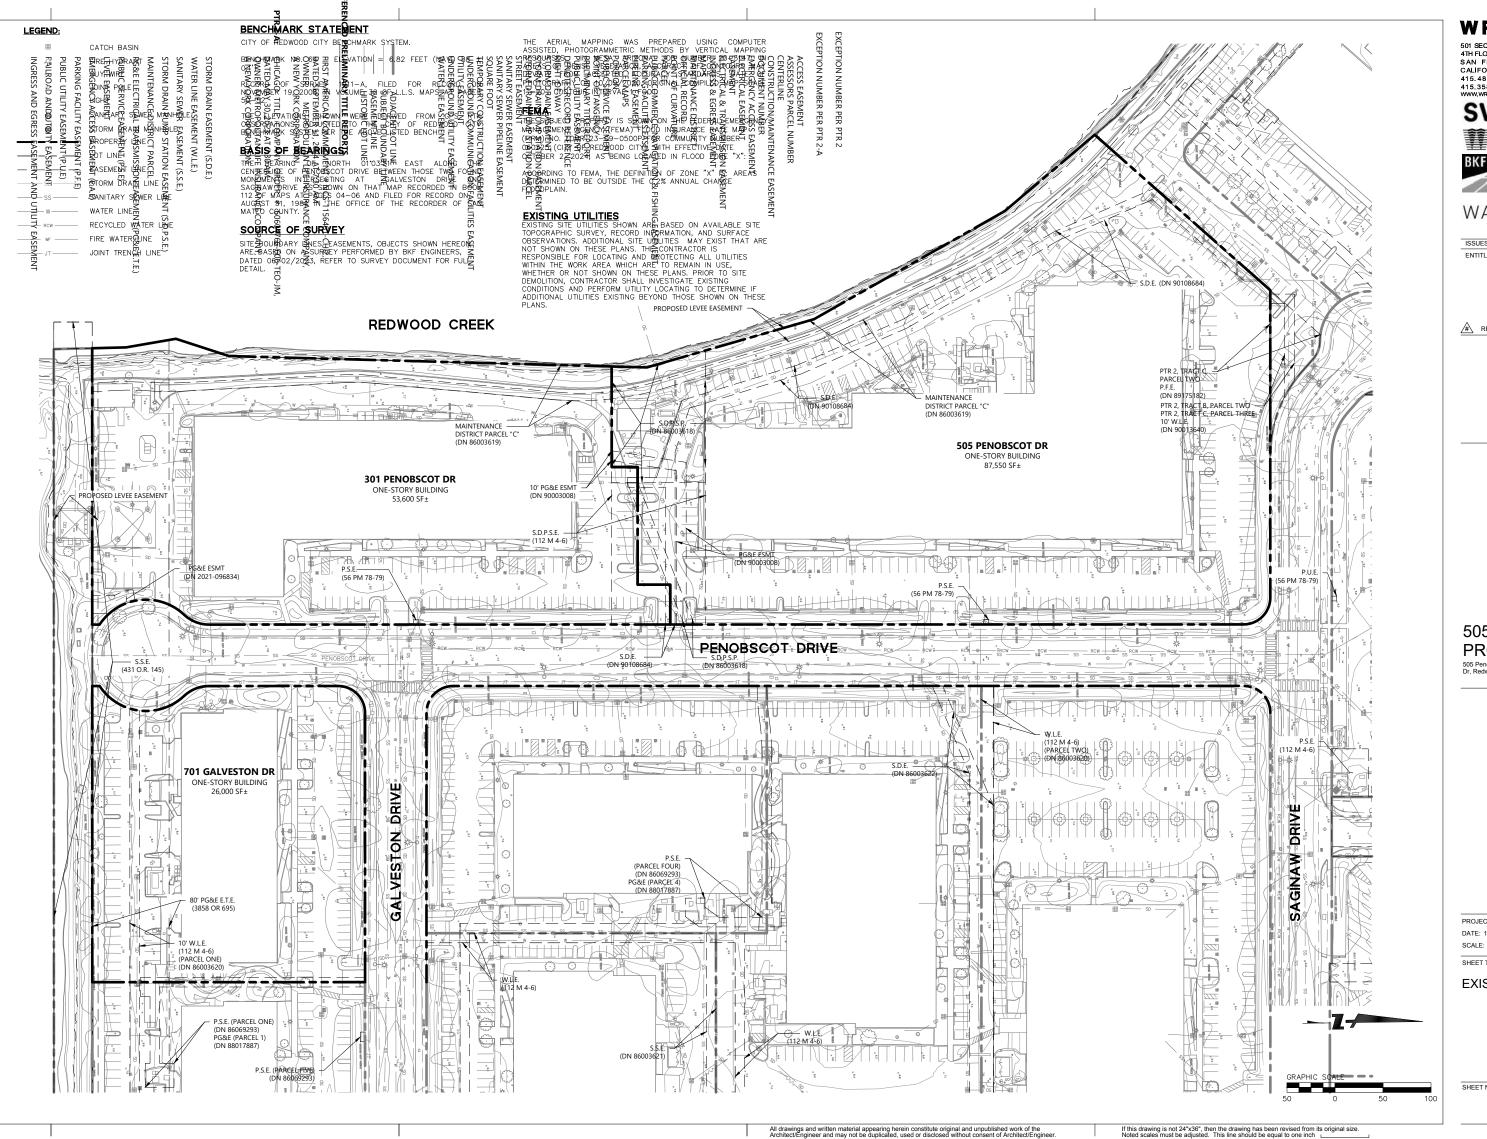
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505 PENOBSCOT PROJECT


505 Penobscot Dr, 301 Penobscot Dr and 701 Galvest Dr, Redwood City, CA 94063


PROJECT NO.: 24040.00

SHEET TITLE:

EXISTING CONDITIONS PLAN

SHEET NO:

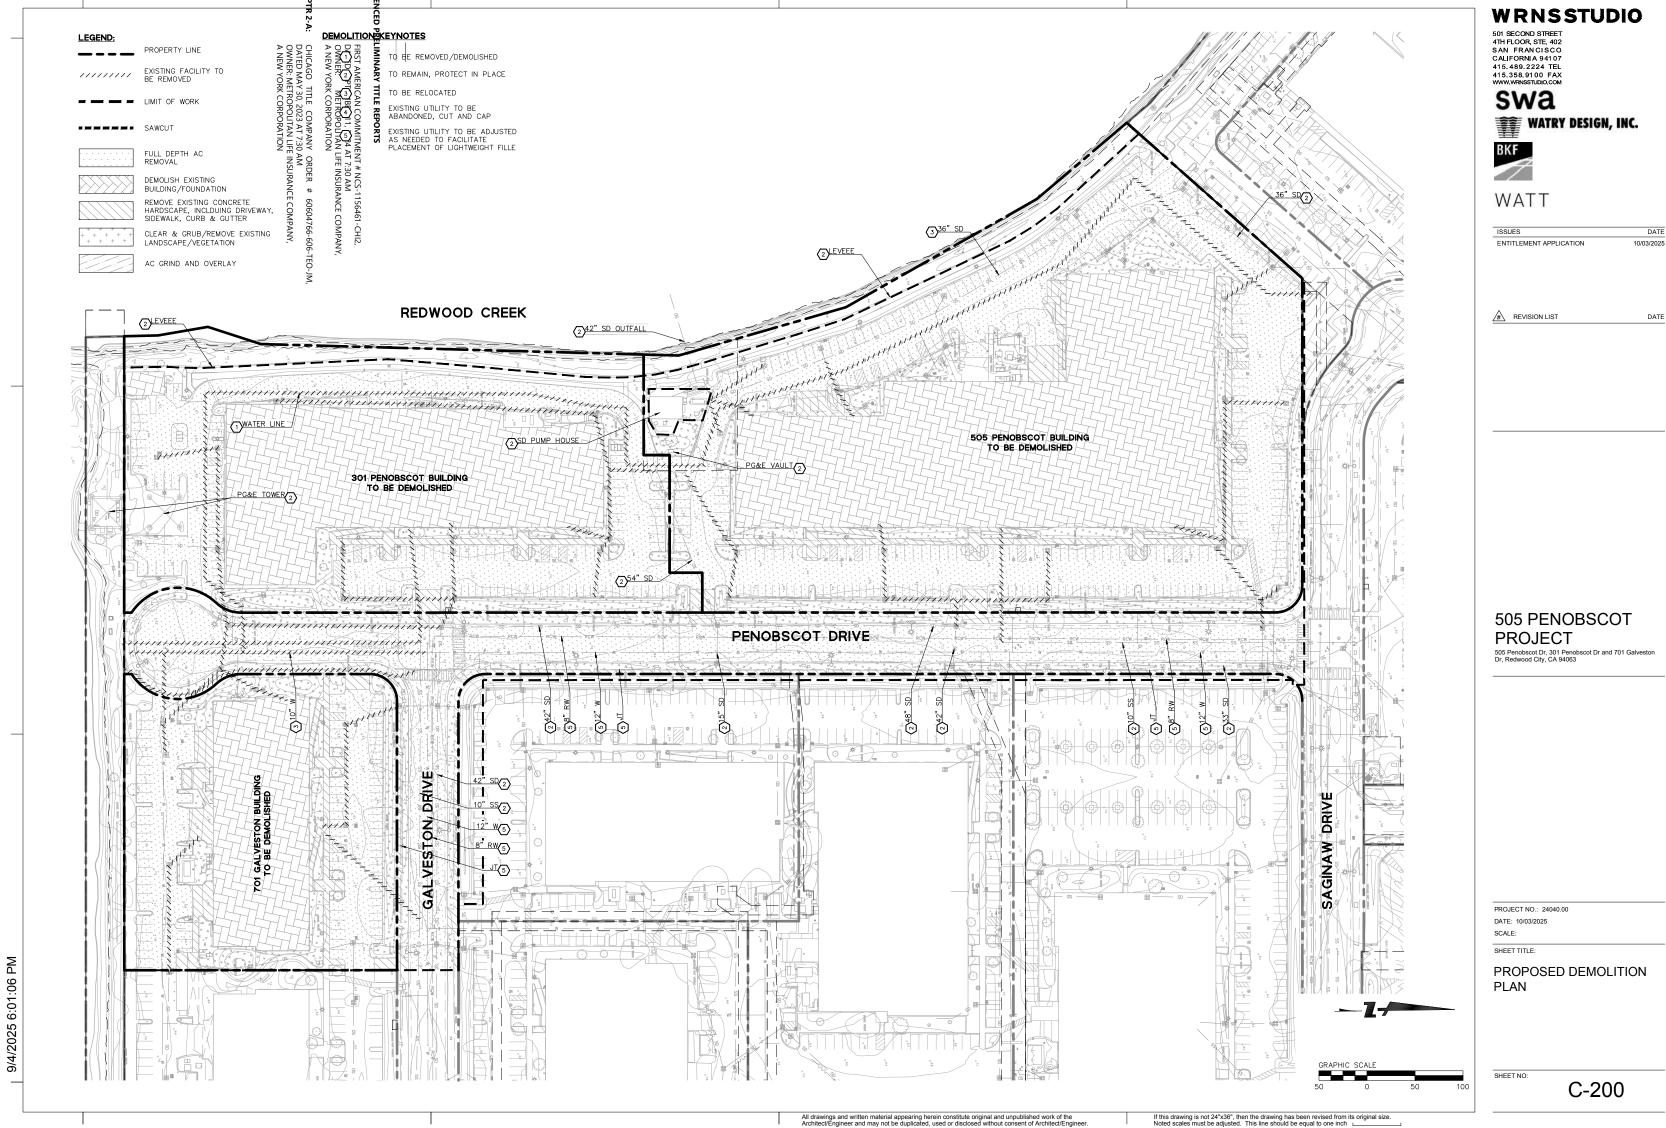

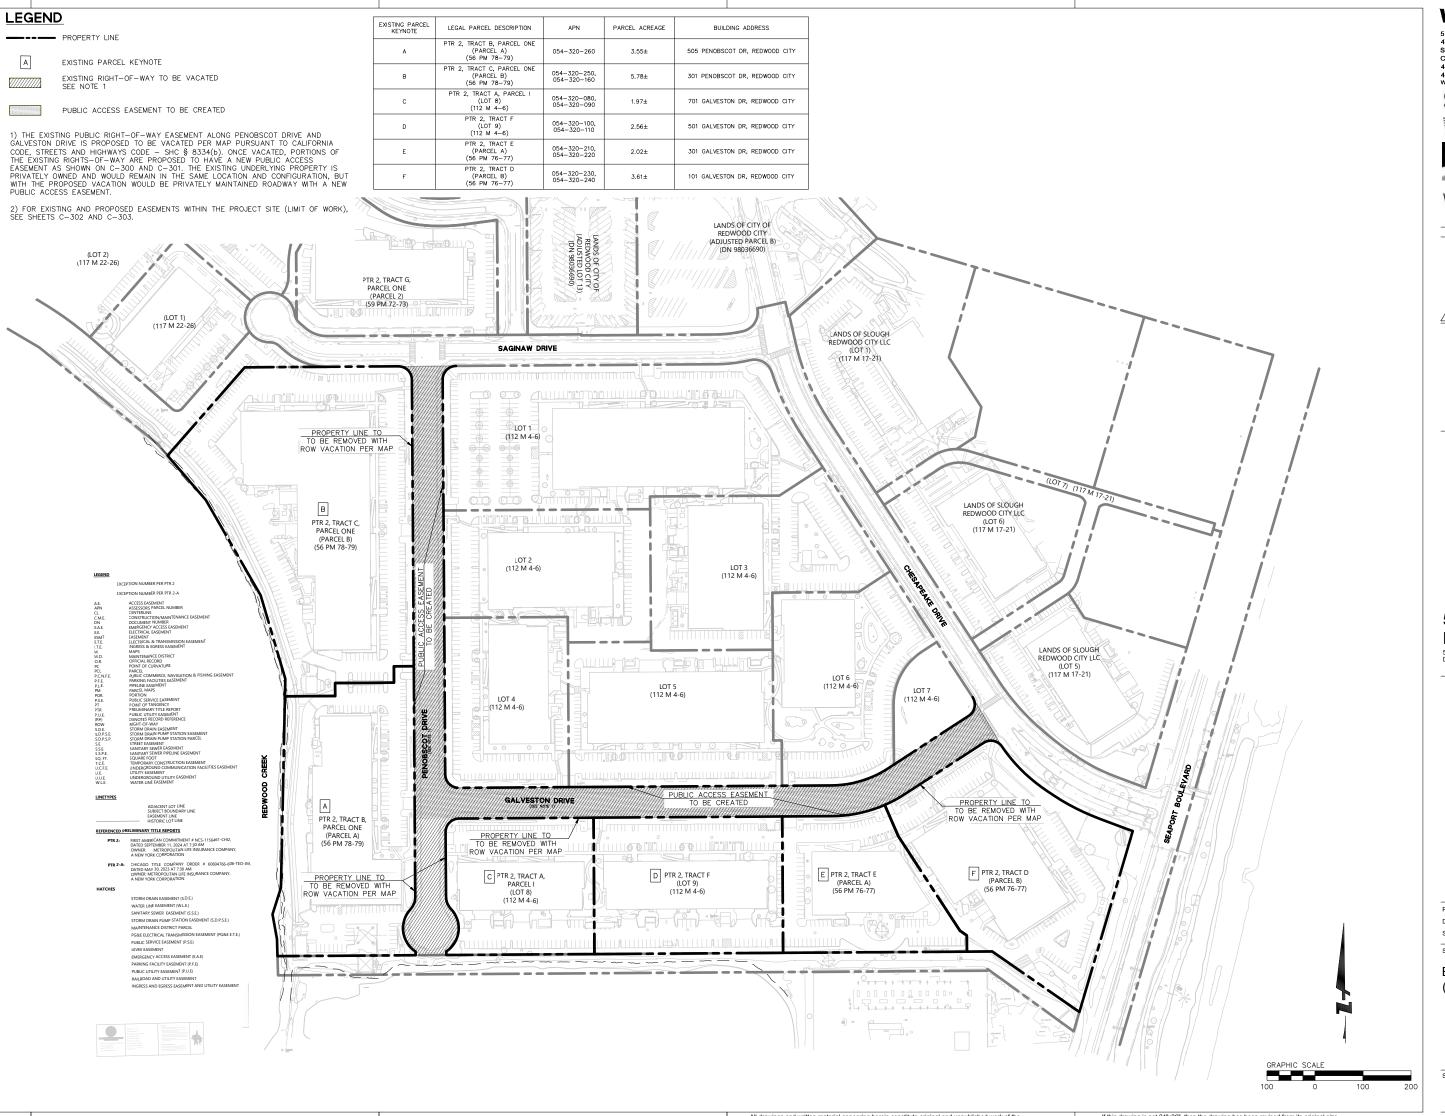

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ISSUES	DATE
ENTITLEMENT APPLICATION	10/03/2025

REVISION LIST

DATE

505 PENOBSCOT PROJECT

505 Penobscot Dr, 301 Penobscot Dr and 701 Galveston Dr, Redwood City, CA 94063


PROJECT NO.: 24040.00 DATE: 10/03/2025

SCALE:

SHEET TITLE:

EXISTING BOUNDARY PLAN (OVERALL)

SHEET NO:

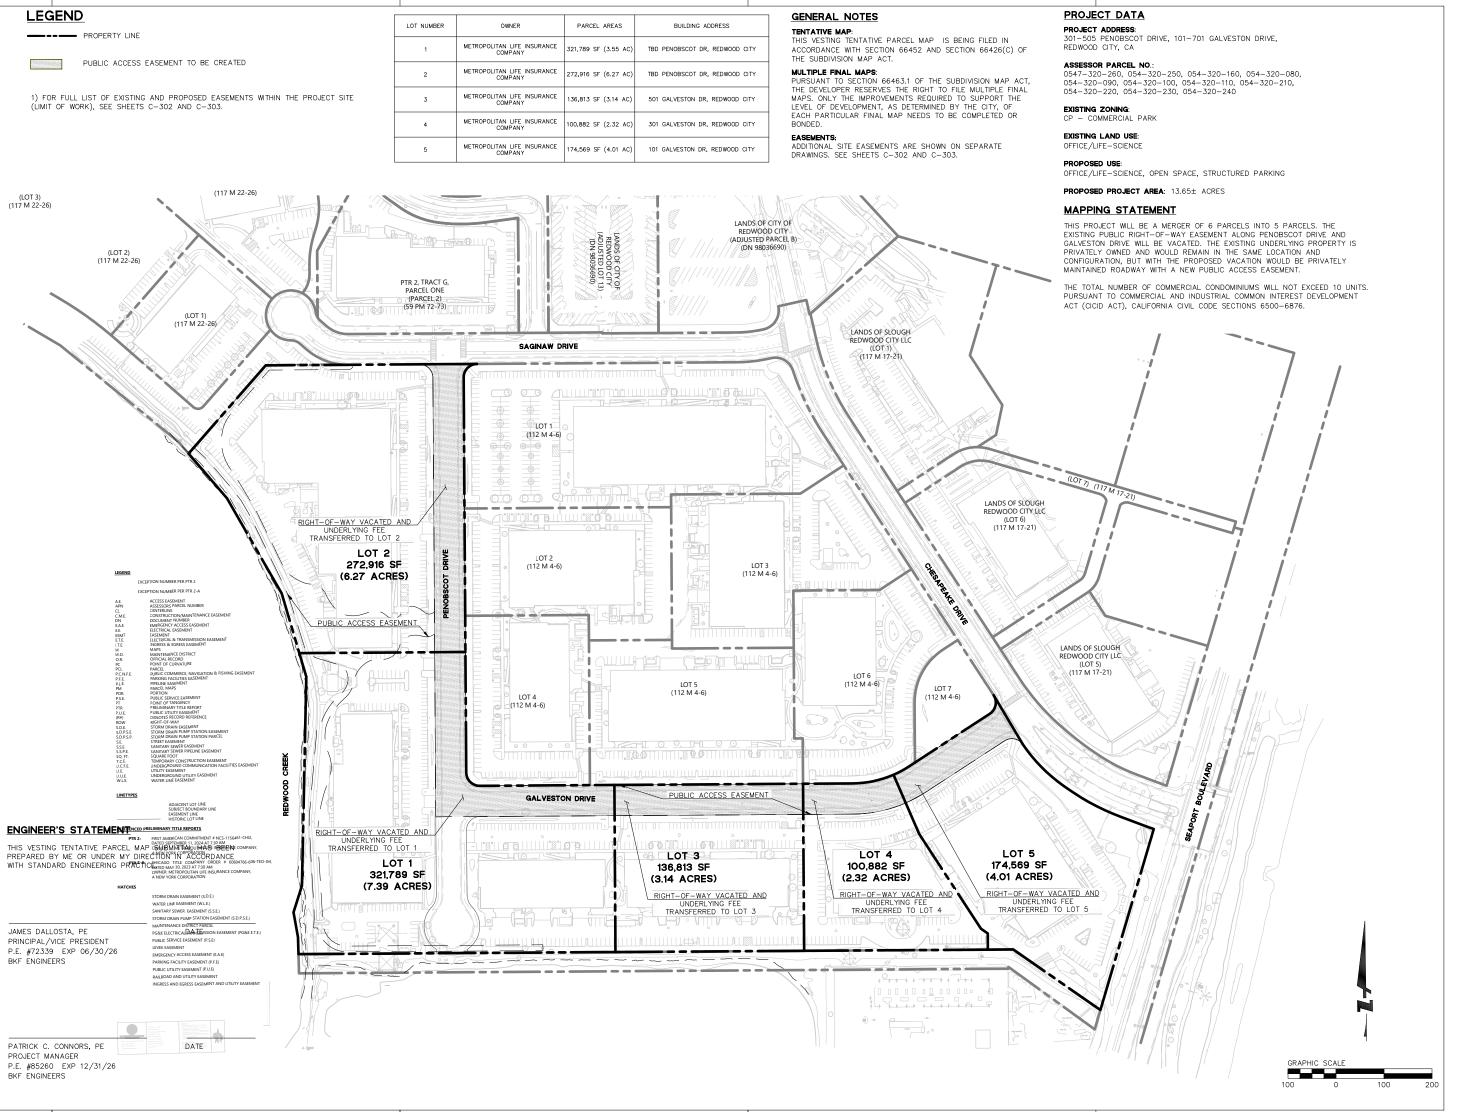

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ISSUES	DATE
ENTITLEMENT APPLICATION	10/03/2025

REVISION LIST DATE

505 PENOBSCOT PROJECT


505 Penobscot Dr, 301 Penobscot Dr and 701 Galveston Dr, Redwood City, CA 94063

PROJECT NO.: 24040.00 SCALE:

SHEET TITLE:

PROPOSED BOUNDARY PLAN (OVERALL)

SHEET NO:

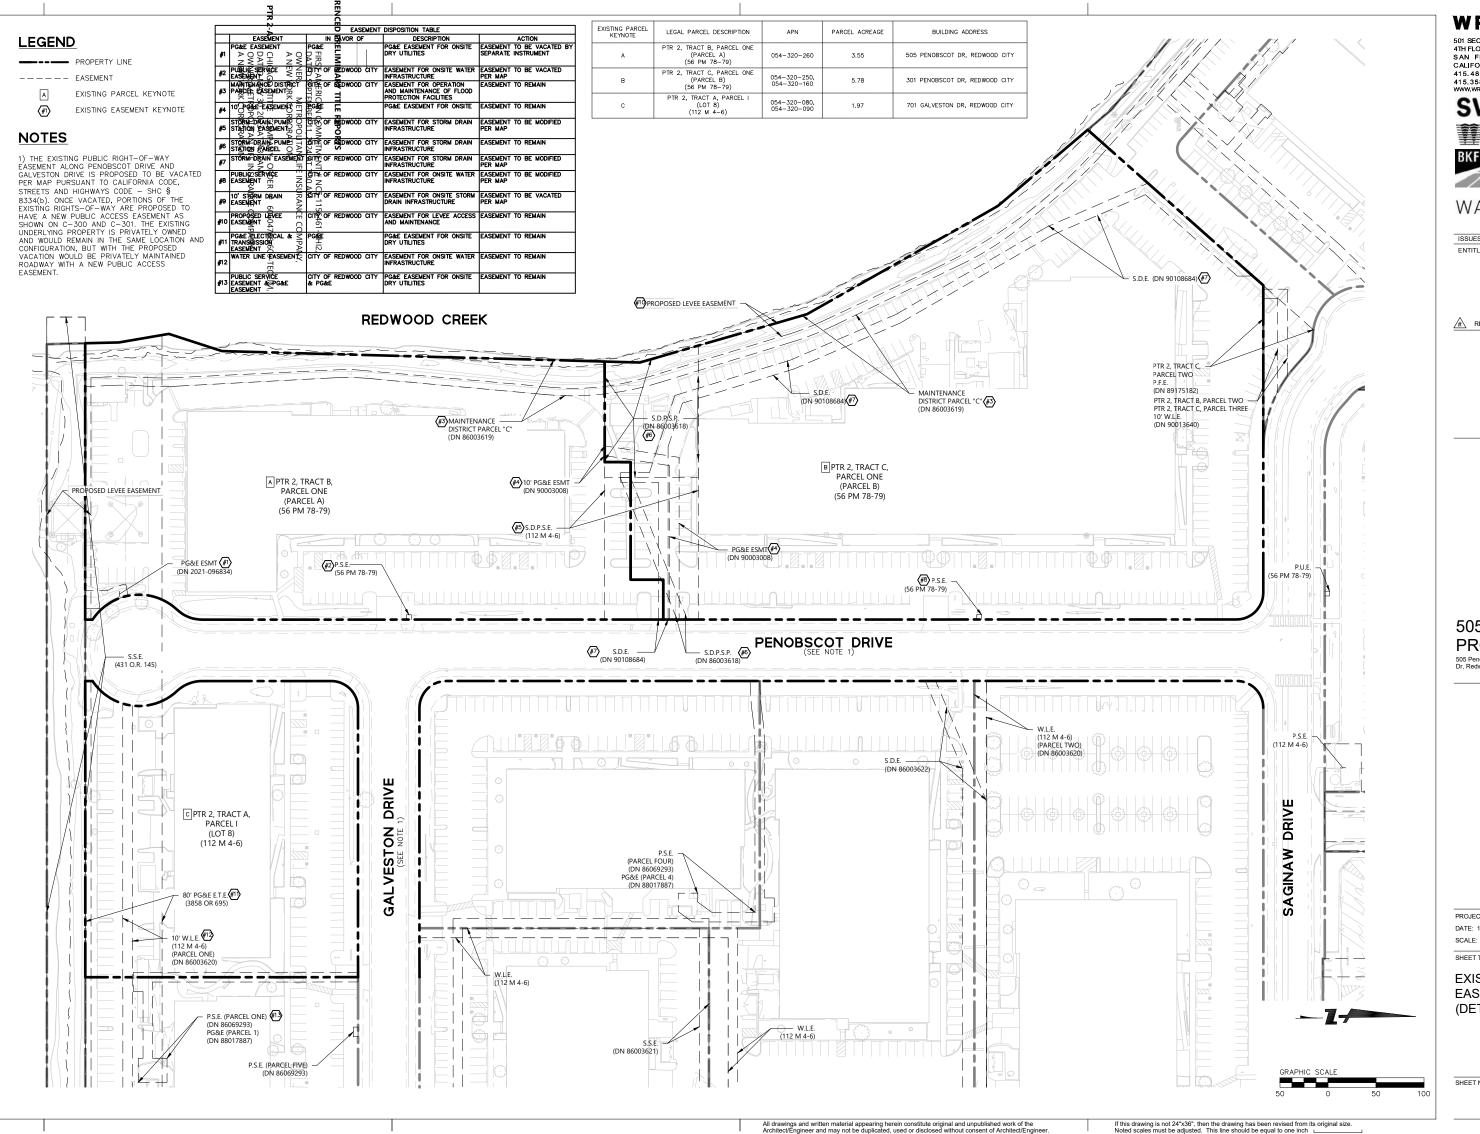

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ISSUES	DATE
ENTITI EMENT ADDITION	40/02/0005

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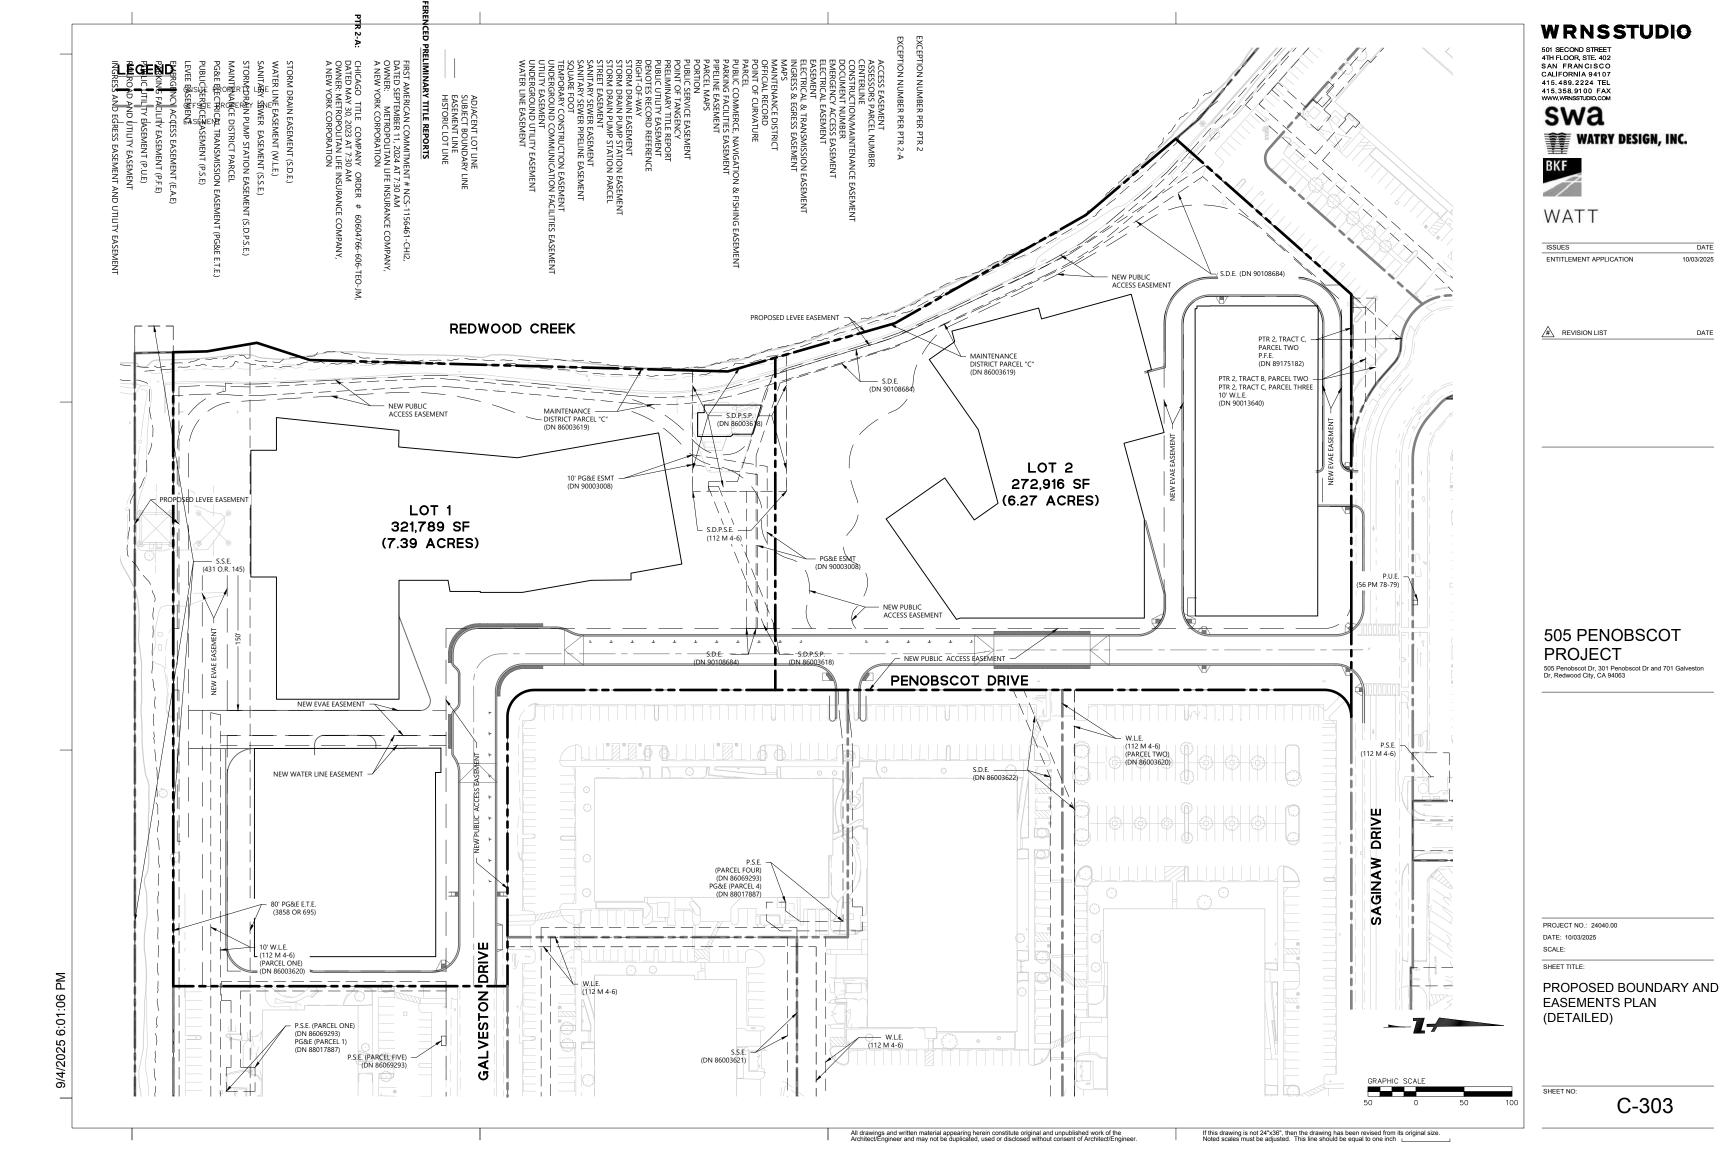
505 Penobscot Dr, 301 Penobscot Dr and 701 Galves Dr, Redwood City, CA 94063


PROJECT NO.: 24040.00

SHEET TITLE:

EXISTING BOUNDARY AND EASEMENTS PLAN (DETAILED)

SHEET NO:



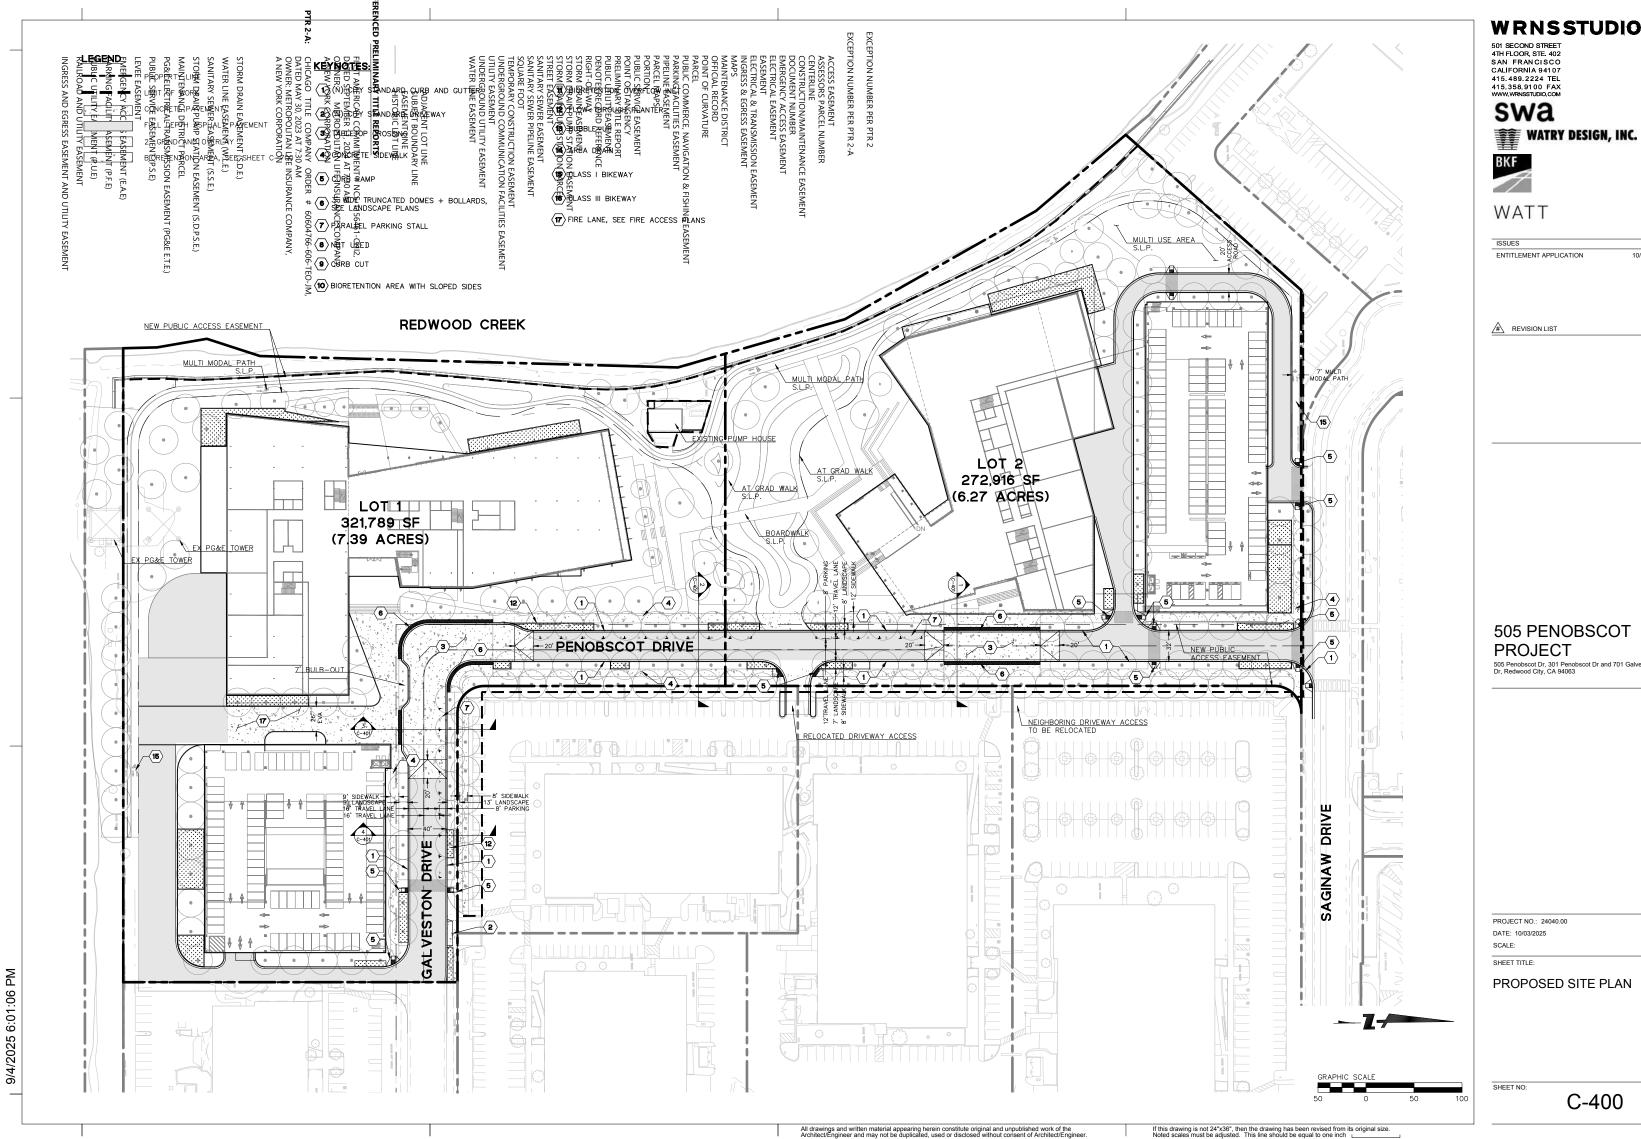


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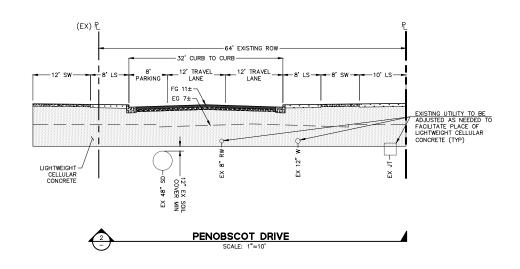
ISSUES	DATE
ENTITI EMENT ADDITION	40/00/0005


505 PENOBSCOT

505 Penobscot Dr, 301 Penobscot Dr and 701 Galvest Dr, Redwood City, CA 94063


PROPOSED SITE PLAN



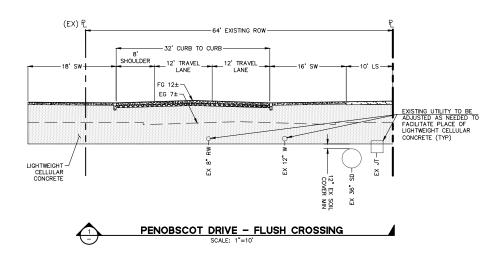

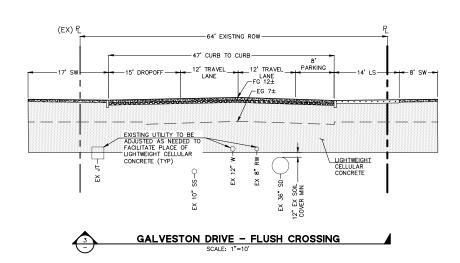

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		ISSUES	DATE

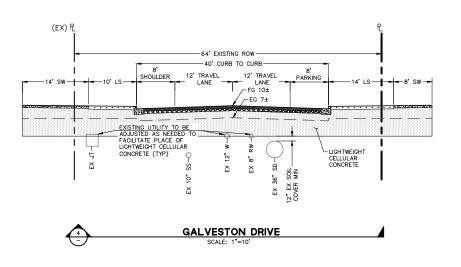REVISION LIST DATE

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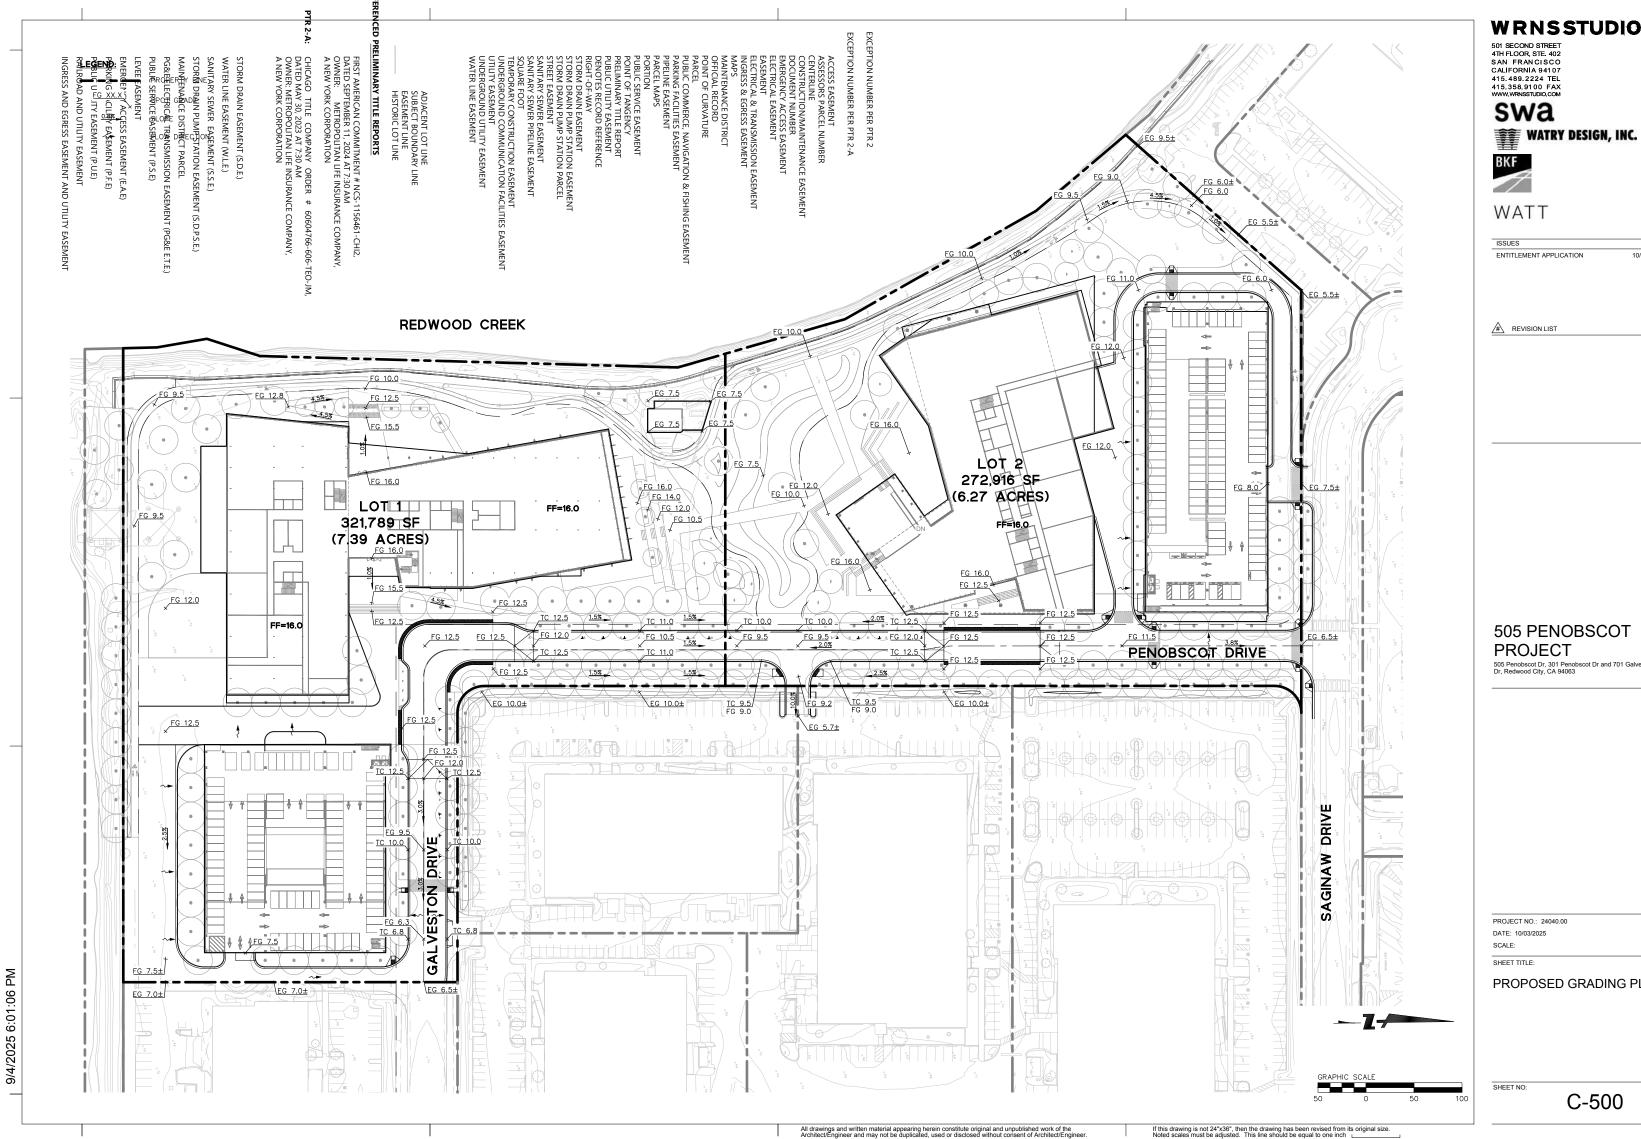
505 Penobscot Dr, 301 Penobscot Dr and 701 Galveston Dr, Redwood City, CA 94063

PROJECT NO.: 24040.00 DATE: 10/03/2025 SCALE:

SHEET TITLE:

CROSS SECTIONS

SHEET NO:



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ISSUES	DATE

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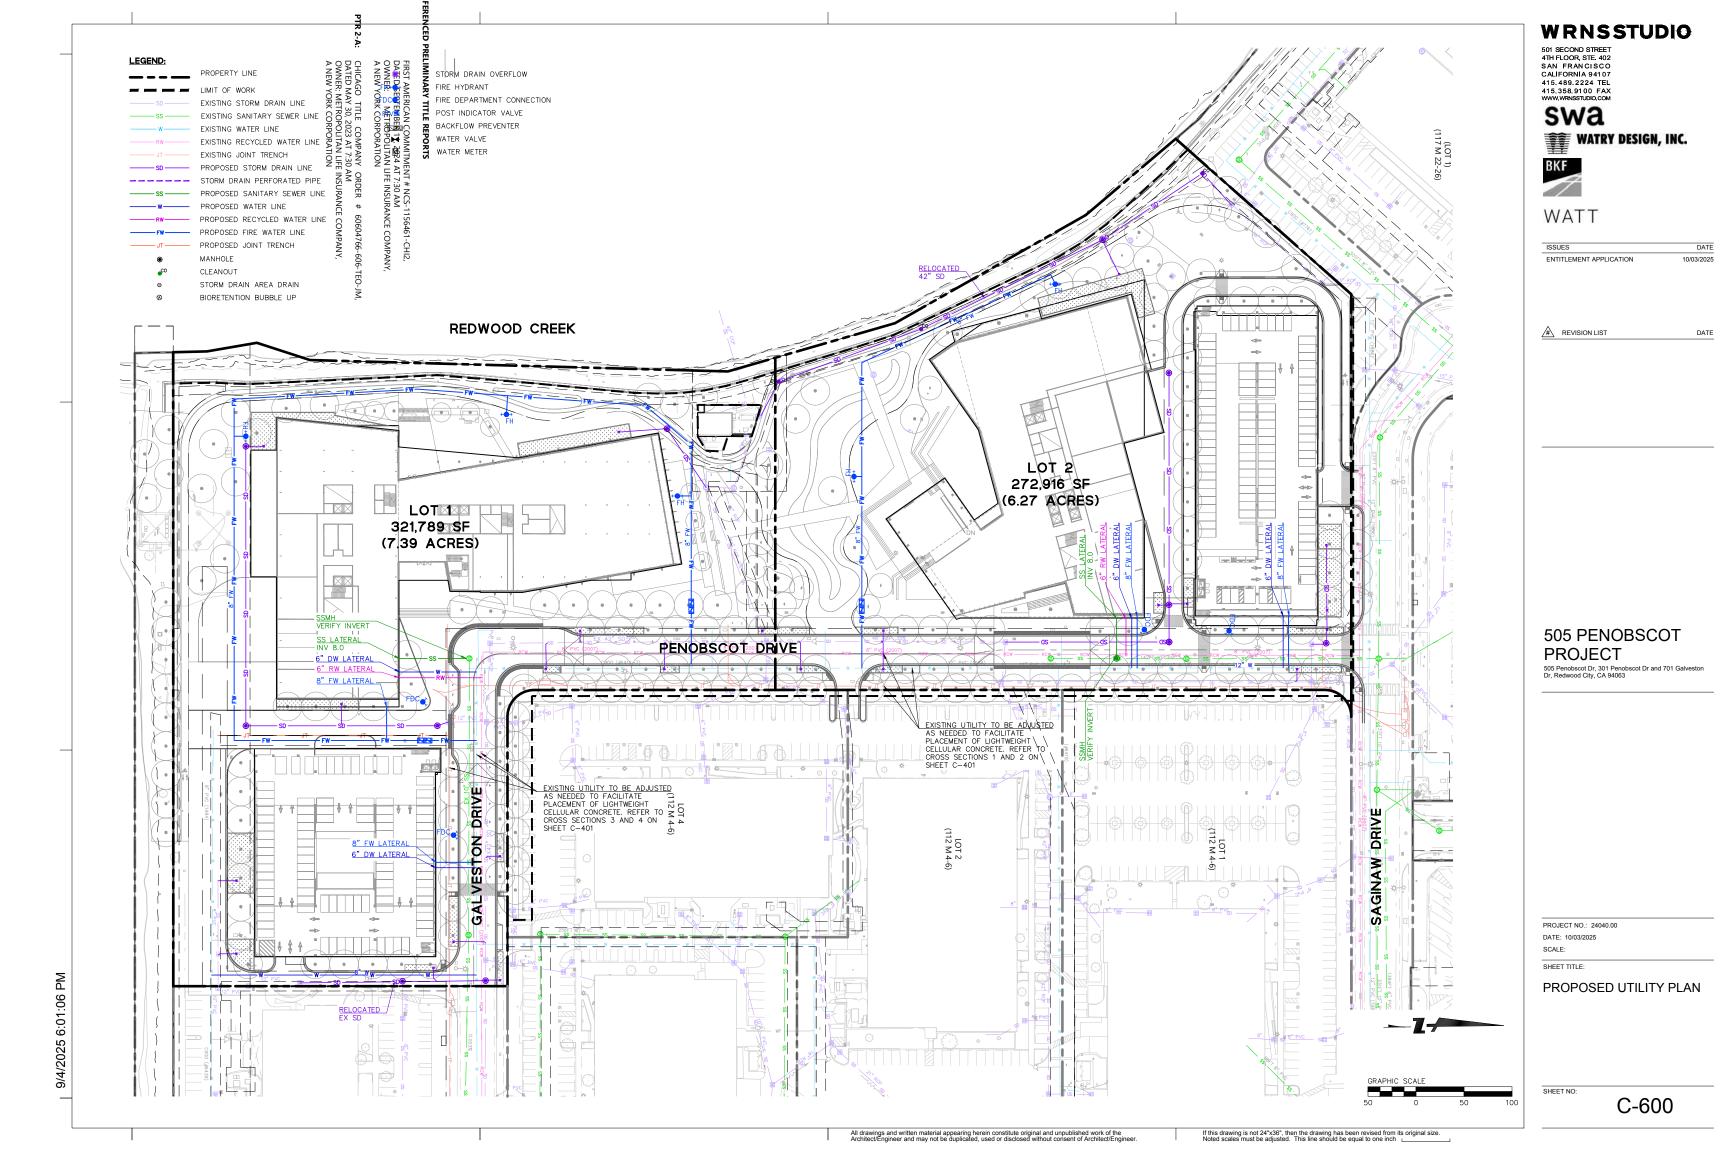
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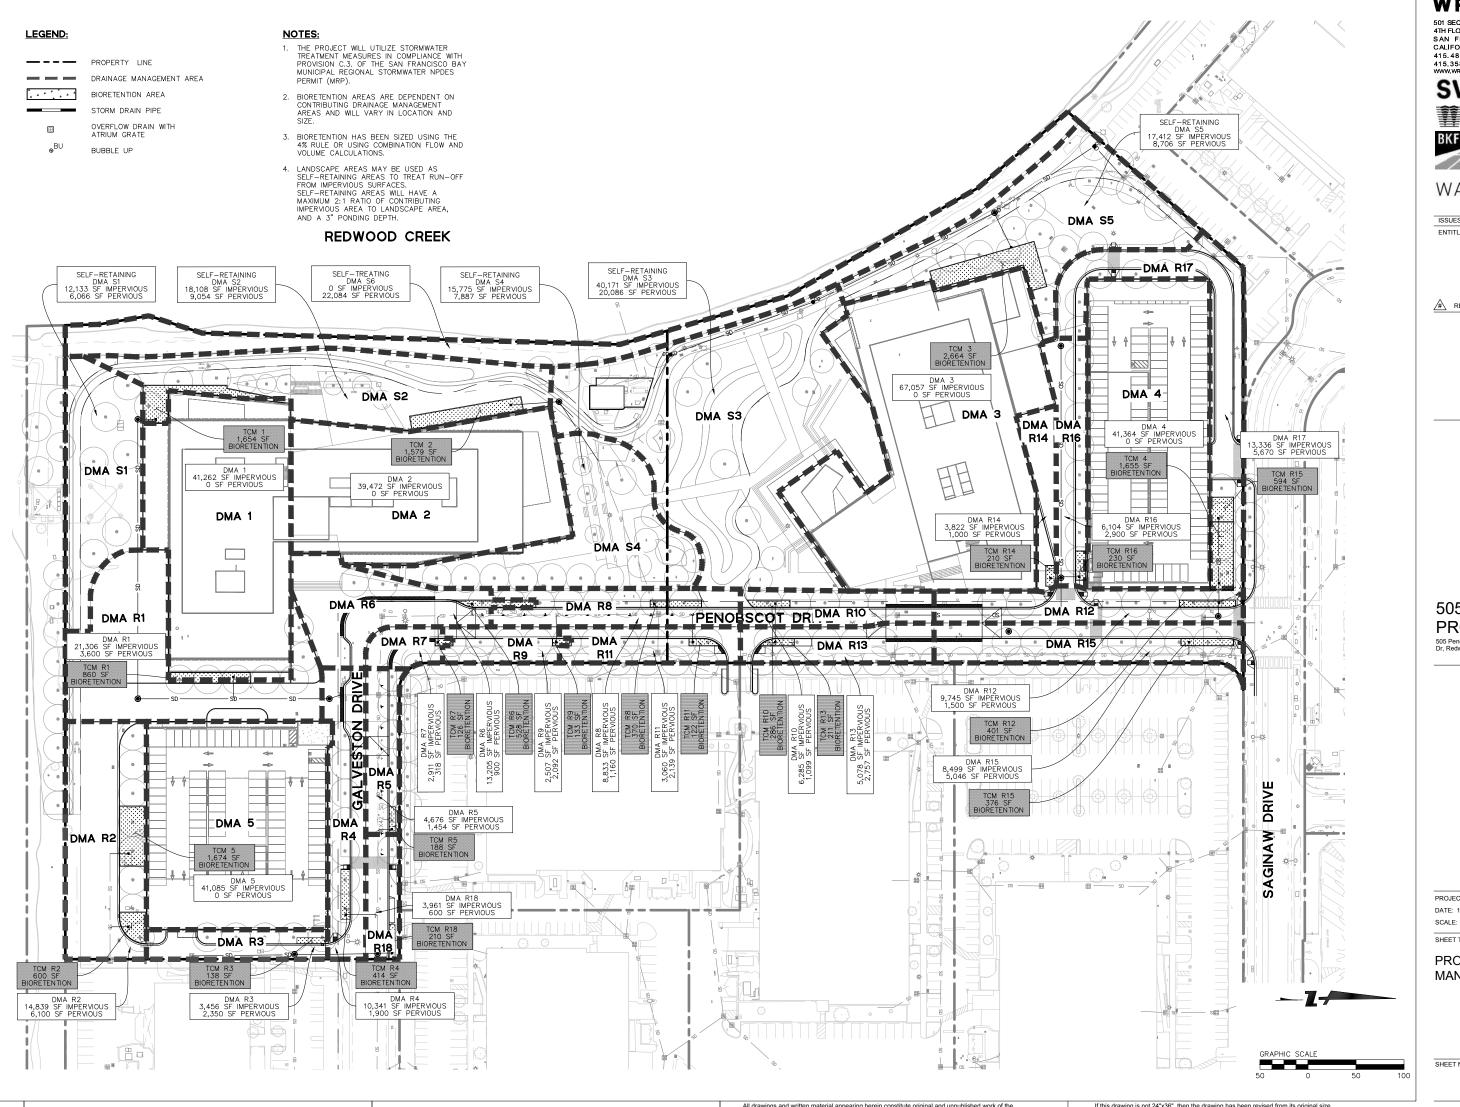
PROJECT NO.: 24040.00

SHEET TITLE:

PROPOSED GRADING PLAN

SHEET NO:





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> swa **WATRY DESIGN, INC.**



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ISSUES ENTITLEMENT APPLICATION 10/03/2025

DATE

REVISION LIST

505 PENOBSCOT PROJECT

505 Penobscot Dr, 301 Penobscot Dr and 701 Galveston Dr, Redwood City, CA 94063

PROJECT NO.: 24040.00

SHEET TITLE:

PROPOSED STORMWATER MANAGEMENT PLAN

SHEET NO:

TREATMENT CONTROL MEASURE SUMMARY TABLE															
									Bioretention			Self Retain	ning / Treating		
DMA#	TCM#	Location ¹	Treatment Type ²	LID or Non- LID	Sizing Method	Drainage Area (s.f.)	Impervious Area ⁴ (s.f.)	Pervious Area (Permeable Pavement) (s.f.)	Pervious Area (Other) (s.f.)	% Onsite Area Treated by LID or Non- LID TCM	Bioretention Area Required (s.f.)	Bioretention Area Provided (s.f.)	Overflow Riser Height (in)	Storage Depth Required (ft)	Storage Depth Provided (ft)
1	1	Onsite	Bioretention lined w/ underdrain	LID	2C. Flow: 4% Method **	41,262	41,262	-	0	6.94%	1,650	1,654	6		
2	2	Onsite	Bioretention lined w/ underdrain	LID	2C. Flow: 4% Method **	39,467	39,467	-	0	6.64%	1,579	1,579	6		
3	3	Onsite	Bioretention lined w/ underdrain	LID	2C. Flow: 4% Method **	65,536	65,536	-	0	11.02%	2,621	2,664	6		
4	4	Onsite	Bioretention lined w/ underdrain	LID	2C. Flow: 4% Method **	41,184	41,184	-	0	6.93%	1,647	1,664	6		
5	5	Onsite	Bioretention lined w/ underdrain	LID	2C. Flow: 4% Method **	41,085	41,085	-	0	6.91%	1,643	1,674	6		
R1	R1	Onsite	Bioretention lined w/ underdrain	LID	2C. Flow: 4% Method **	24,907	21,307	-	3,600	4.19%	852	860	6		
R2	R2	Onsite	Bioretention lined w/ underdrain	LID	2C. Flow: 4% Method **	20,929	14,829	-	6,100	3.52%	593	600	6		
R3	R3	Onsite	Bioretention lined w/ underdrain	LID	2C. Flow: 4% Method **	5,806	3,456	-	2,350	0.98%	138	138	6		
R4	R4	Onsite	Bioretention lined w/ underdrain	LID	2C. Flow: 4% Method **	12,241	10,341	-	1,900	2.06%	414	414	6		
R5	R5	Onsite	Bioretention lined w/ underdrain	LID	2C. Flow: 4% Method **	6,130	4,676	-	1,454	1.03%	187	188	6		
R6	R6	Onsite	Bioretention lined w/ underdrain	LID	2C. Flow: 4% Method **	14,105	13,205		900	2.37%	528	528	6		
R7	R7	Onsite	Bioretention lined w/ underdrain	LID	2C. Flow: 4% Method **	3,229	2,911	-	318	0.54%	116	126	6		
R8	R8	Onsite	Bioretention lined w/ underdrain	LID	2C. Flow: 4% Method **	9,993	8,833	-	1,160	1.68%	353	370	6		
R9	R9	Onsite	Bioretention lined w/ underdrain	LID	2C. Flow: 4% Method **	4,599	2,507	-	2,092	0.77%	100	133	6		
R10	R10	Onsite	Bioretention lined w/ underdrain	LID	2C. Flow: 4% Method **	7,384	6,285	-	1,099	1.24%	251	286	6		
R11	R11	Onsite	Bioretention lined w/ underdrain	LID	2C. Flow: 4% Method **	6,998	4,270	-	2,728	1.18%	171	182	6		
R12	R12	Onsite	Bioretention lined w/ underdrain	LID	2C. Flow: 4% Method **	11,245	9,745	•	1,500	1.89%	390	401	6		
R13	R13	Onsite	Bioretention lined w/ underdrain	LID	2C. Flow: 4% Method **	7,835	5,078		2,757	1.32%	203	211	6		
R14	R14	Onsite	Bioretention lined w/ underdrain	LID	2C. Flow: 4% Method ** 2C. Flow: 4%	4,822	3,822	-	1,000	0.81%	153	210	6		
R15	R15	Onsite	Bioretention lined w/ underdrain	LID	Method **	13,545	8,499	-	5,046	2.28%	340	376	6		
R16	R16	Onsite	Bioretention lined w/ underdrain	LID	2C. Flow: 4% Method ** 2C. Flow: 4%	9,004	6,104	-	2,900	1.51%	244	299	6		
R17	R17	Onsite	Bioretention lined w/ underdrain Bioretention lined w/	LID	2C. Flow: 4% Method ** 2C. Flow: 4%	19,006	13,336	-	5,670	3.20%	533	594	6		
R18	R18	Onsite	underdrain Self-retaining areas	LID	Method **	4,561	3,961	-	600	0.77%	158	210	6		
S1	-	Onsite	(landscaped) Self-retaining areas	LID	N/A	18,199	12,133	-	6,066	3.06%	N/A	N/A	N/A	3 inches	3 inches
S2	-	Onsite	(landscaped) Self-retaining areas	LID	N/A	27,161	18,108	-	9,054	4.57%	N/A	N/A	N/A	3 inches	3 inches
S3	-	Onsite	(landscaped) Self-retaining areas	LID	N/A	60,233	40,155	-	20,078	10.13%	N/A	N/A	N/A	3 inches	3 inches
S4	•	Onsite	(landscaped) Self-retaining areas	LID	N/A	23,662	15,775	-	7,887	3.98%	N/A	N/A	N/A	3 inches	3 inches
S5	-	Onsite	(landscaped) Self-treating areas	LID	N/A	28,511	19,007	-	9,504	4.79%	N/A	N/A	N/A	3 inches	3 inches
S6		Onsite	(landscaped)	LID	N/A Totals:	22,065 594,705	476,877	0	22,065 117,828	3.71%	N/A	N/A	N/A		
	Footnotes:				i otals:	394,703	4/0,0//	<u> </u>	111,020	100.00%	j				

18" BIOTREATMENT SOIL MIX PER C.3 TECHNICAL SPECIFICATIONS APPENDIX K. COMPLIES WITH SECTION AA, OF SAN MATEO COUNTY C.3 STORNWATER TECHNICAL GUIDANCE. 12-15" OF CLASS II PERMEAB SD OUT SEE NOTE 5 20 MIL HDPE LINER, TREMCO HDPE-20 OR APPROVED EQUAL TOWARD OUTLET NOTES:

- SEAL ALL PIPE PENETRATIONS THRU HDPE LINER PER MANUFACTURE INSTRUCTIONS TO PROVIDE A WATERTIGHT SEAL. USE TREMCO PARASEAL PARA JT TAPE (2-SIDED BUTYL TAPE) AND TREMCO PARASEAL PERMANENT SEAM TAPE. BIO-RETENTION SIDE SLOPES SHALL BE CONSTRUCTED FROM COMPACTED NATIVE SOIL AS APPROVED BY THE GEOTECHNICAL ENGINEER. BIO-RETENTION SOIL MIX SHALL BE PLACED ONLY WITHIN THE FLAT BOTTOM AREA OF THE BIO-RETENTION BASIN. CONTRACTOR SHALL CONTACT CIVIL ENGINEER FOR OBSERVATION OF PERFORATED PIPE LAYOUT (PRIOR TO BACKFILL) AND OVERFLOW INLET INSTALLATION. PROVIDE 2 DAYS MINIMUM NOTICE.

- MINIMUM NOTICE.

 CONTRACTOR SHALL EXERCISE EXTREME CARE TO MAINTAIN INTEGRITY OF HDPE LINER.

 CONTRACTOR SHALL REPAIR PUNCTURES OR DAMAGE WITH TREMCO PARASEAL PARA JT

 TAPE (2—SIDED BUTYL TAPE) AND TREMCO PARASEAL PERMANENT SEAM TAPE.

 DEPRESS LINER AT LOW POINT/OUTLET TO ALLOW WATER TO DRAIN OUT OF PLANTER.

 FITTINGS ARE SCHEMATIC. CONFIRM SIZING AND DIMENSIONS WITH MANUFACTURER.

 DETAILS SHOW APPROXIMATE LAYOUT OF PERFORATED PIPE, OVERFLOW INLETS, AND

 BUBBLE—UP STRUCTURES. REFER TO UTILITY PLAN FOR EXACT LOCATIONS. REFER TO

 HORIZONTAL CONTROL AND GRADING PLANS FOR ADDITIONAL INFORMATION.




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- 1 Per the Municipal Regional Stormwater Permit, sidewalks and other parts of the right-of-way should be included in the new and/or replaced impervious surface calculation and treated as required
- 2 "Lined" refers to an impermeable liner placed on the bottom of a Bioretention basin or a concrete Flow-Through Planter, such that no infiltration into native soil occurs.

 3 Sizing for Bioretention Area Required calculated using the 4% Method (Impervious Area x 0.04)

 4 Gravel is considered as an impervious surface unless it is part of an infiltration trench.

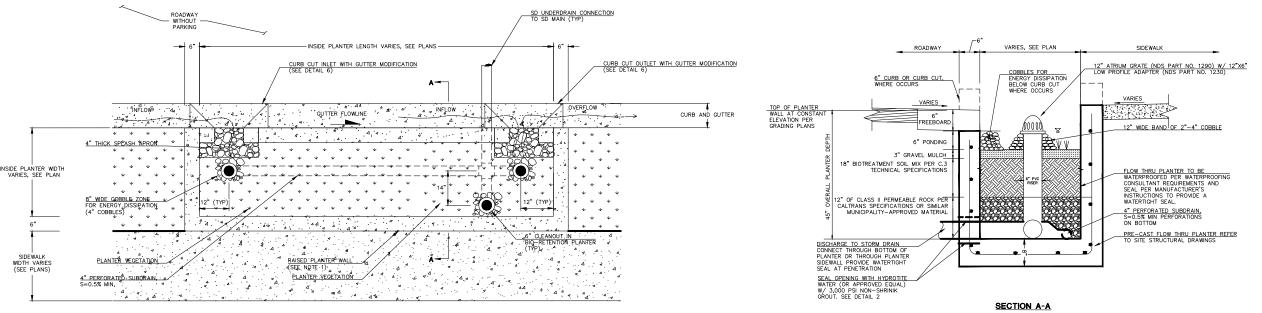

- SLOPE TOP OF PLANTER WALL TO MATCH LONGITUDINAL SLOPE OF ADJACENT SURFACE.
 LAY OUT DRAINAGE NOTCHES TO PREVENT PONDING BEHIND PLANTER WALL WITH 5' MAXIMUM
 SPACING BETWEEN NOTCHES.
 4" THICK SPLASH APRON SHALL NOT BE INTEGRAL TO PLANTER WALL OR OTHER ADJACENT
- CONCRETE ELEMENTS.
 4. SCARIFY SUBGRADE TO A DEPTH OF 3 INCHES (MIN) IMMEDIATELY PRIOR TO PLACEMENT OF

- SCARIFY SUBGRADE TO A DEPTH OF 3 INCHES (MIN) IMMEDIATELY PRIOR TO PLACEMENT OF AGGREGATE STORAGE AND BIO-RETENTION SOIL MATERIAL.
 ALL FITTINGS SHALL BE SOIL TIGHT.
 TOP OF PONDING ELEVATION IS EQUAL TO LOWEST DESIGN FLOW ELEVATION
 SET CROWN OF UNDERDRAIN PIPE AT OR BELOW BOTTOM OF CHOKING COURSE.
 CONTRACTOR SHALL PROVIDE DETAILED SHOP DRAWINGS FOR PRE-CAST TREATMENT PLANTER FOR REVIEW PRIOR TO FABRICATION.



WRNSSTUDIO

501 SECOND STREET 415.489.2224 TEL

415.358.9100 FAX swa





WATT

ISSUES ENTITLEMENT APPLICATION 10/03/2025

REVISION LIST DATE

505 PENOBSCOT PROJECT

505 Penobscot Dr, 301 Penobscot Dr and 701 Galveston Dr, Redwood City, CA 94063

PROJECT NO.: 24040.00 SCALE:

SHEET TITLE:

PROPOSED STORMWATER MANAGEMENT DATA AND **DETAILS**

SHEET NO:




Clean Water. Healthy Community.

Construction Best Management Practices (BMPs)

Construction projects are required to implement the stormwater best management practices (BMP) on this page, as they apply to your project, all year long.

Materials & Waste Management

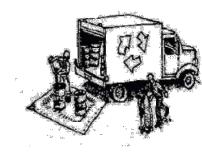

Non-Hazardous Materials

- ☐ Berm and cover stockpiles of sand_dirt or other construction material with tarps when rain is forecast or if not actively being used within
- ☐ Use (but don't overuse) reclaimed water for dust control

Hazardous Materials

- ☐ Label all hazardous materials and hazardous wastes (such as pesticides, paints, thinners, solvents, fuel, oil, and antifreeze) in accordance with city, county, state and federal regulations.
- ☐ Store hazardous materials and wastes in water tight containers, store in appropriate secondary containment, and cover them at the end of every work day or during wet weather or when rain is forecast.
- ☐ Follow manufacturer's application instructions for hazardous materials and be careful not to use more than necessary. Do not apply chemicals outdoors when rain is forecast within 24 hours.
- ☐ Arrange for appropriate disposal of all hazardous wastes.

Waste Management

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- ☐ Cover waste disposal containers securely with tarps at the end of every work day and during wet weather.
- ☐ Check waste disposal containers frequently for leaks and to make sure they are not overfilled. Never hose down a dumpster on the
- ☐ Clean or replace portable toilets, and inspect them frequently for leaks and spills.
- ☐ Dispose of all wastes and debris properly. Recycle materials and wastes that can be recycled (such as asphalt, concrete, aggregate base materials, wood, gyp board, pipe, etc.)
- ☐ Dispose of liquid residues from paints, thinners, solvents, glues, and cleaning fluids as hazardous waste.

Construction Entrances and Perimeter

- ☐ Establish and maintain effective perimeter controls and stabilize all construction entrances and exits to sufficiently control erosion and sediment discharges from site and tracking off site.
- ☐ Sweep or vacuum any street tracking immediately and secure ediment source to prevent further tracking. Never hose down streets to clean up tracking.

Equipment Management & Spill Control



Maintenance and Parking

- Designate an area, fitted with appropriate BMPs, for vehicle and equipment parking and storag
- ☐ Perform major maintenance, repair jobs, and vehicle and equipment washing off site.
- ☐ If refueling or vehicle maintenance must be done nsite, work in a bermed area away from storm drains and over a drip pan or drop cloths big enough to collect fluids. Recycle or dispose of fluids as hazardous waste.
- ☐ If vehicle or equipment cleaning must be done onsite, clean with water only in a bermed area that will not allow rinse water to run into gutters, streets, storm
- ☐ Do not clean vehicle or equipment onsite using soaps, solvents, degreasers, or steam cleaning equipment.

Spill Prevention and Control

- ☐ Keep spill cleanup materials (e.g., rags, absorbents and cat litter) available at the construction site at all times.
- ☐ Inspect vehicles and equipment frequently for and repair leaks promptly. Use drip pans to catch leaks until repairs are made.
- ☐ Clean up spills or leaks immediately and dispose of leanup materials properly.
- ☐ Do not hose down surfaces where fluids have spilled Use dry cleanup methods (absorbent materials, cat litter, and/or rags).
- ☐ Sweep up spilled dry materials immediately. Do not try to wash them away with water, or bury them.
- ☐ Clean up spills on dirt areas by digging up and properly disposing of contaminated soil.
- ☐ Report significant spills immediately. You are required by law to report all significant releases of hazardous naterials, including oil. To report a spill: 1) Dial 911 or your local emergency response number, 2) Call the Governor's Office of Emergency Services Warning Center, (800) 852-7550 (24 hours).

Earthmoving



- ☐ Schedule grading and excavation work during dry weather.
- ☐ Stabilize all denuded areas, install and maintain temporary erosion controls (such as erosion control fabric or bonded fiber matrix) until vegetation is established.
- \square Remove existing vegetation only when absolutely necessary, and seed or plant vegetation for erosion control on slopes or where construction is not immediately
- ☐ Prevent sediment from migrating offsite and protect storm drain inlets, gutters, ditches, and drainage courses by installing and maintaining appropriate BMPs, such as fiber rolls, silt fences, sediment basins, gravel bags, berms, etc.
- ☐ Keep excavated soil on site and transfer it to dump trucks on site, not in the streets.

- ☐ If any of the following conditions are observed, test for contain contact the Regional Water Quality Control Board:
- Unusual soil conditions, discoloration,
- Abandoned underground tanks
- Abandoned wells
- Buried barrels, debris, or trash

Paving/Asphalt Work



- ☐ Avoid paving and seal coating in wet veather or when rain is forecast, to prevent materials that have not cured from contacting stormwater runoff.
- □ Cover storm drain inlets and manholes when applying seal coat, tack coat, slurry seal, fog seal, etc.
- ☐ Collect and recycle or appropriately dispose of excess abrasive gravel or sand. Do NOT sweep or wash it into gutters.
- ☐ Do not use water to wash down fresh asphalt concrete pavement.

Sawcutting & Asphalt/Concrete Removal

- ☐ Protect nearby storm drain inlets when saw cutting. Use filter fabric, catch basin inlet filters, or gravel bags to keep slurry out of the storm drain system.
- ☐ Shovel, abosorb, or vacuum saw-cut slurry and dispose of all waste as soon as you are finished in one location or at the end of each work day (whichever is
- ☐ If sawcut slurry enters a catch basin, clean it up immediately.

Concrete, Grout & Mortar




- ☐ Store concrete, grout, and mortar away from storm drains or waterways, and on pallets under cover to protect them from rain, runoff, and wind.
- Wash out concrete equipment/trucks offsite or in a designated washout area, where the water will flow into a temporary waste pit, and in a manner that will prevent leaching into the underlying soil or onto surrounding areas Let concrete harden and dispose of as
- ☐ When washing exposed aggregate, prevent washwater from entering storm drains. Block any inlets and vacuum gutters, hose washwater onto dirt areas, or drain onto a bermed surface to be pumped

Landscaping



- \square Protect stockpiled landscaping materials from wind and rain by storing them under tarps all year-round.
- ☐ Stack bagged material on pallets and
- ☐ Discontinue application of any erodible landscape material within 2 days before a forecast rain event or during wet weather.

Painting & Paint Removal

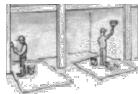


Painting Cleanup and Removal

- ☐ Never clean brushes or rinse paint containers into a street, gutter, storm drain, or stream
- \square For water-based paints, paint out brushes to the extent possible, and rinse into a drain that goes to the sanitary sewer.
- ☐ For oil-based paints, paint out brushes to reuse thinners and solvents. Dispose of excess liquids as hazardous waste.
- swept up or collected in plastic drop cloths and disposed of as trash.
- ☐ Chemical paint stripping residue and chips and dust from marine paints or paints must be disposed of as hazardous waste Lead based paint removal requires a state



- runoff from dewatering operations must be properly managed and disposed. When possible send dewatering discharge to landscaped area or sanitary sewer. If discharging to the sanitary sewer call your local wastewater treatment plant.
- ☐ Divert run-on water from offsite away from all disturbed areas.
- ☐ When dewatering, notify and obtain approval from the local municipality or storm drain. Filtration or diversion through a basin, tank, or sediment trap may be required.
- ☐ In areas of known or suspected to be collected and hauled off-site for

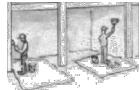

- Never pour paint down a storm drain
- the extent possible and clean with thinner or solvent in a proper container. Filter and
- ☐ Paint chips and dust from non-hazardous dry stripping and sand blasting may be

Dewatering



- ☐ Discharges of groundwater or captured
- before discharging water to a street gutter
- contamination, call your local agency to determine whether the ground water must be tested. Pumped groundwater may need treatment and proper disposal.

Storm drain polluters may be liable for fines of up to \$10,000 per day!

PROJECT NO.: 24040.00

PRACTICES

BEST MANAGEMENT

SHEET TITLE

C-702

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WATRY DESIGN, INC.

415, 489, 2224 TEL 415.358.9100 FAX swa

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ENTITLEMENT APPLICATION

REVISION LIST

505 PENOBSCOT

505 Penobscot Dr, 301 Penobscot Dr and 701 Galves Dr, Redwood City, CA 94063

PROJECT

ISSUES

PROJECT NARRATIVE

The open space framework for the Project is structured around two primary zones:

The Waterfront Zone – "Wet Landscape"
The "wet landscape" evokes the nearby salt marshes of Bair Island, bringing that ecological gesture into the site through organic landforms, immersive planting, and opportunities for passive recreation. The topography forms a variety of spatial scales and programming moments, opening views outward and activating the multi-modal path along the waterfront.

The Streetscape Zone – "Urban Edge"

Defining the "urban edge" of the project, the streetscape landscape includes flush drop-off plazas at building entries, generous sidewalks, street trees, understory, and typical streetscape amenities. The frontage established along this zone contributes to the entry experience of visitors and building occupants alike.


This 'Urban Wild' open space framework forms the foundation of the public-facing landscape design on the project. These zones are further activated by a series of private terrace and courtyards that break out from the buildings to provide programming areas for

A comprehensive circulation system includes sidewalks, multi-modal and pedestrian-only pathways, as well as a low boardwalk system that connects the buildings to the wet landscape and the waterfront. This creates a layered sequence of experiences throughout the site.

The materiality approach is inspired by the local Redwood City natural systems - forests, coastal salt marsh, and productive working landscapes. The design translates these references into a palette that unites architecture and landscape, emphasizing durability, ecological consideraitons, and a commitment to sustainability.



① OPEN SPACE FRAMEWORK - WET LANSCAPE
1" = 100'-0"

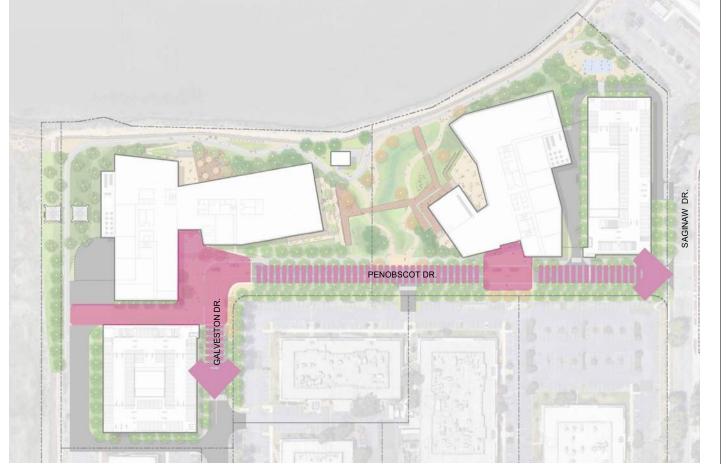

② OPEN SPACE FRAMEWORK- URBAN EDGE 1" = 100'-0"

WATERFRONT ACCESS

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TRAIL ACTIVATION



SHORELINE RESTORATION



MULTI MODAL PATH





SEATING ALONG TRAIL SHOLDER

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505 Penobscot Dr, 301 Penobscot Dr and 701 Galveston Dr, Redwood City, CA 94063



PROJECT NO.: 24040.00 DATE: 09/15/2025 SCALE: 1" = 100'-0"

SHEET TITLE:

OPEN SPACE **FRAMEWORK**

L-001

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PROJECT NO.: 24040.00 DATE: 09/15/2025 SCALE: 1" = 50'-0"

SHEET TITLE:

OVERALL LANSCAPE SITE PLAN

SHEET NO:

L-101

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1 10% PUBLIC ACCESS 1" = 50'-0" WRNSSTUDIO

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ENTITLEMENT APPLICATION #1 09/15/2025

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PROJECT NO.: 24040.00 DATE: 09/15/2025 SCALE: 1" = 50'-0"

SHEET TITLE:

10% PUBLIC ACCESS

SHEET NO:

L-102

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① REGIONAL CIRCULATION DIAGRAMS
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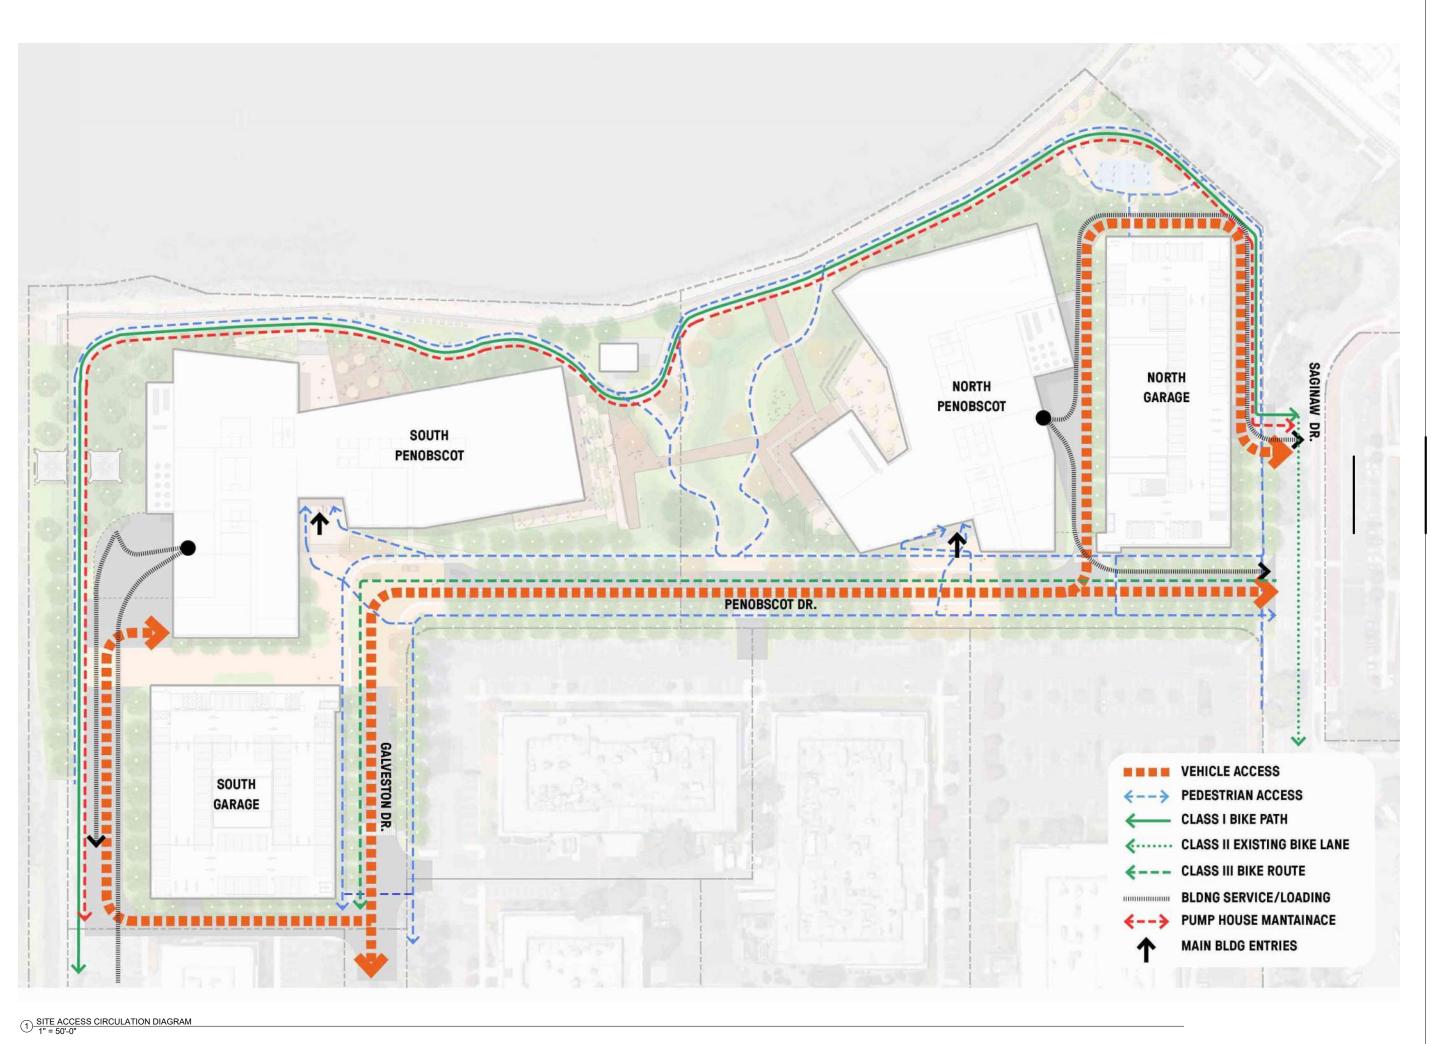


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REGIONAL CIRCULATION DIAGRAM

SHEET NO:



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ENTITI EMENT ADDITION #4	00/45/0005

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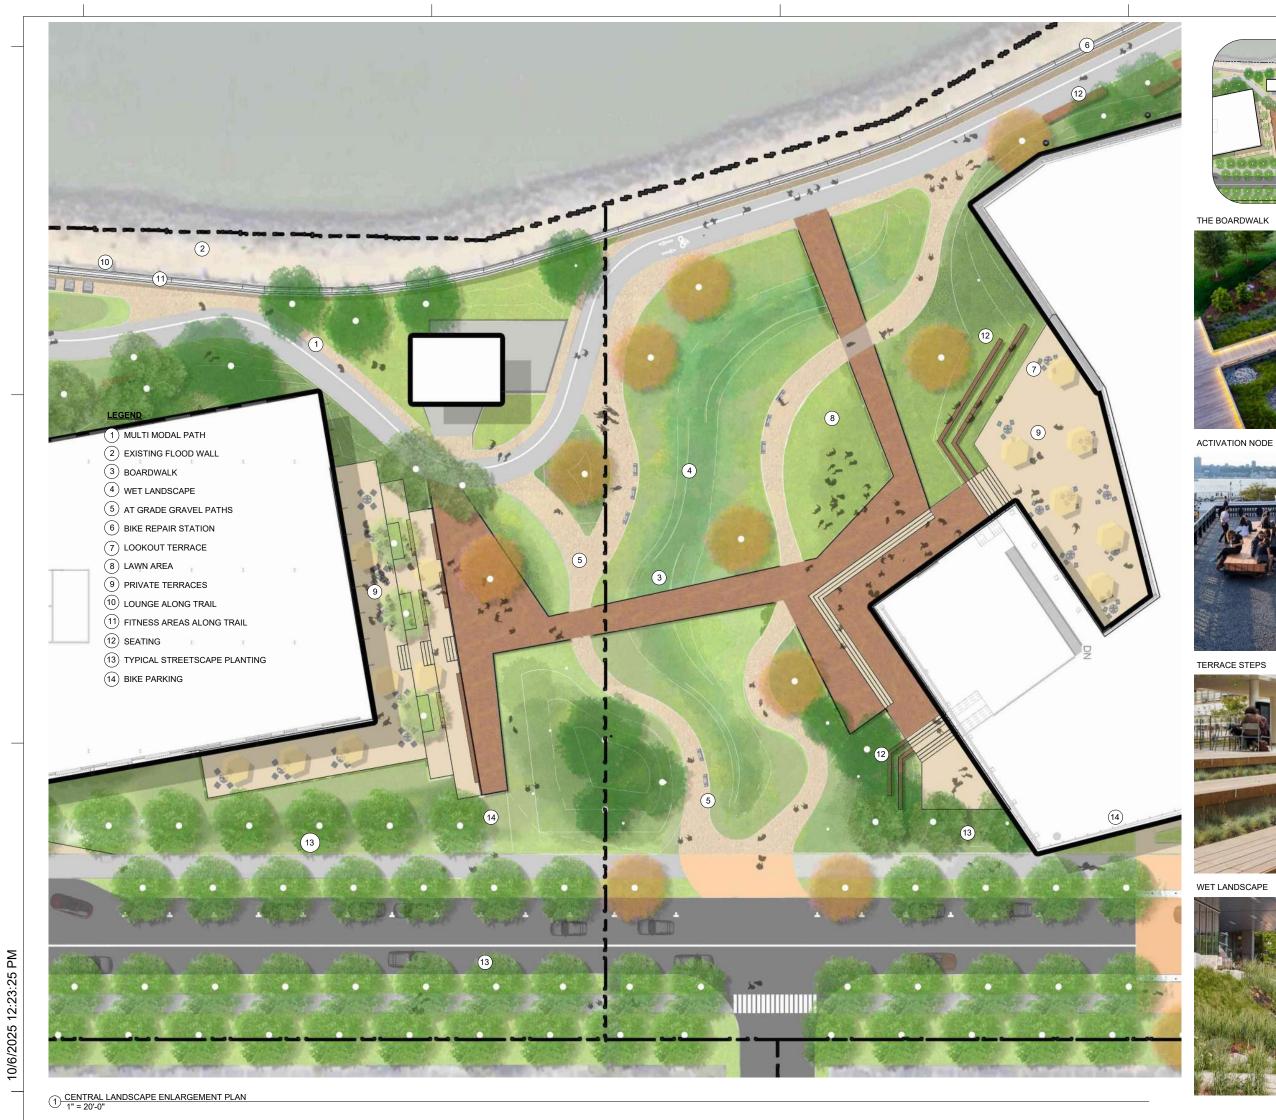


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SITE ACCESS CIRCULATION DIAGRAMS

SHEET NO:





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505 Penobscot Dr, 301 Penobscot Dr and 701 Galveston Dr, Redwood City, CA 94063





PROJECT NO.: 24040.00 DATE: 09/15/2025 SCALE: As indicated

SHEET TITLE:

CENTRAL LANDSCAPE ENLARGEMENT PLAN

SHEET NO:

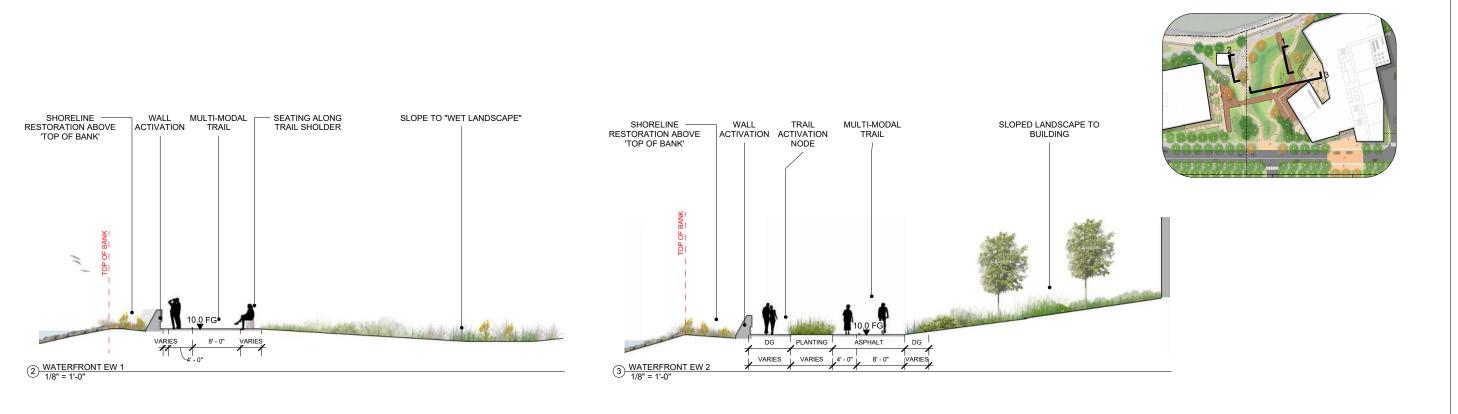

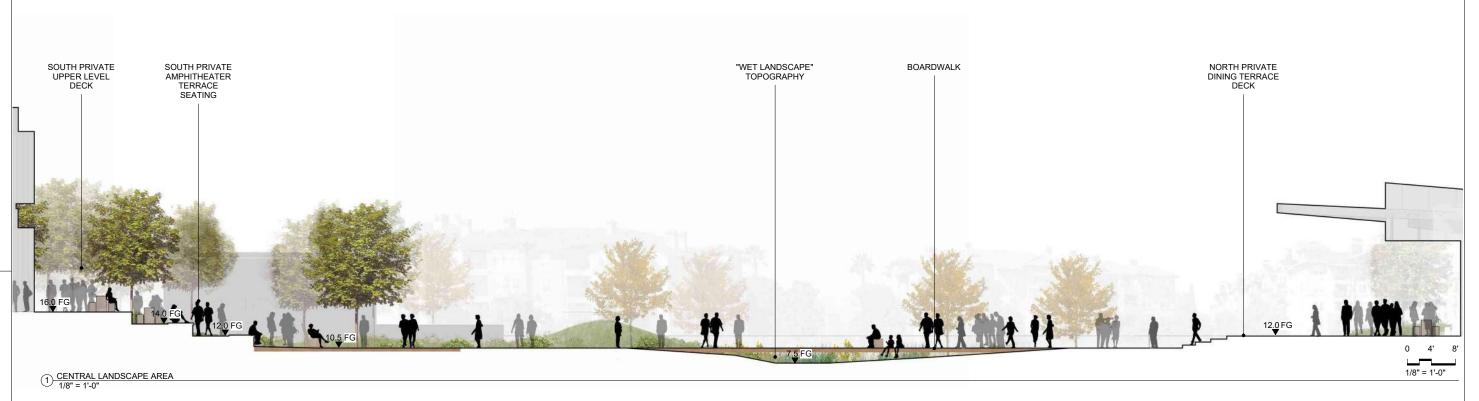

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TERRACE SEATING

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505 Penobscot Dr, 301 Penobscot Dr and 701 Galveston Dr, Redwood City, CA 94063

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PROJECT NO.: 24040.00 DATE: 09/15/2025

SCALE: As indicated

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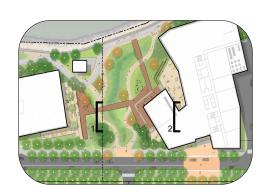
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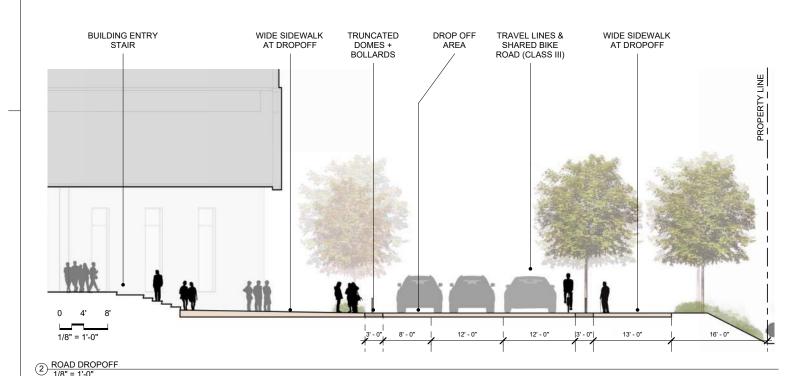
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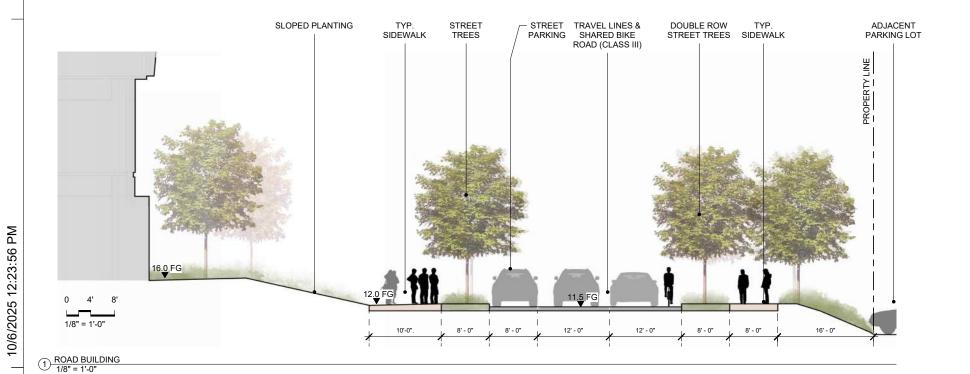
L-301

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SIDEWALK



CURBLESS DROP OFF



STREETSCAPE





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ISSUES	DATE
ENTITLEMENT APPLICATION #1	09/15/2025

REVISION LIST

505 PENOBSCOT PROJECT

505 Penobscot Dr, 301 Penobscot Dr and 701 Galveston Dr, Redwood City, CA 94063




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SECTIONS

SHEET NO:



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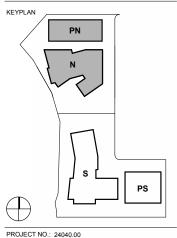

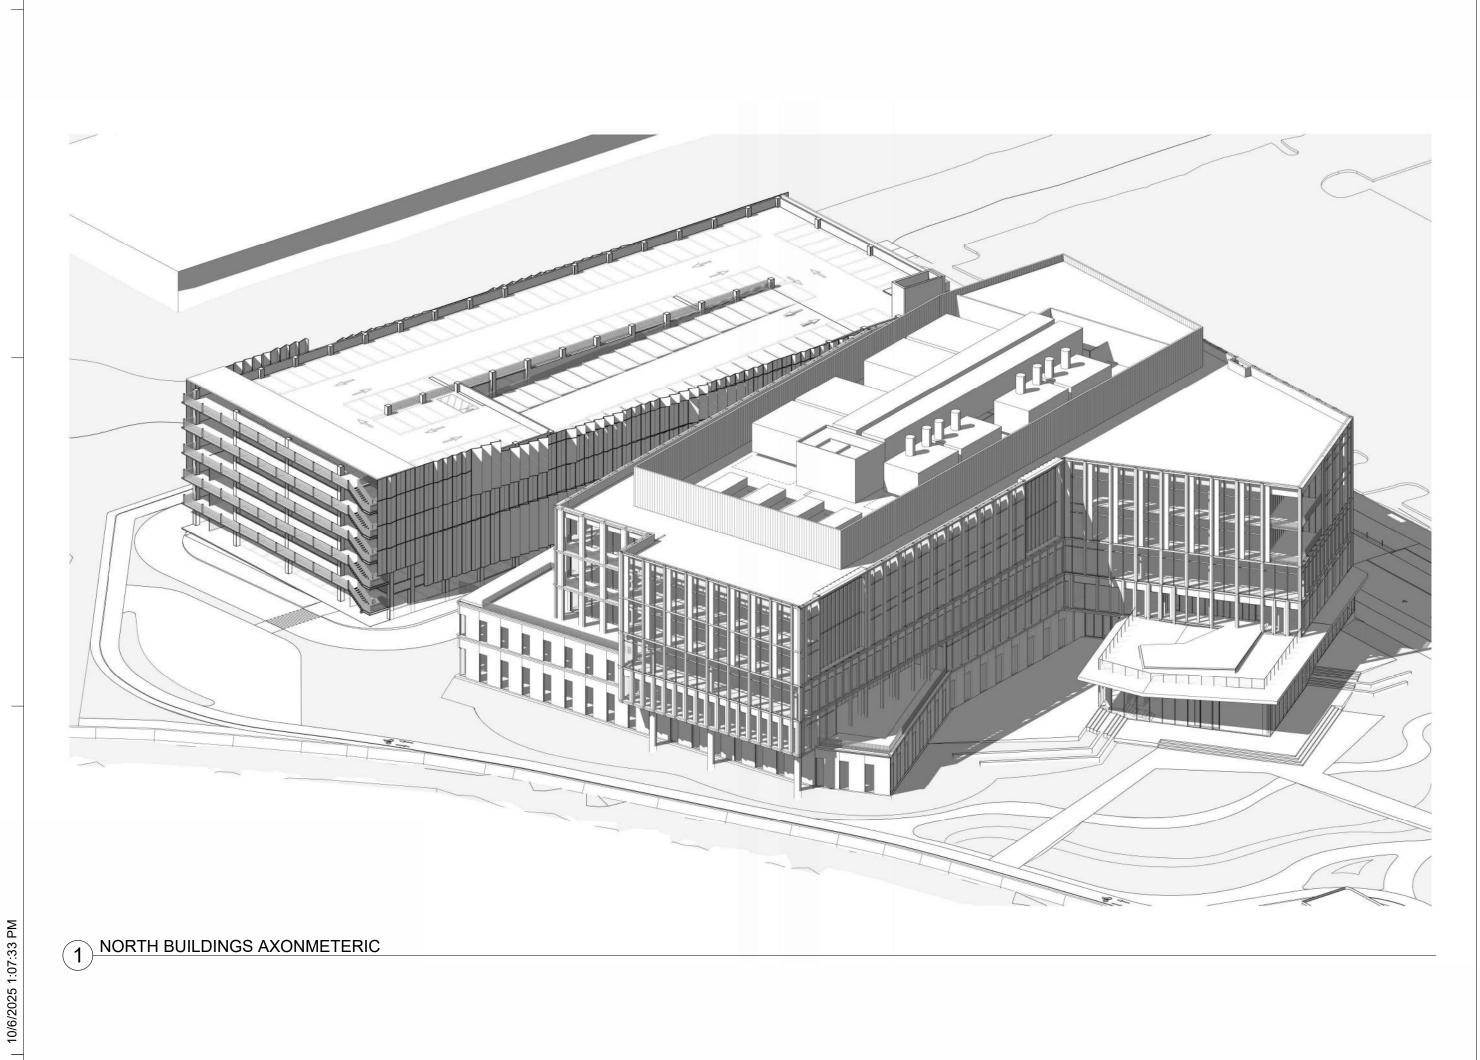
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ISSUES	DATE
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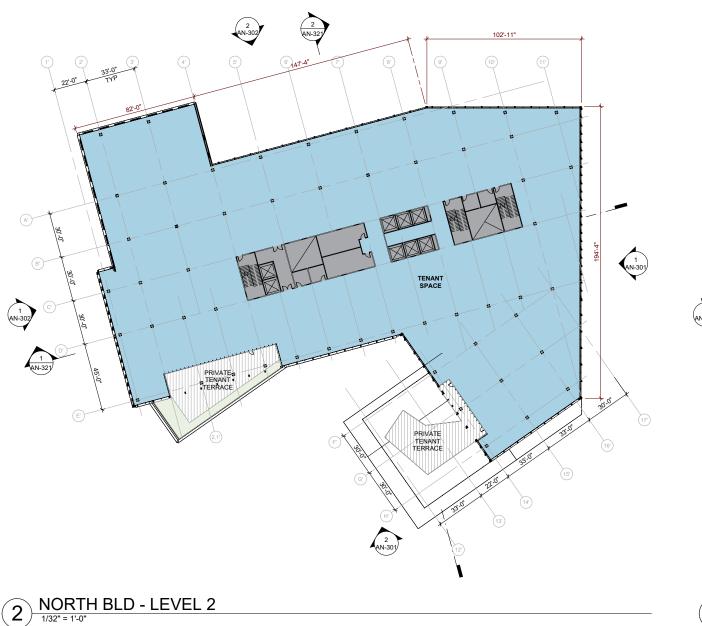


PROJECT NO.: 24040.00 SCALE:

SHEET TITLE:

NORTH BUILDINGS AXON

SHEET NO:



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1 NORTH BLD - LEVEL 1

0' 16' 32' 64' 128'

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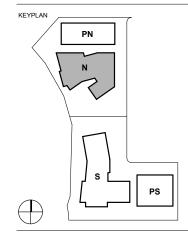
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REVISION LIST DATE

505 PENOBSCOT PROJECT

505 Penobscot Dr, 301 Penobscot Dr and 701 Galvestor Dr, Redwood City, CA 94063




PROJECT NO.: 24040.00 DATE: 09/25/2025 SCALE: 1/32" = 1'-0"

SHEET TITLE:

NORTH BUILDING FLOOR PLANS

SHEET NO:

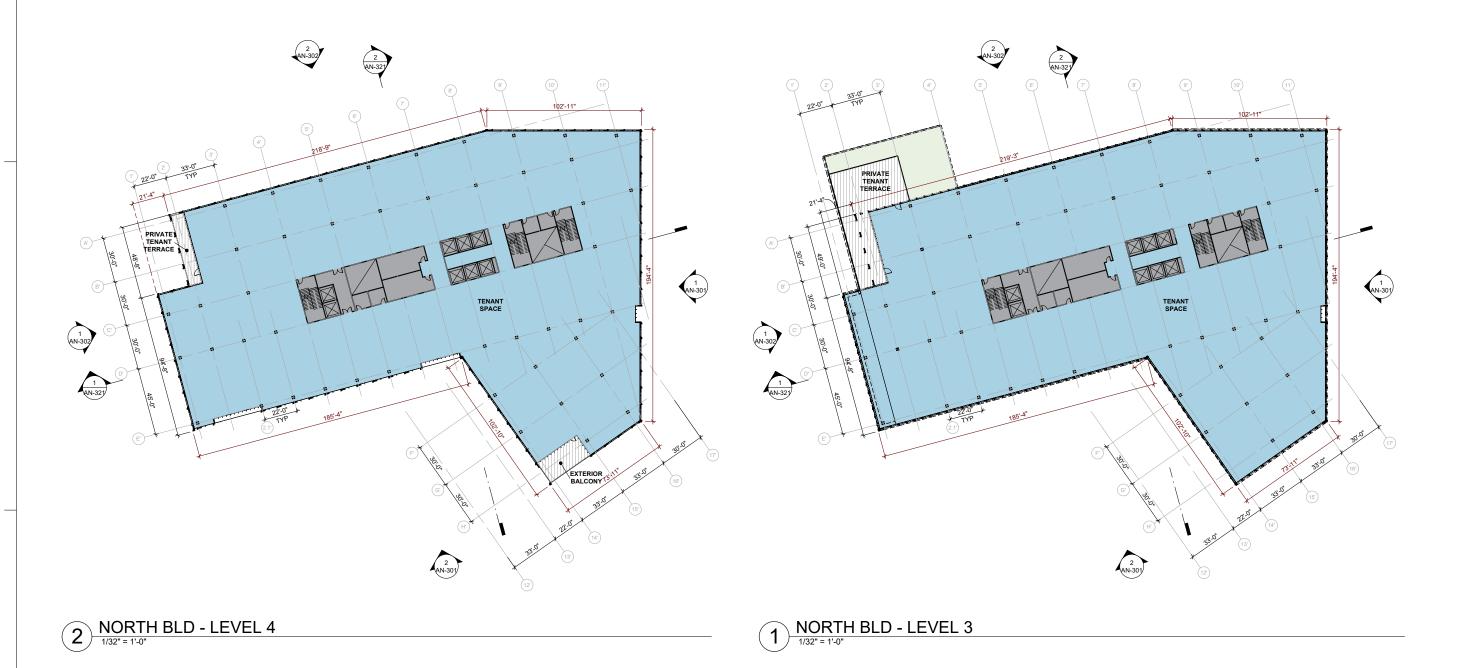

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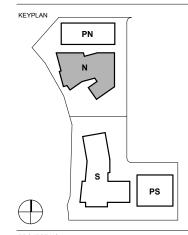
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ISSUES	DATE
ENTITI EMENT APPLICATION	09/25/2025

REVISION LIST DATE

505 PENOBSCOT PROJECT

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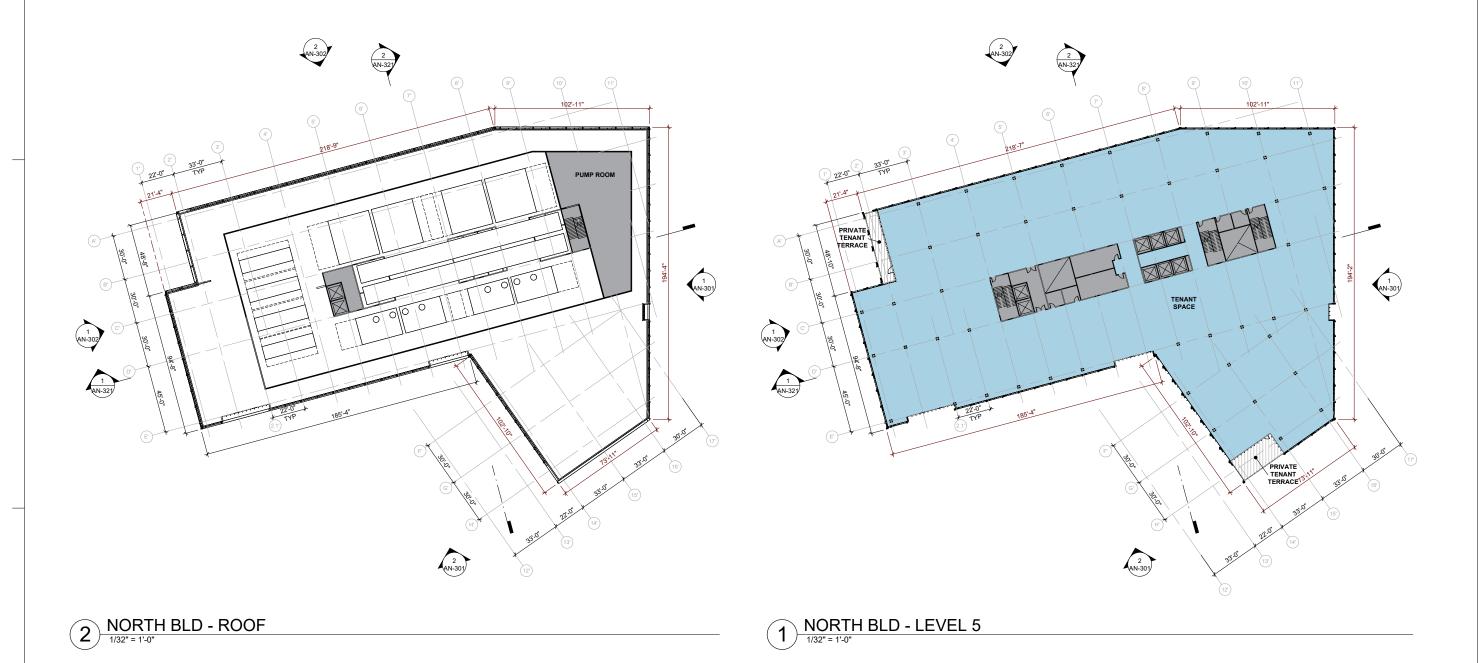


PROJECT NO.: 24040.00 DATE: 09/25/2025 SCALE: 1/32" = 1'-0"

SHEET TITLE:

NORTH BUILDING FLOOR PLANS

SHEET NO:



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501 SECOND STREET 4TH FLOOR, STE. 402 SAN FRANCISCO CALIFORNIA 94107 415.489.2224 TEL 415.358.9100 FAX WWW.WRNSSTUDIO.COM

SWA WATRY DESIGN, INC.




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ISSUES	DATE
ENTITLEMENT APPLICATION	09/25/2025

REVISION LIST DATE

505 PENOBSCOT PROJECT

505 Penobscot Dr, 301 Penobscot Dr and 701 Galveston Dr, Redwood City, CA 94063

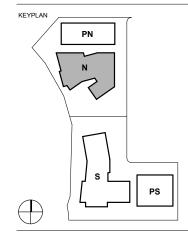

PROJECT NO.: 24040.00 DATE: 09/25/2025 SCALE: 1/32" = 1'-0"

SHEET TITLE:

NORTH BUILDING FLOOR PLANS

SHEET NO:





EAST ELEVATION



13 PLASTER

12 GLASS GUARDRAIL



11 PICKET GUARDRAIL

























01 BOARD FORM CONCRETE

AN-301

PROJECT NO.: 24040.00 SCALE: As indicated SHEET TITLE:

NORTH BUILDING **ELEVATIONS**

505 PENOBSCOT

505 Penobscot Dr, 301 Penobscot Dr and 701 Galvesto Dr, Redwood City, CA 94063

PROJECT

09/25/2025

All drawings and written material appearing herein constitute original and unpublished work of the Architect/Engineer and may not be duplicated, used or disclosed without consent of Architect/Engineer.

If this drawing is not 24"x36", then the drawing has been revised from its original size. Noted scales must be adjusted. This line should be equal to one inch ${}_{\rm L}$



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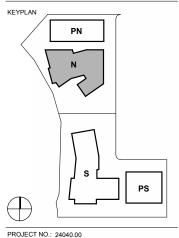
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ISSUES	DATE
ENTITLEMENT APPLICATION	09/25/2025

<u>/#\</u>	REVISION LIST	DATE

505 PENOBSCOT PROJECT

505 Penobscot Dr, 301 Penobscot Dr and 701 Galvesto Dr, Redwood City, CA 94063




PROJECT NO.: 24040.00 DATE: 09/25/2025

SCALE: As indicated

SHEET TITLE:

NORTH BUILDING

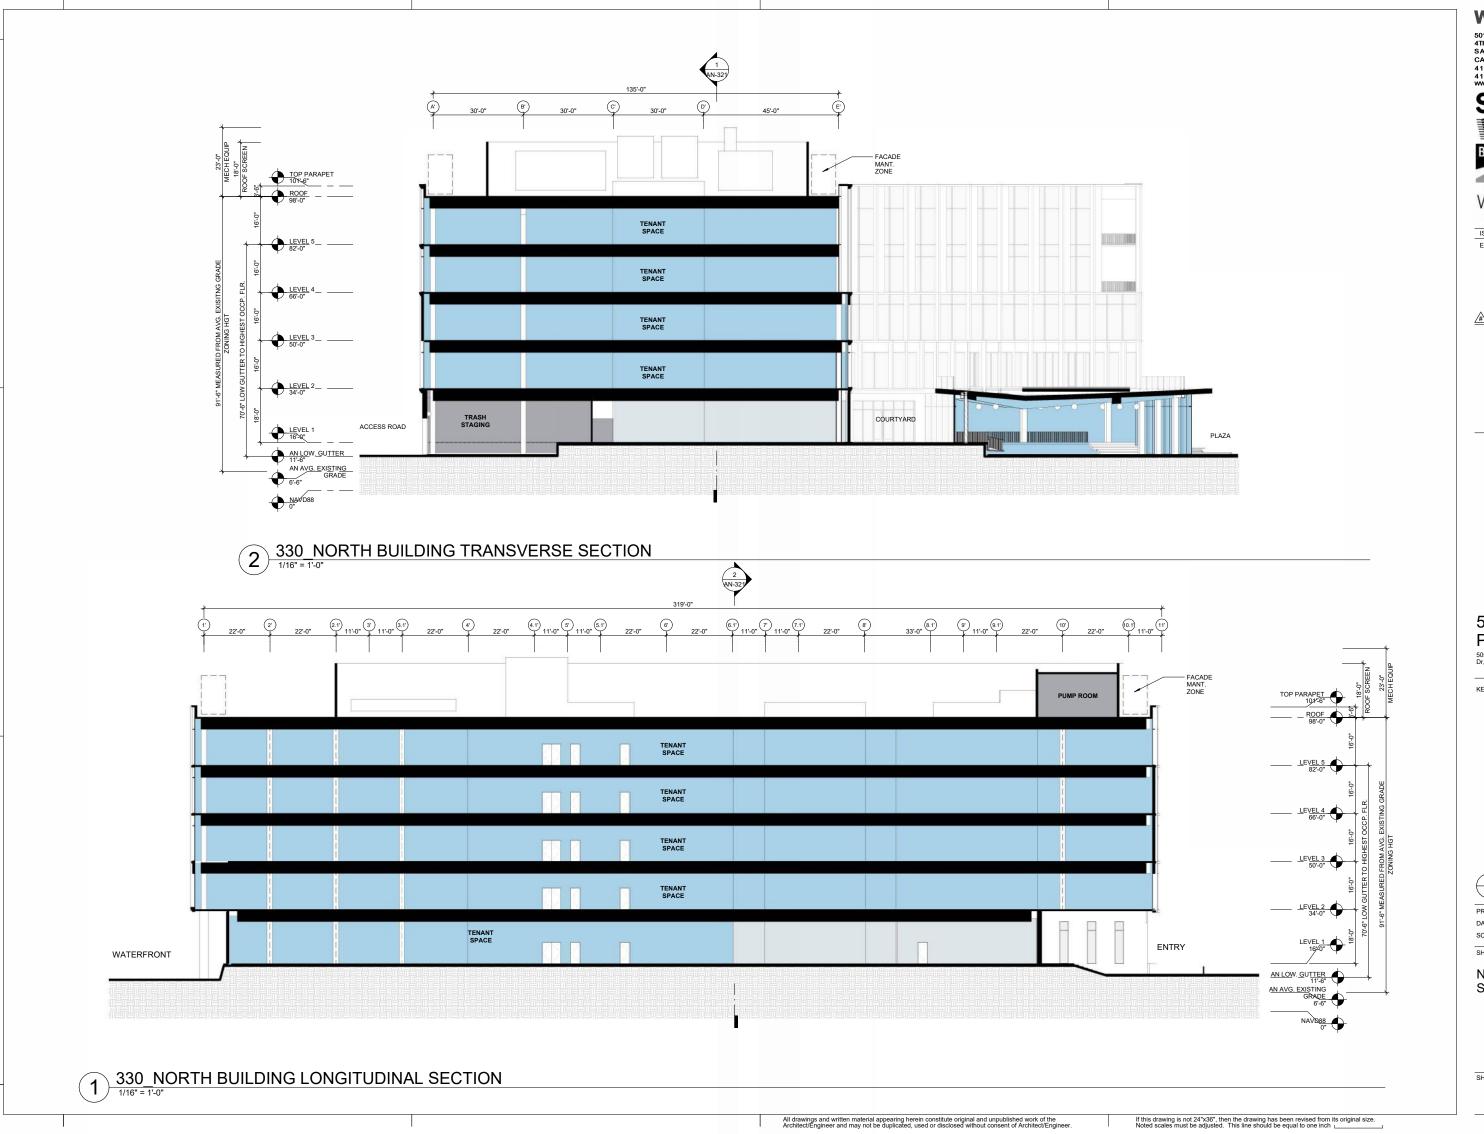

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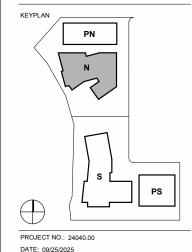
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ISSUES	DATE
ENTITLEMENT APPLICATION	09/25/2025

REVISION LIST DA

505 PENOBSCOT PROJECT

505 Penobscot Dr, 301 Penobscot Dr and 701 Gal




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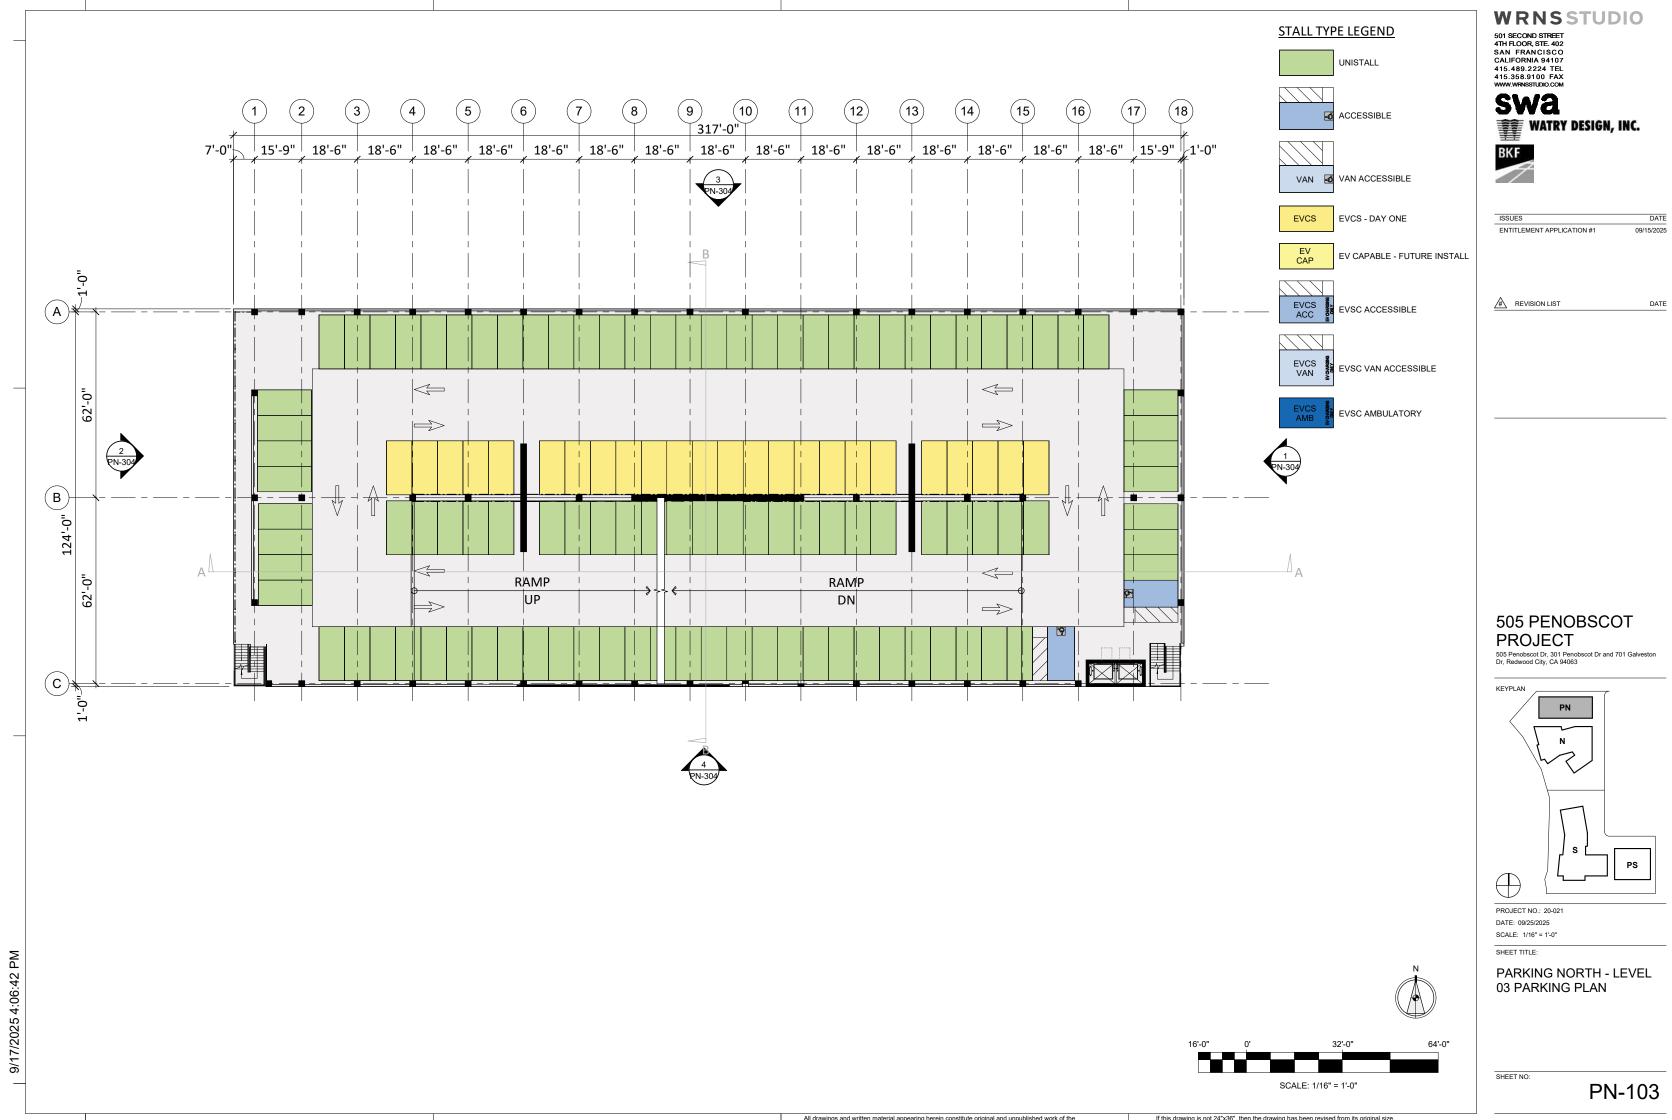
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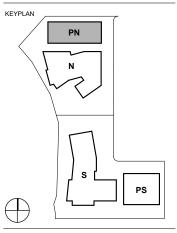
NORTH BUILDING SECTIONS


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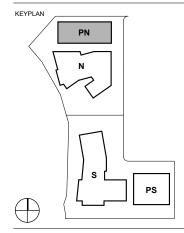










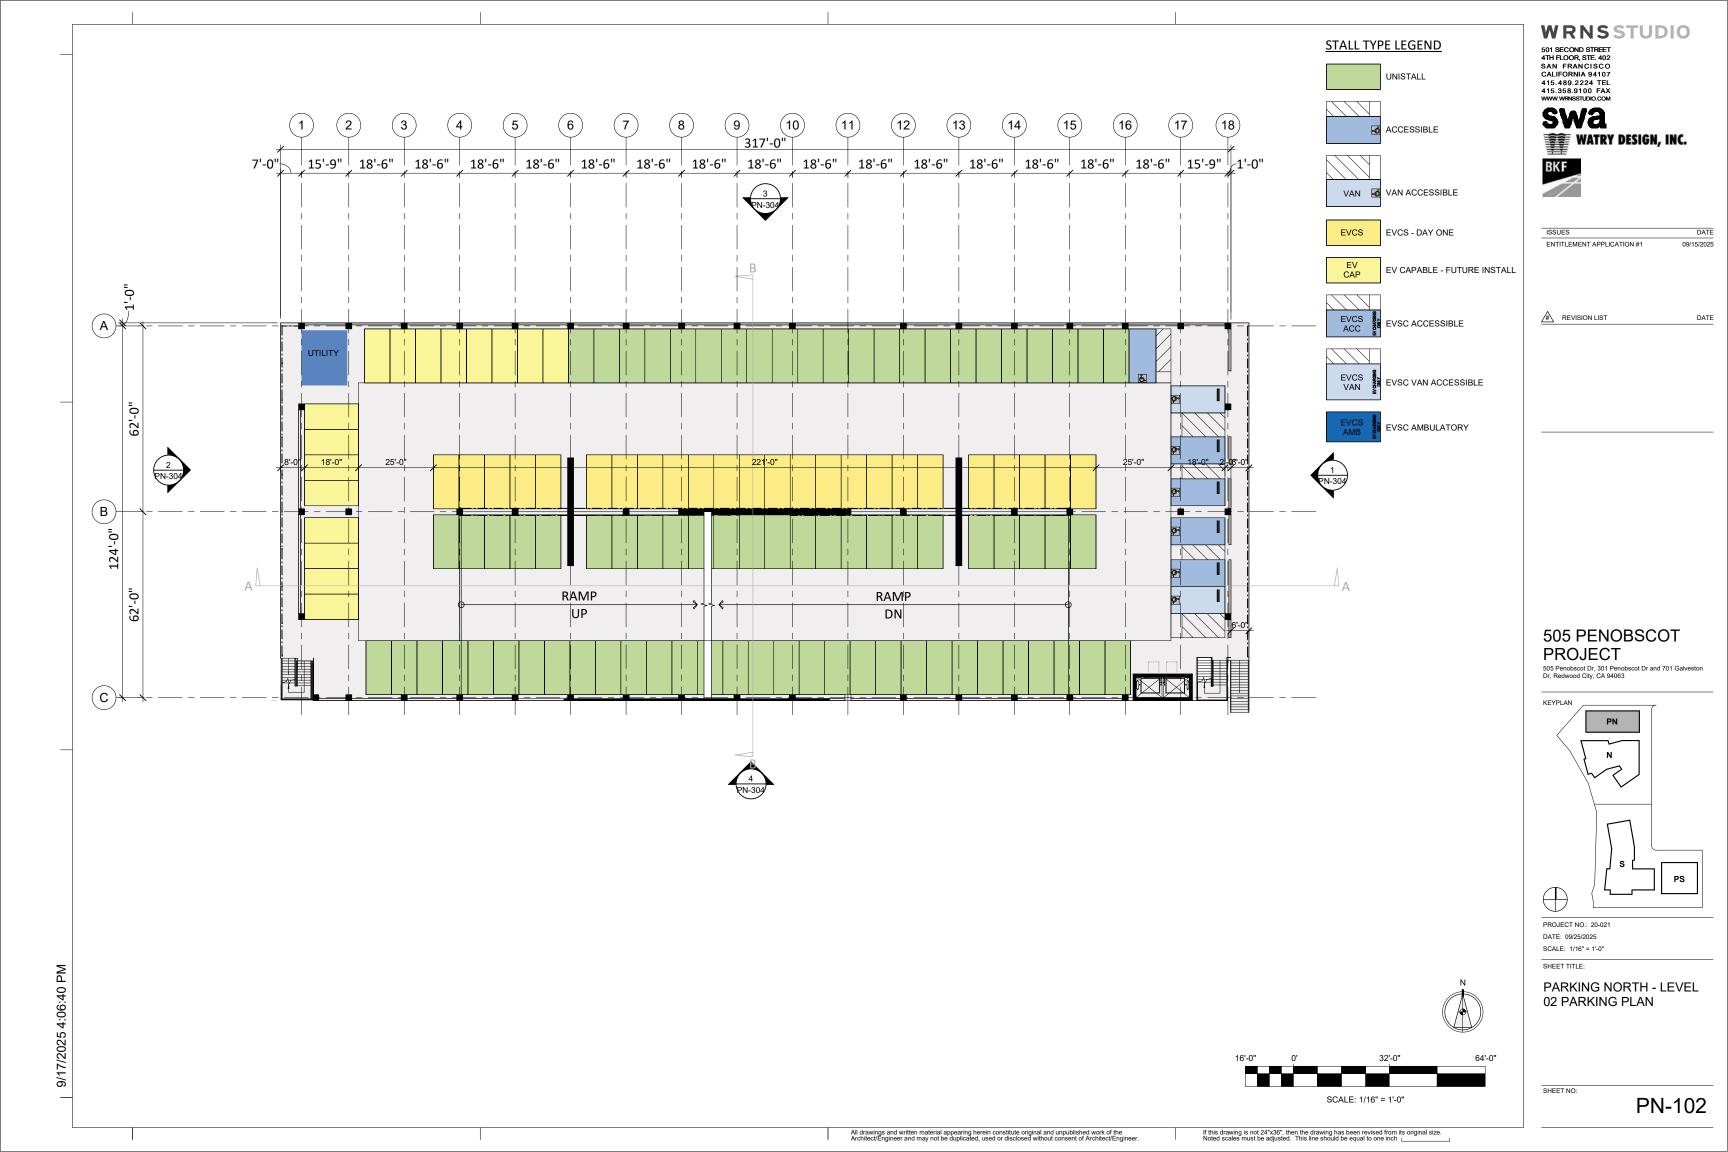


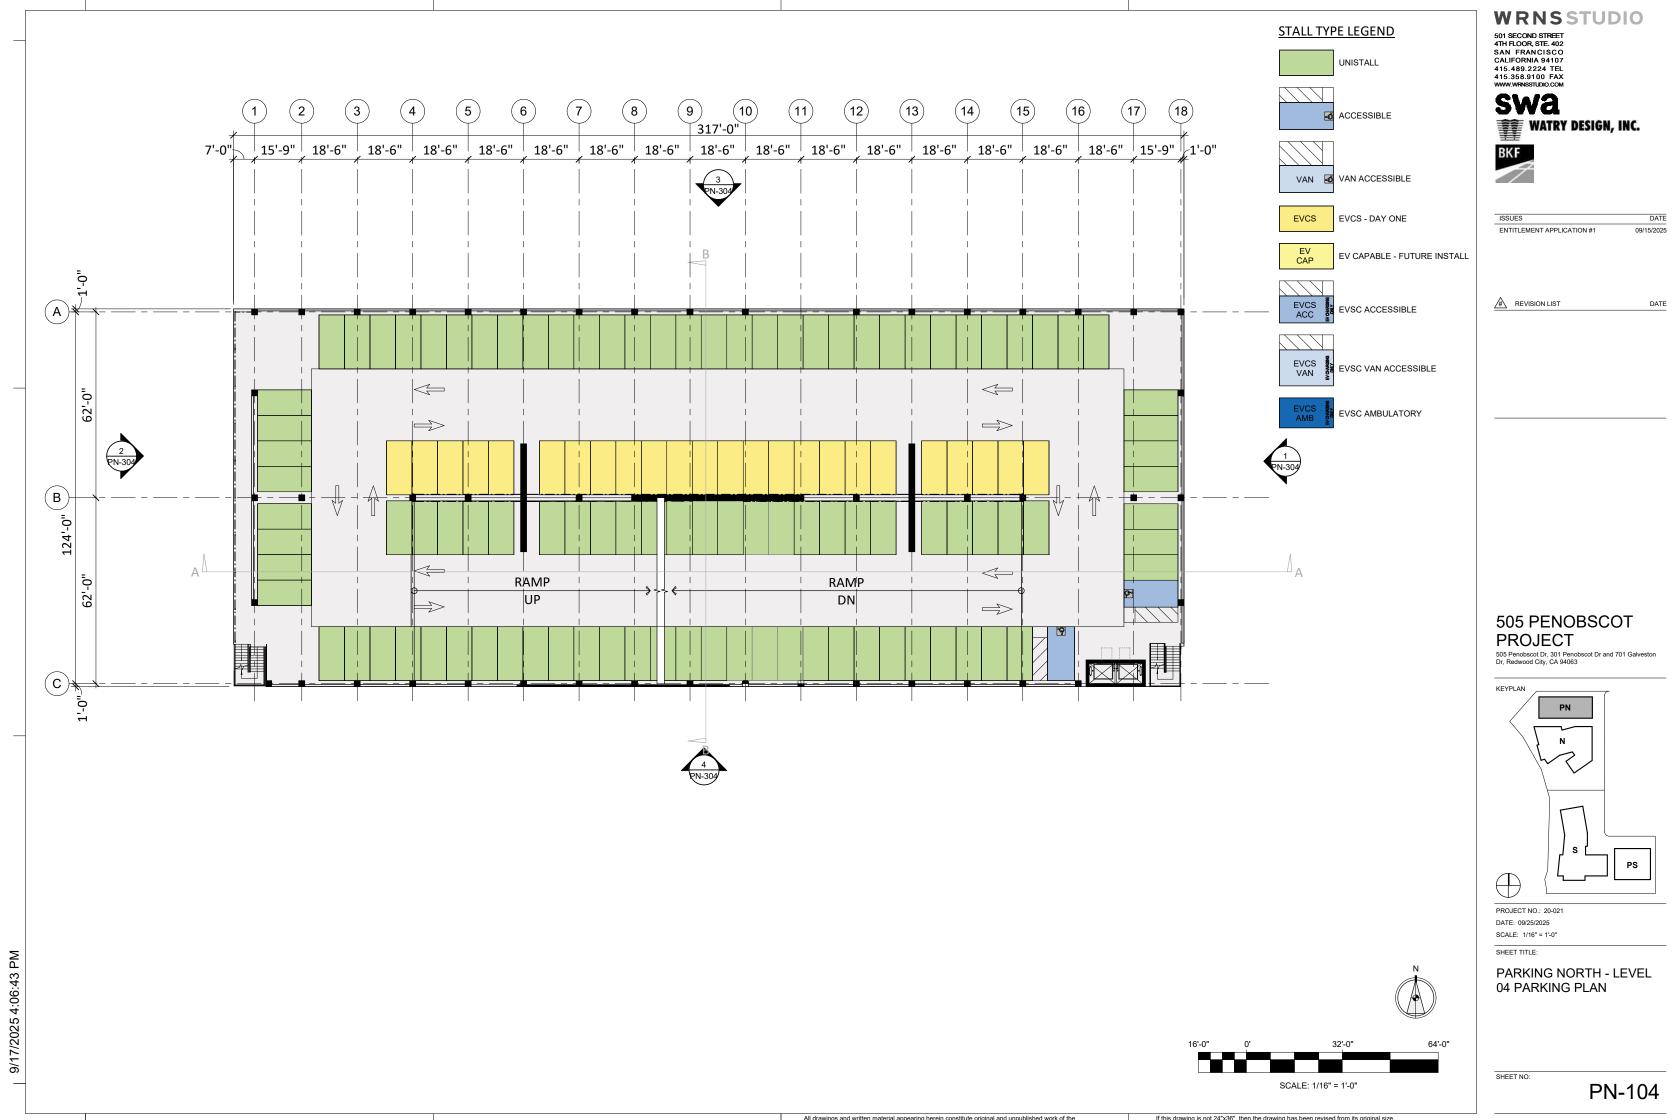

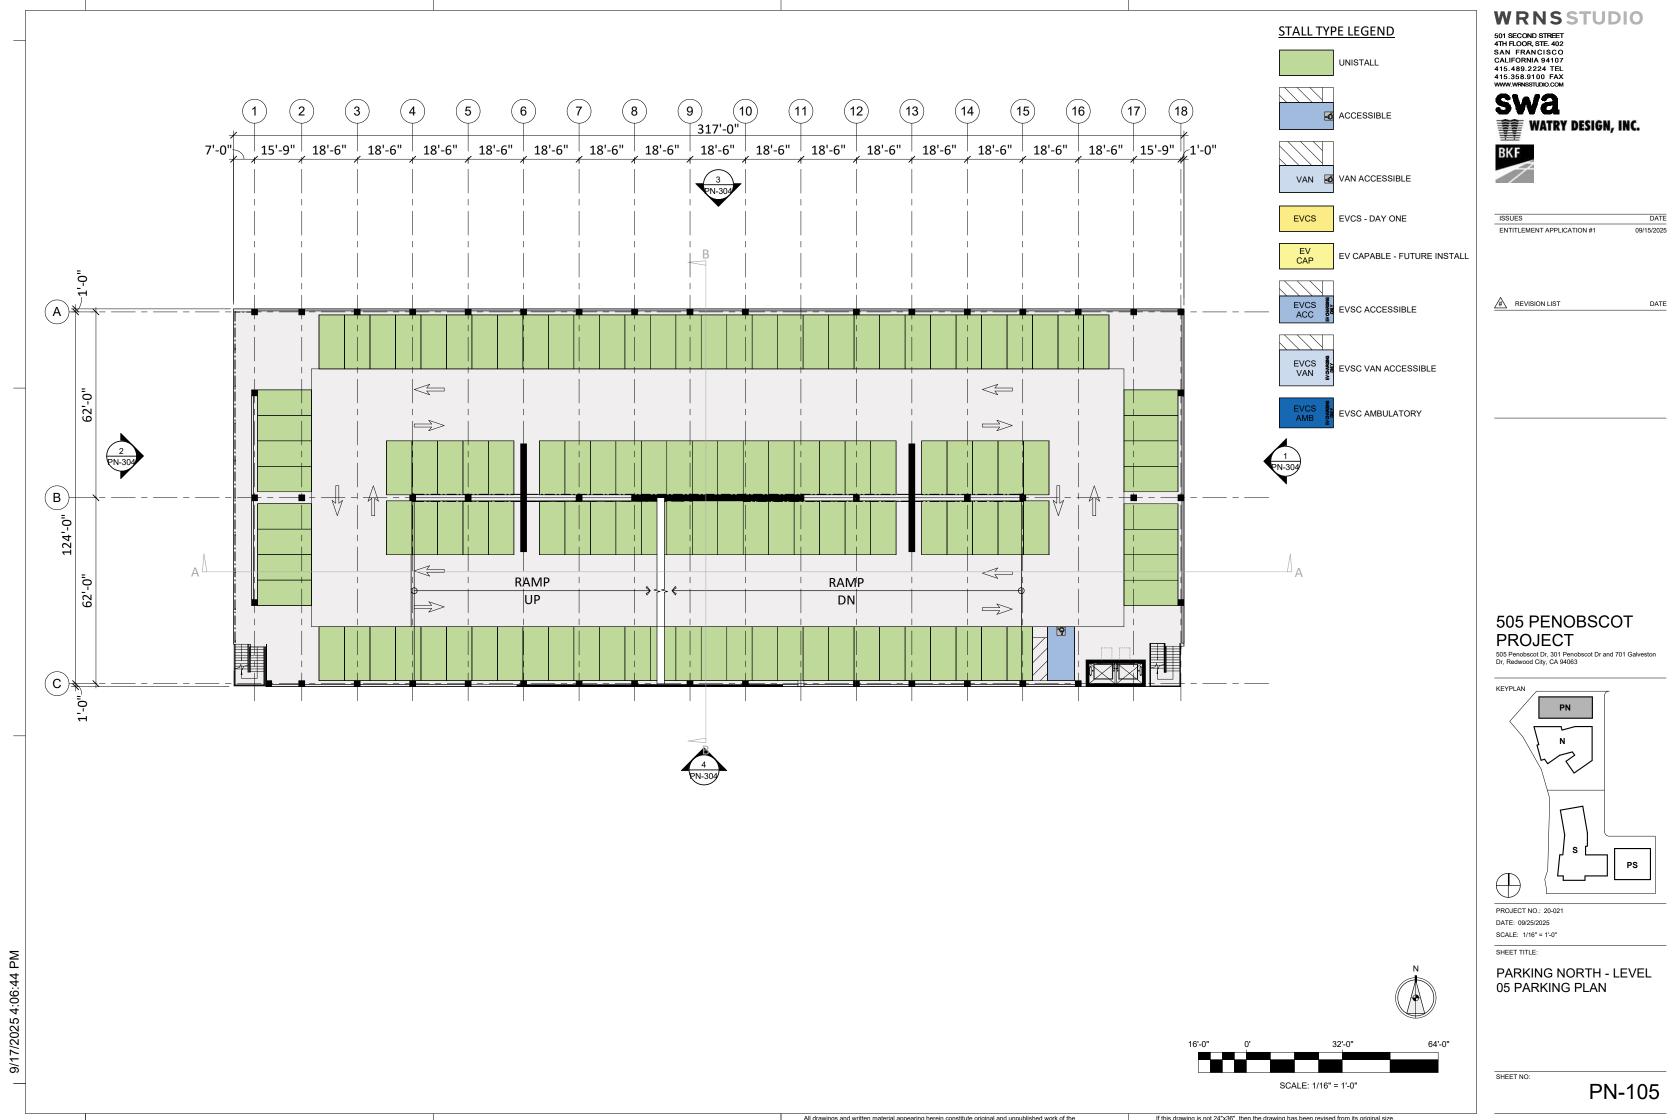

09/15/2025

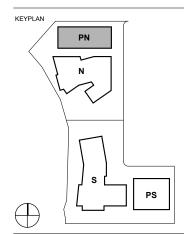

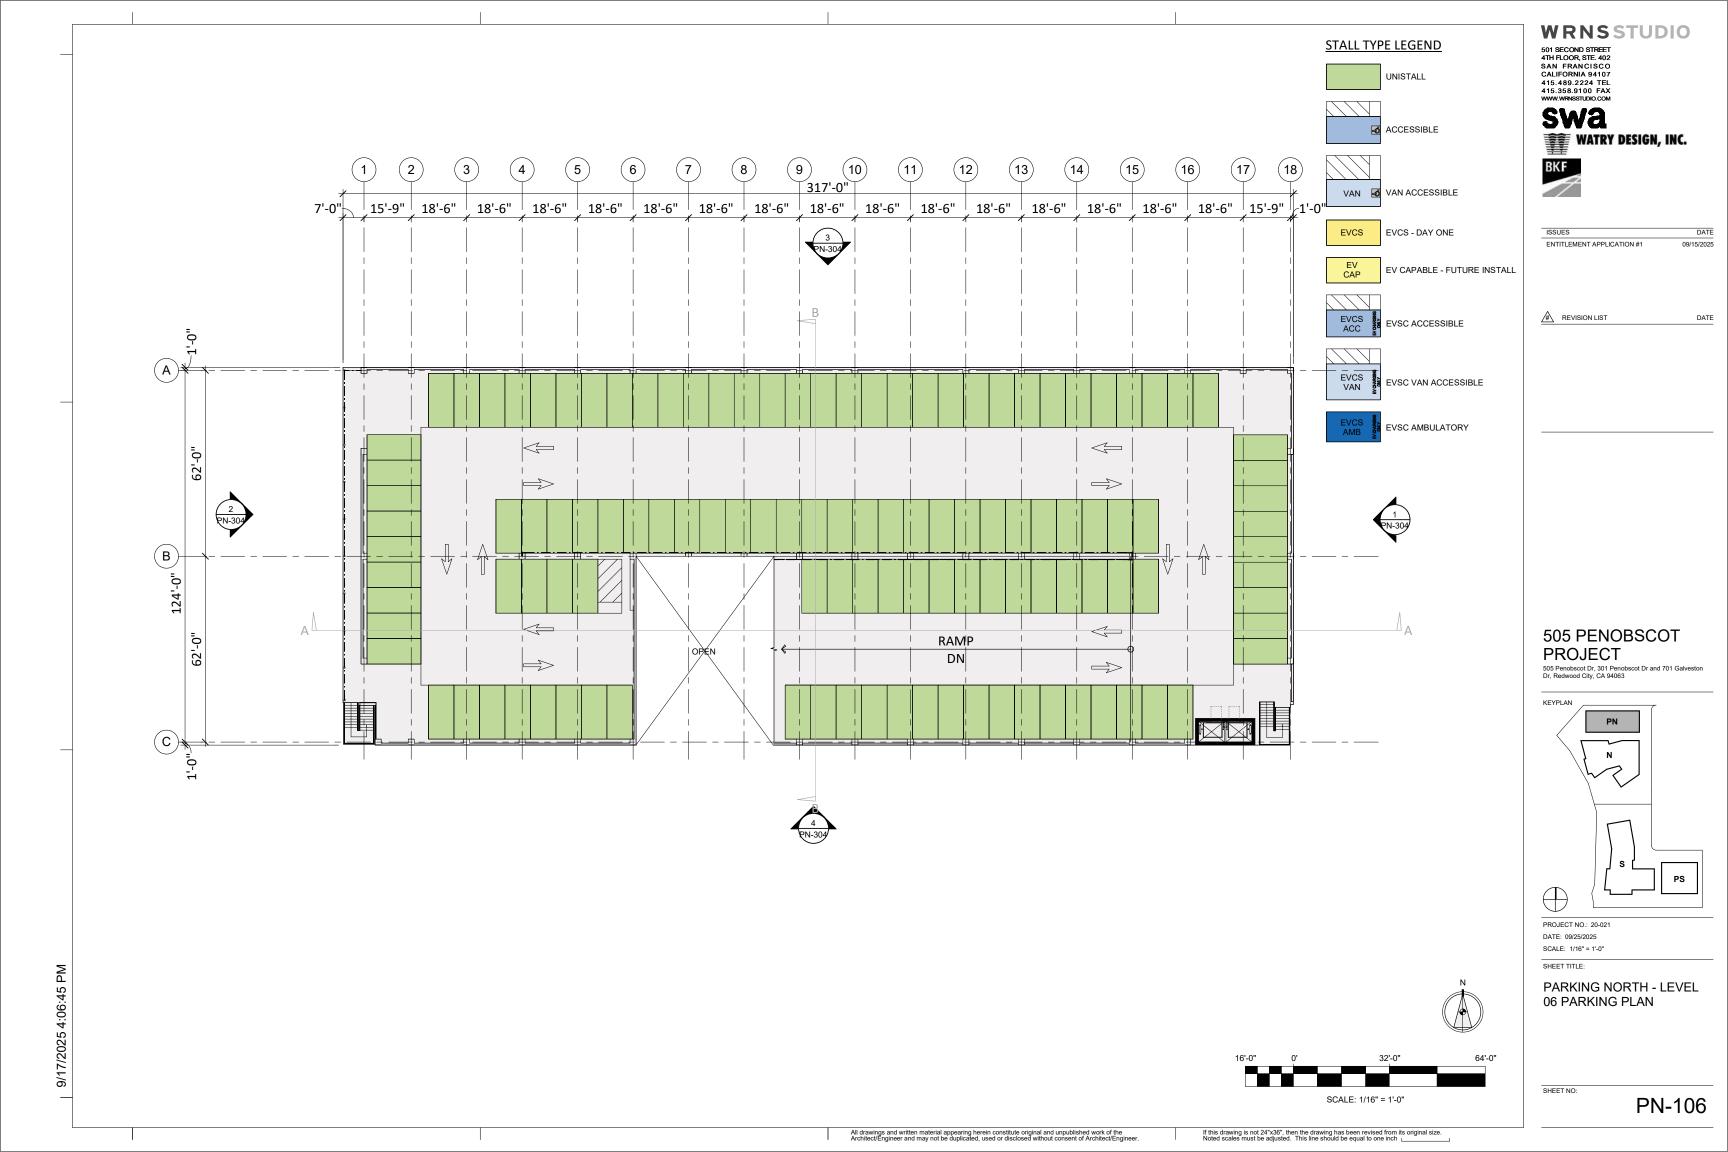



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WRNSSTUDIO

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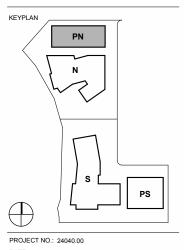


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ISSUES ENTITLEMENT APPLICATION

REVISION LIST

505 PENOBSCOT PROJECT




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SHEET TITLE:

NORTH PARKING -**EXTERIOR ELEVATION**

SHEET NO:


PN-304

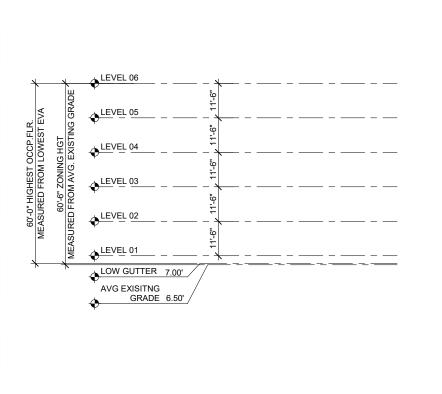


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T.O. 9.5

A LONGITUDINAL SECTION



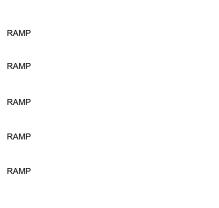

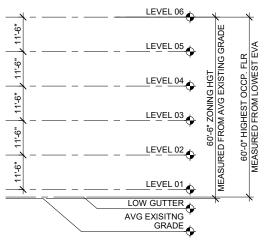(B) TRANSVERSE SECTION

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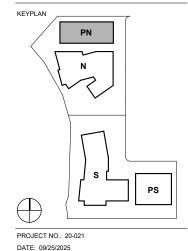
ISSUES DATE
ENTITLEMENT APPLICATION #1 09/15/2025

DATE

REVISION LIST

505 PENOBSCOT PROJECT

505 Penobscot Dr, 301 Penobscot Dr and 701 Galve:




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SHEET TITLE:

PARKING NORTH -BUILDING SECTION

SHEET NO:

PN-330

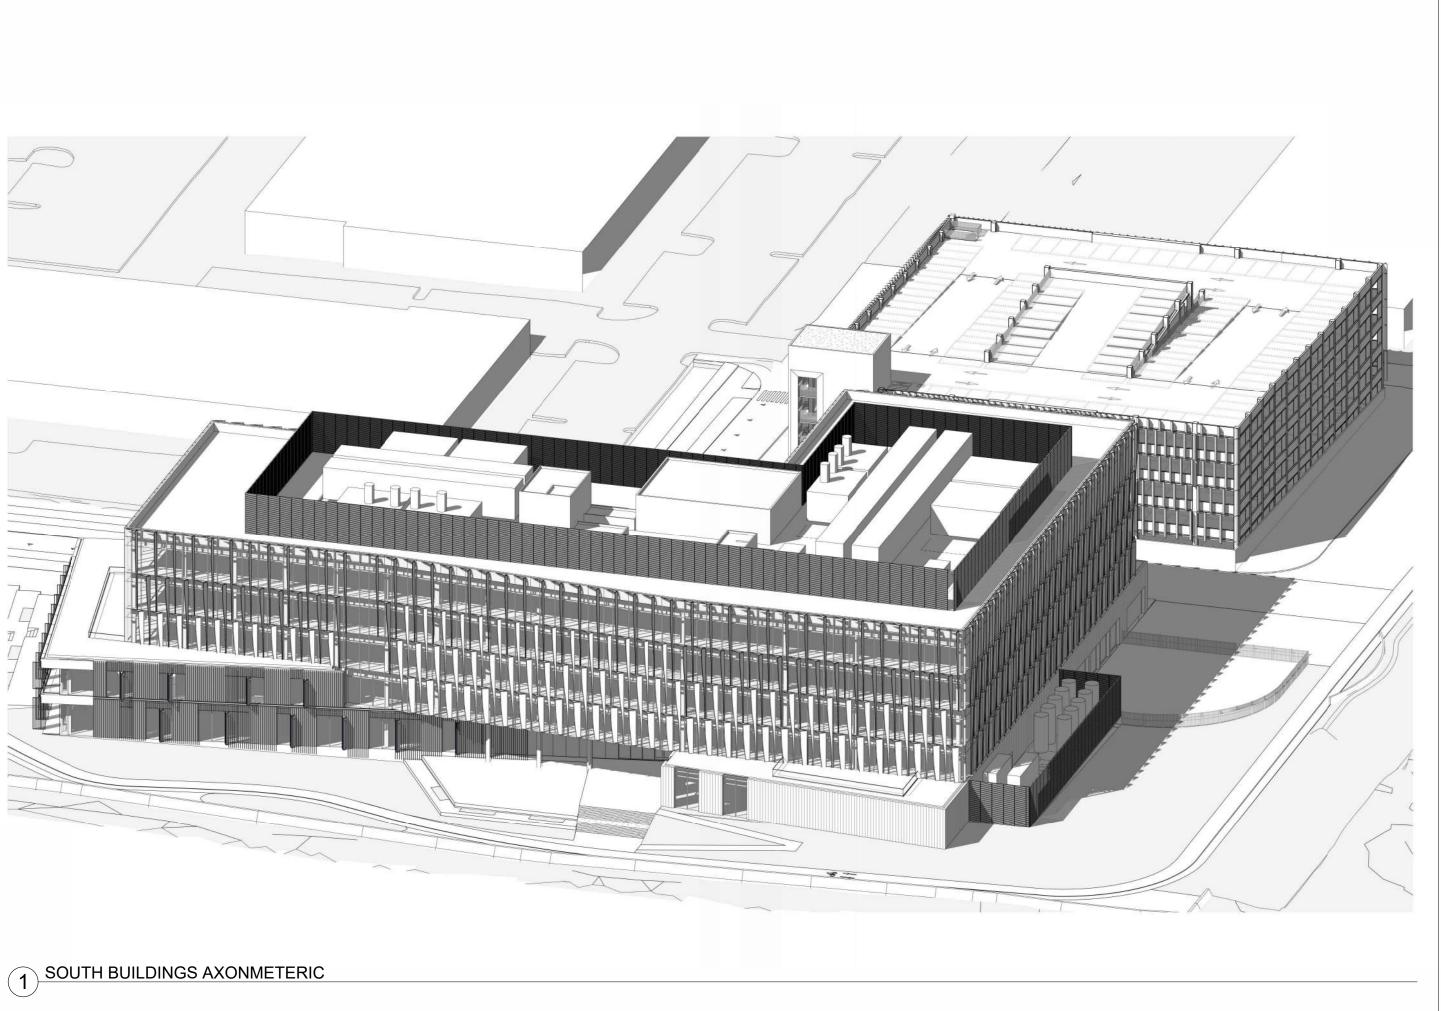

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WRNSSTUDIO

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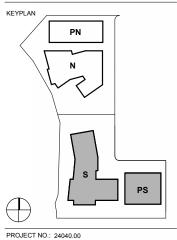
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ISSUES	DATE
ENTITI EMENT APPLICATION	09/25/2025

#	REVISION LIST	DATE
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505 PENOBSCOT PROJECT

505 Penobscot Dr, 301 Penobscot Dr and 701 Galve Dr, Redwood City, CA 94063




PROJECT NO.: 24040.00 DATE: 09/25/2025 SCALE:

SHEET TITLE:

SOUTH BUILDINGS AXON

SHEET NO:

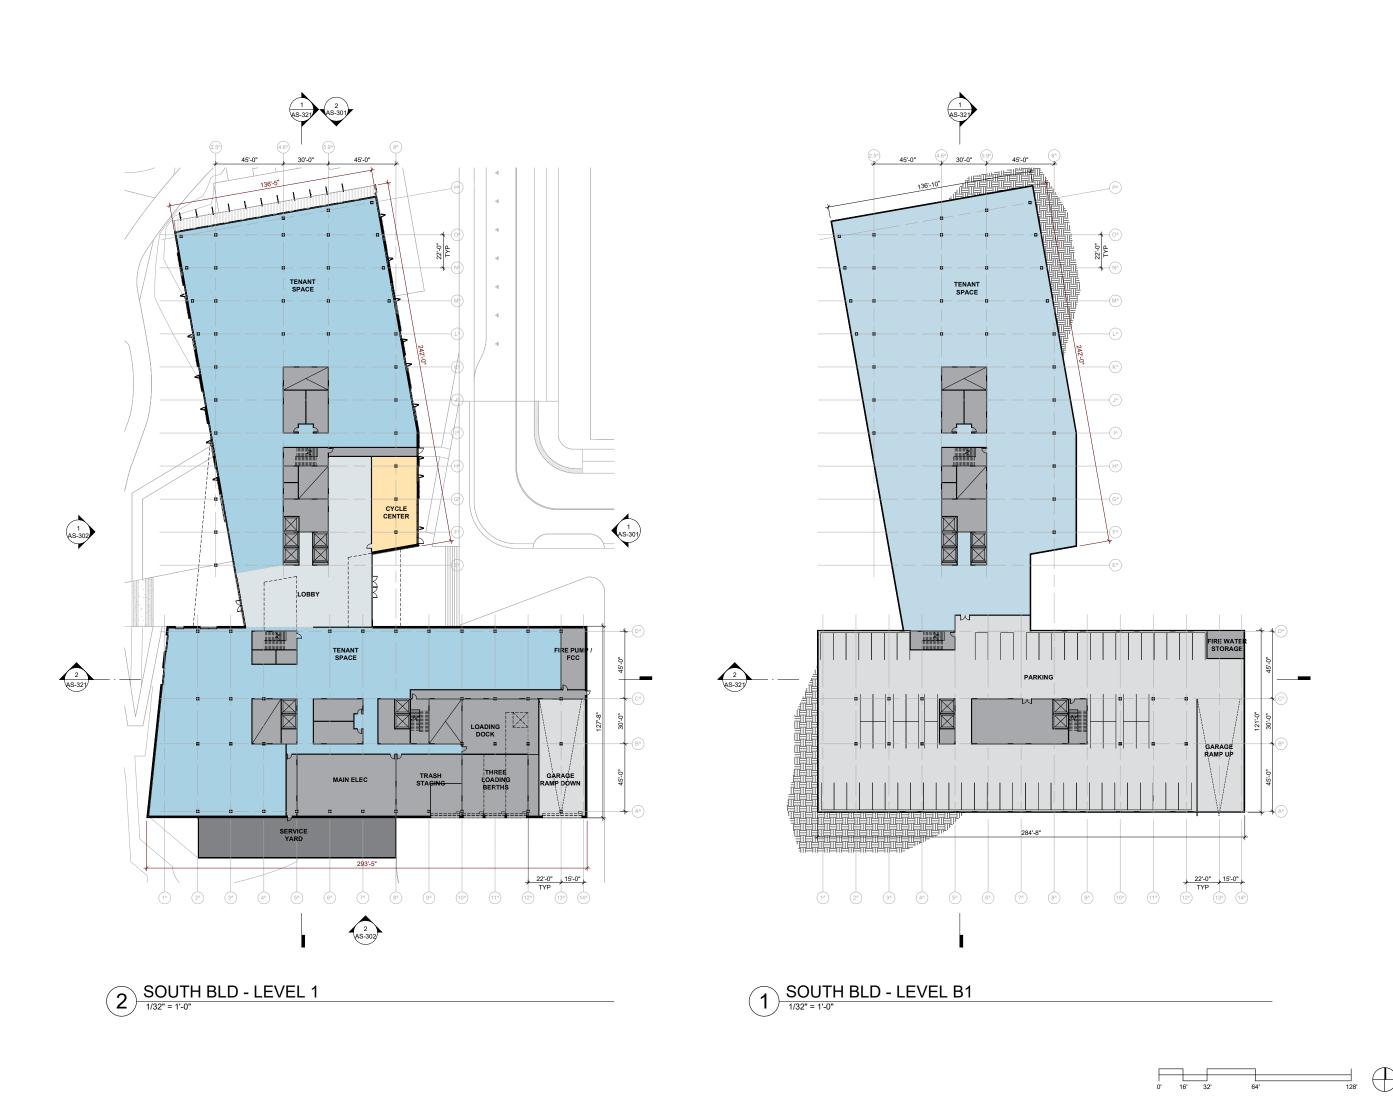

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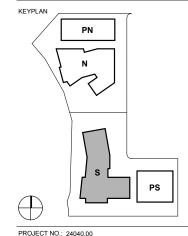
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ISSUES	DATE
ENTITLEMENT APPLICATION	09/25/2025

REVISION LIST DATE

505 PENOBSCOT PROJECT

505 Penobscot Dr, 301 Penobscot Dr and 701 Galveston Dr, Redwood City, CA 94063



PROJECT NO.: 24040.00 DATE: 09/25/2025 SCALE: 1/32" = 1'-0"

SHEET TITLE:

SOUTH BUILDING FLOOR PLANS

SHEET NO:



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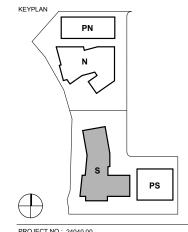
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ISSUES	DATE
ENTITLEMENT APPLICATION	09/25/2025

REVISION LIST DATE

505 PENOBSCOT PROJECT

505 Penobscot Dr, 301 Penobscot Dr and 701 Galvestor Dr, Redwood City, CA 94063




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SHEET TITLE:

SOUTH BUILDING FLOOR PLANS

SHEET NO:

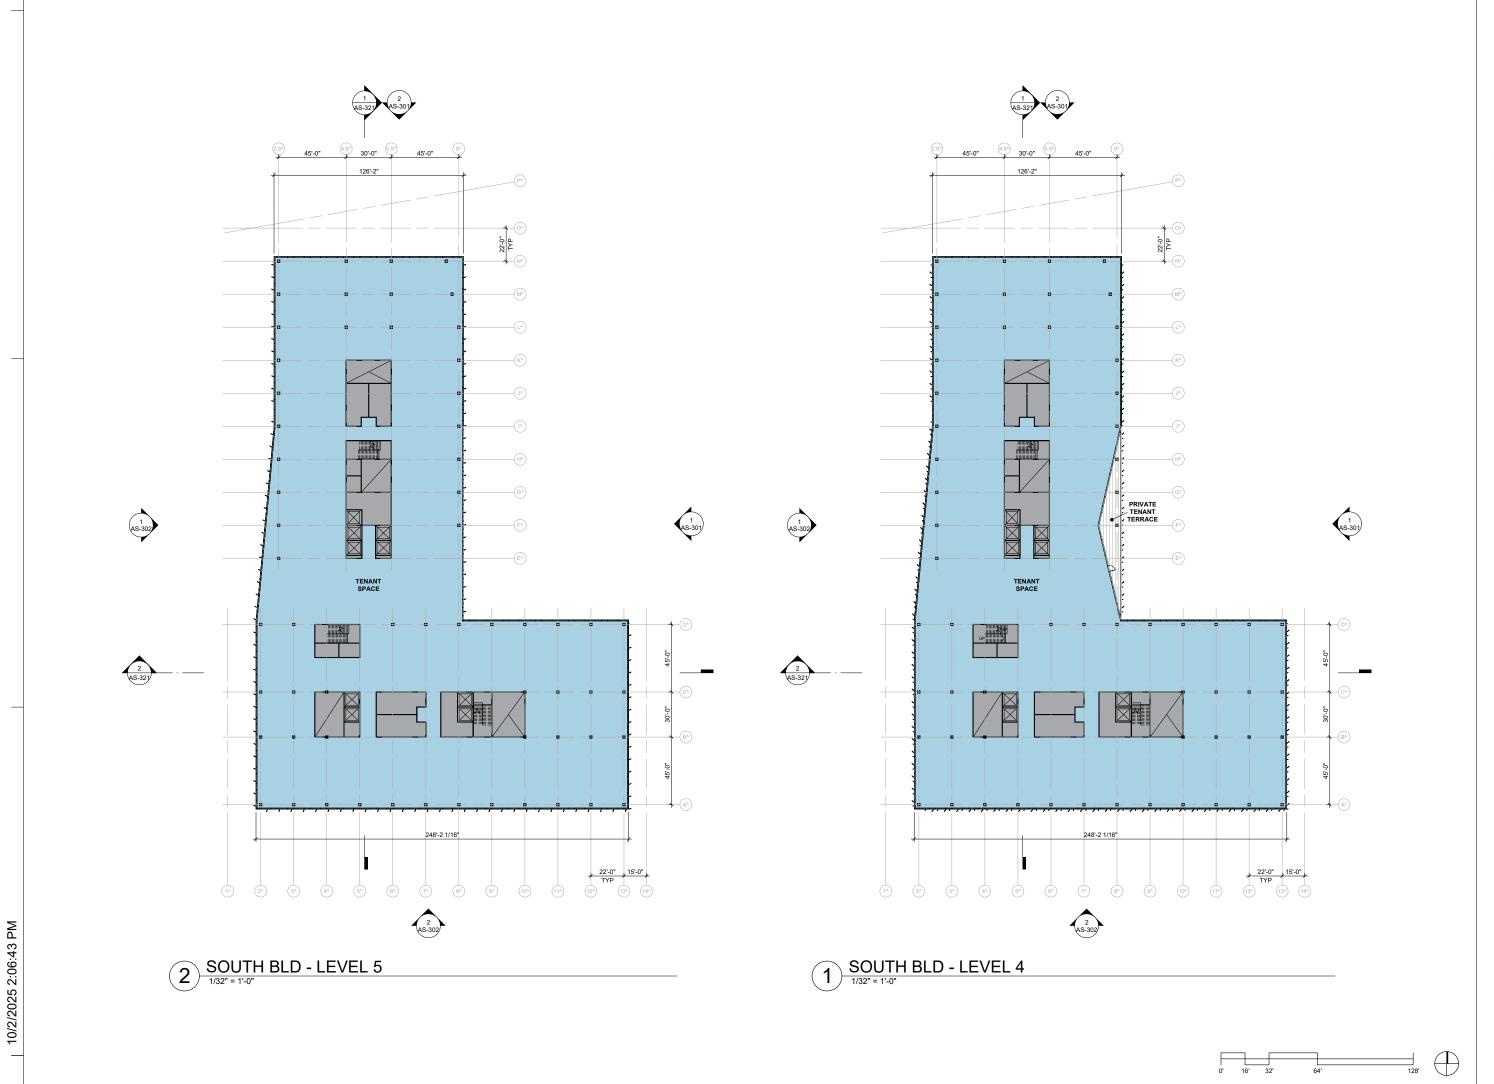

501 SECOND STREET 4TH FLOOR, STE. 402 SAN FRANCISCO CALIFORNIA 94107 415.489.2224 TEL 415.358.9100 FAX WWW.WRNSSTUDIO.COM

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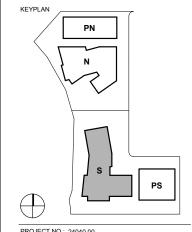
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ISSUES	DATE
ENTITLEMENT APPLICATION	09/25/2025

REVISION LIST DAT

505 PENOBSCOT PROJECT

505 Penobscot Dr, 301 Penobscot Dr and 701 Galveston Dr, Redwood City, CA 94063




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SOUTH BUILDING FLOOR PLANS

SHEET NO:



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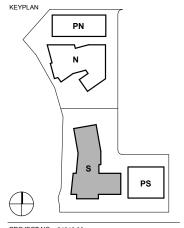
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505 PENOBSCOT PROJECT

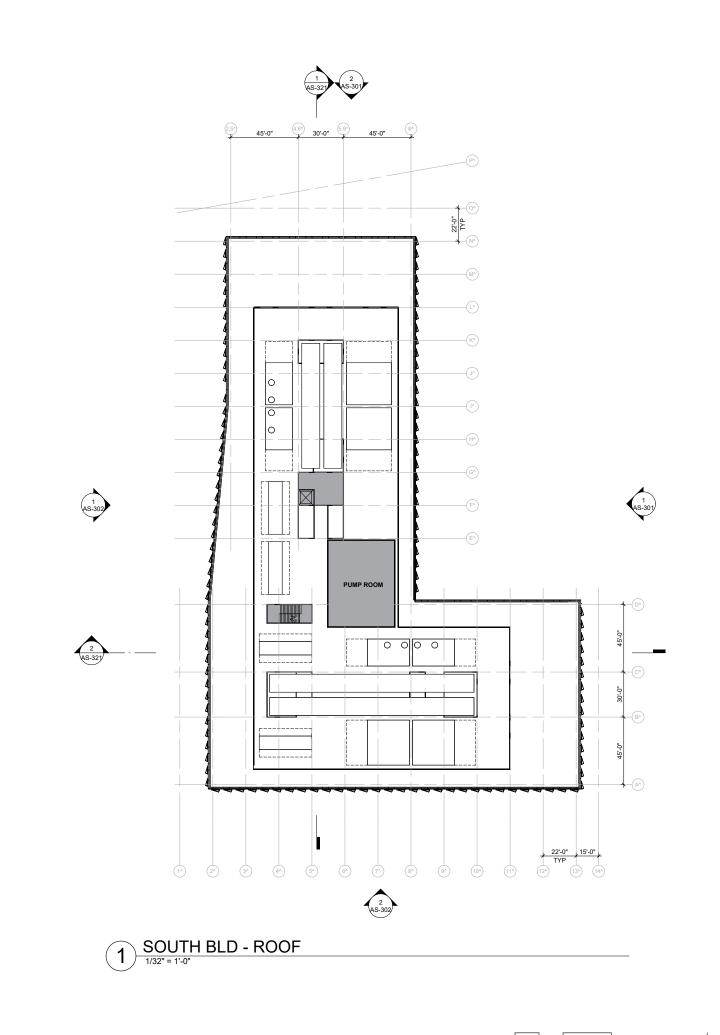505 Penobscot Dr, 301 Penobscot Dr and 701 Galveston Dr, Redwood City, CA 94063



PROJECT NO.: 24040.00 DATE: 09/25/2025 SCALE: 1/32" = 1'-0"

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SOUTH BUILDING FLOOR PLANS

SHEET NO:

AS-104


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ENTITLEMENT APPLICATION 09/25/2025

505 PENOBSCOT




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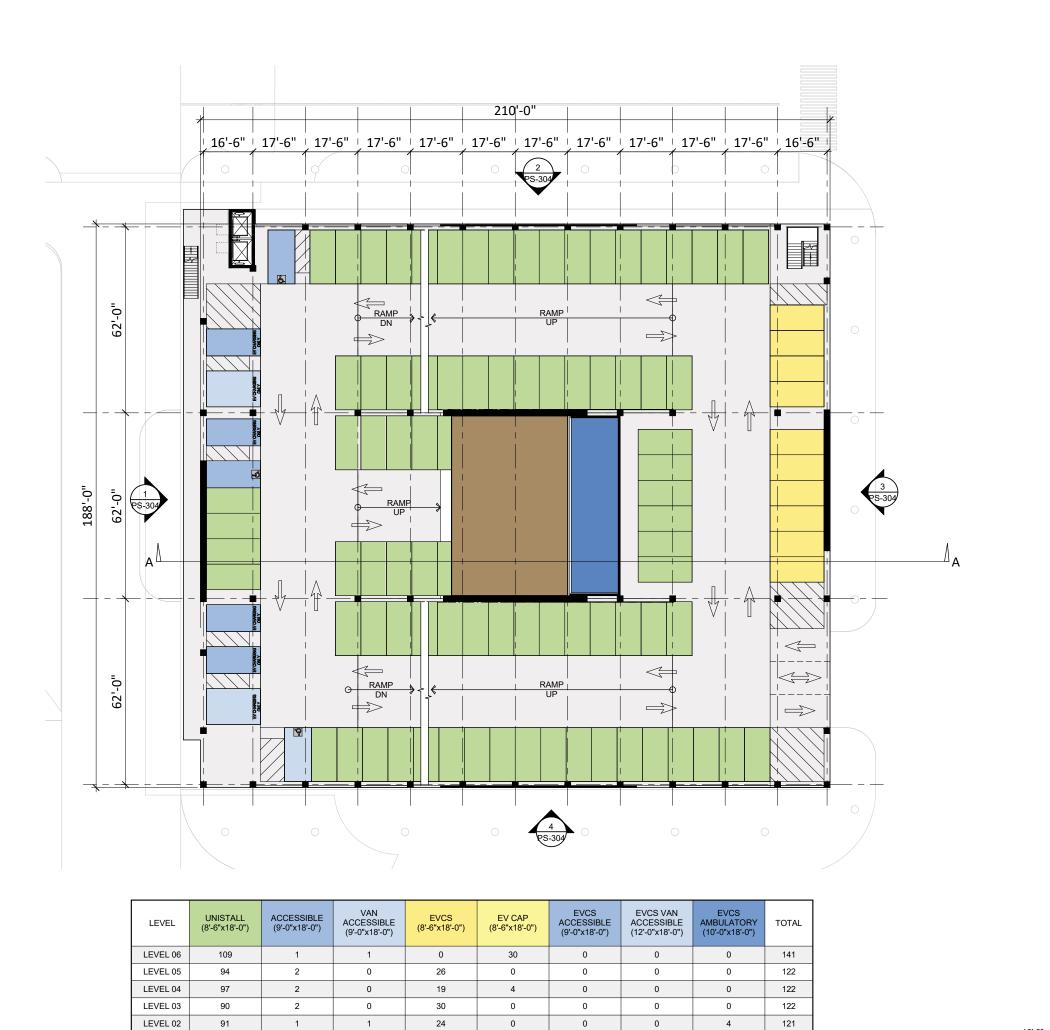
SOUTH BUILDING ELEVATIONS

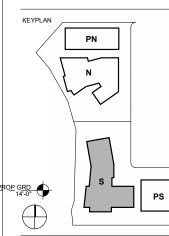

If this drawing is not 24"x36", then the drawing has been revised from its original size. Noted scales must be adjusted. This line should be equal to one inch ${}_{\rm L}$

09/25/2025



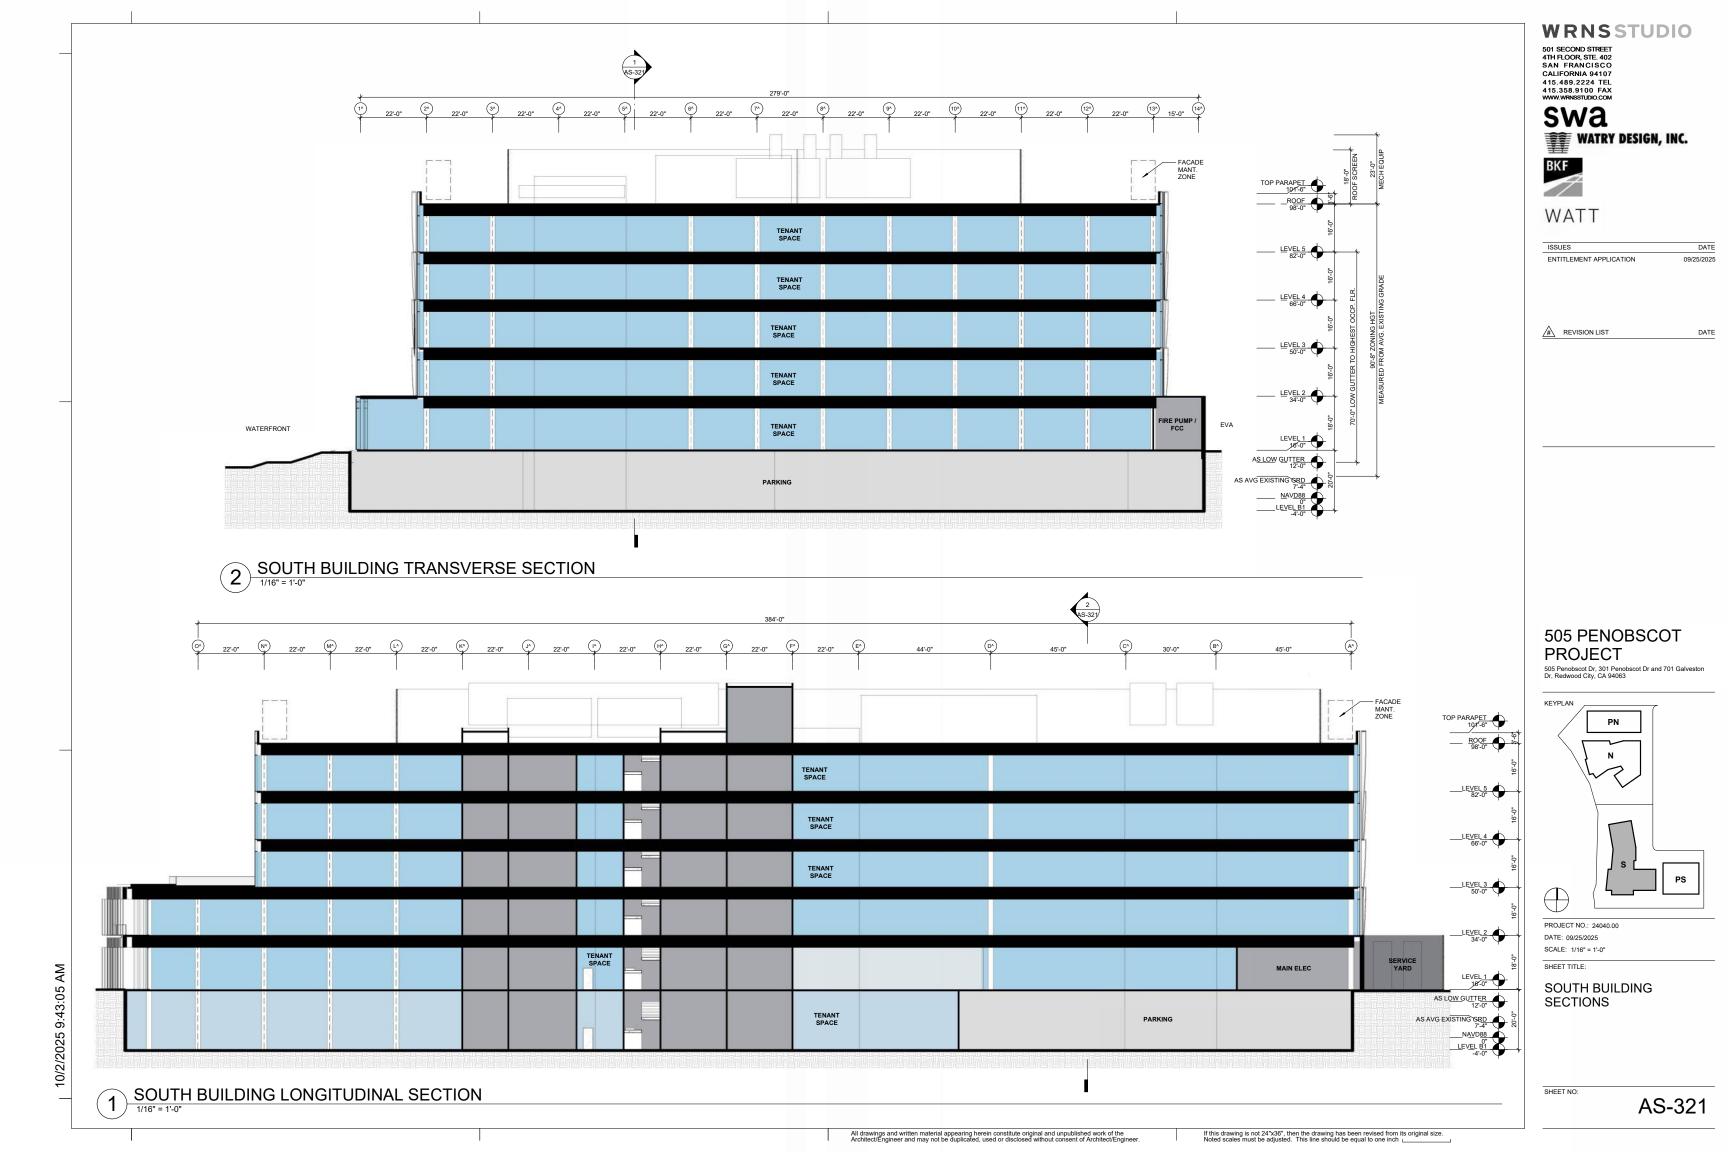

10

109

9/17/2025 4:08:16 PM

LEVEL 01

TOTAL

561

STALL TYPE LEGEND



UNISTALL





EVCS EVCS - DAY ONE

EV CAP EV CAPABLE - FUTURE INSTALL





EVCS AMBULATORY

WRNSSTUDIO

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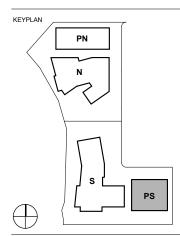
swa **WATRY DESIGN, INC.**



ISSUES	DATE
ENTITLEMENT APPLICATION #1	09/15/2025

REVISION LIST DATE

505 PENOBSCOT PROJECT



PROJECT NO.: 20-021 DATE: 09/25/2025 SCALE: 1/16" = 1'-0"

SHEET TITLE:

PARKING SOUTH - LEVEL 01 PARKING PLAN


SHEET NO:

PS-101

99

727

SCALE: 1/16" = 1'-0"

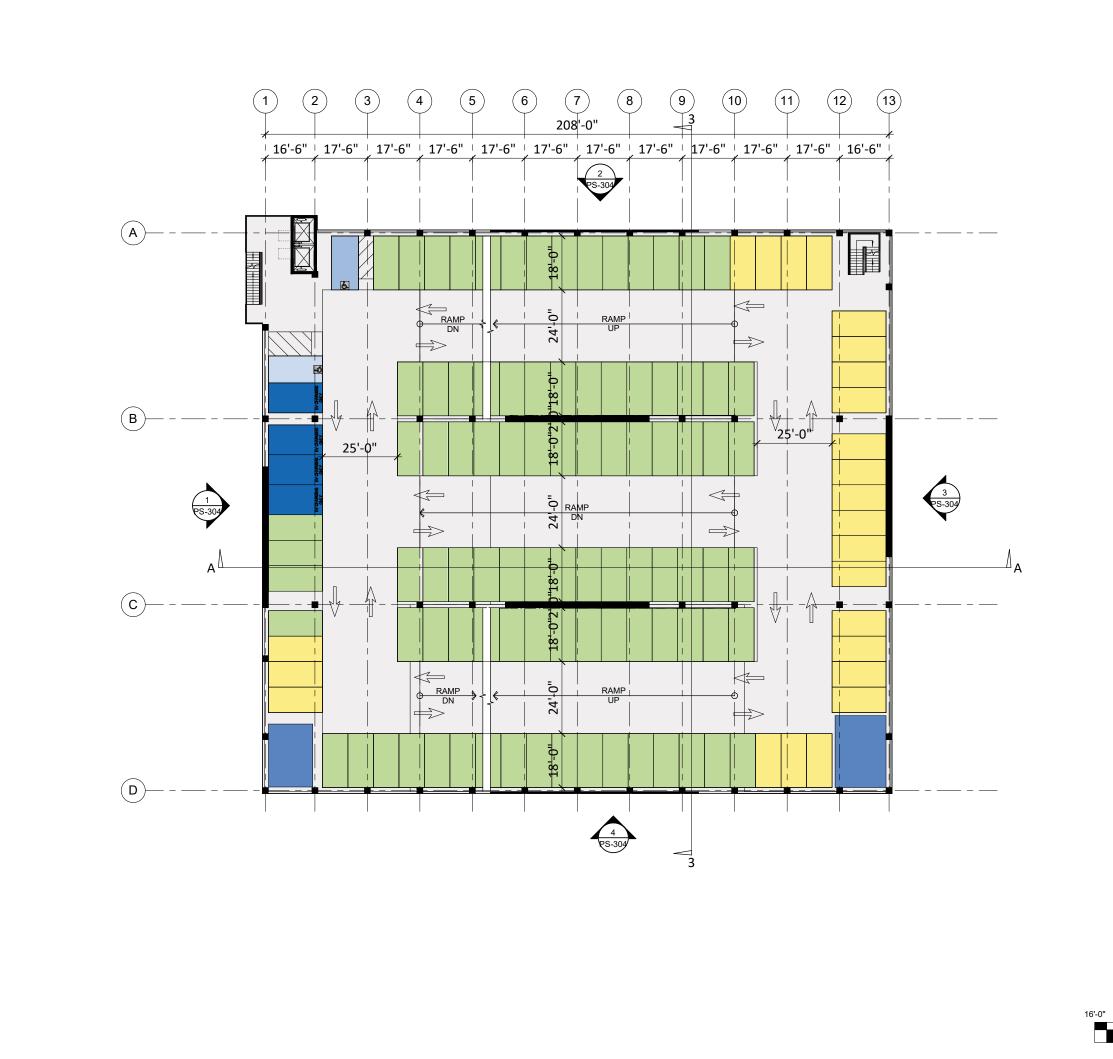

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STALL TYPE LEGEND

UNISTALL



ACCESSIBLE



EVCS - DAY ONE

EV CAPABLE - FUTURE INSTALL





EVCS AMBULATORY

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501 SECOND STREET 4TH FLOOR, STE. 402 SAN FRANCISCO CALIFORNIA 94107 415.489.2224 TEL 415.358.9100 FAX WWW.WRNSSTUDIO.COM


swa **WATRY DESIGN, INC.**



ISSUES ENTITLEMENT APPLICATION #1 09/15/2025

REVISION LIST DATE

505 PENOBSCOT PROJECT

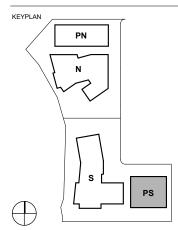

PROJECT NO.: 20-021 DATE: 09/25/2025 SCALE: 1/16" = 1'-0"

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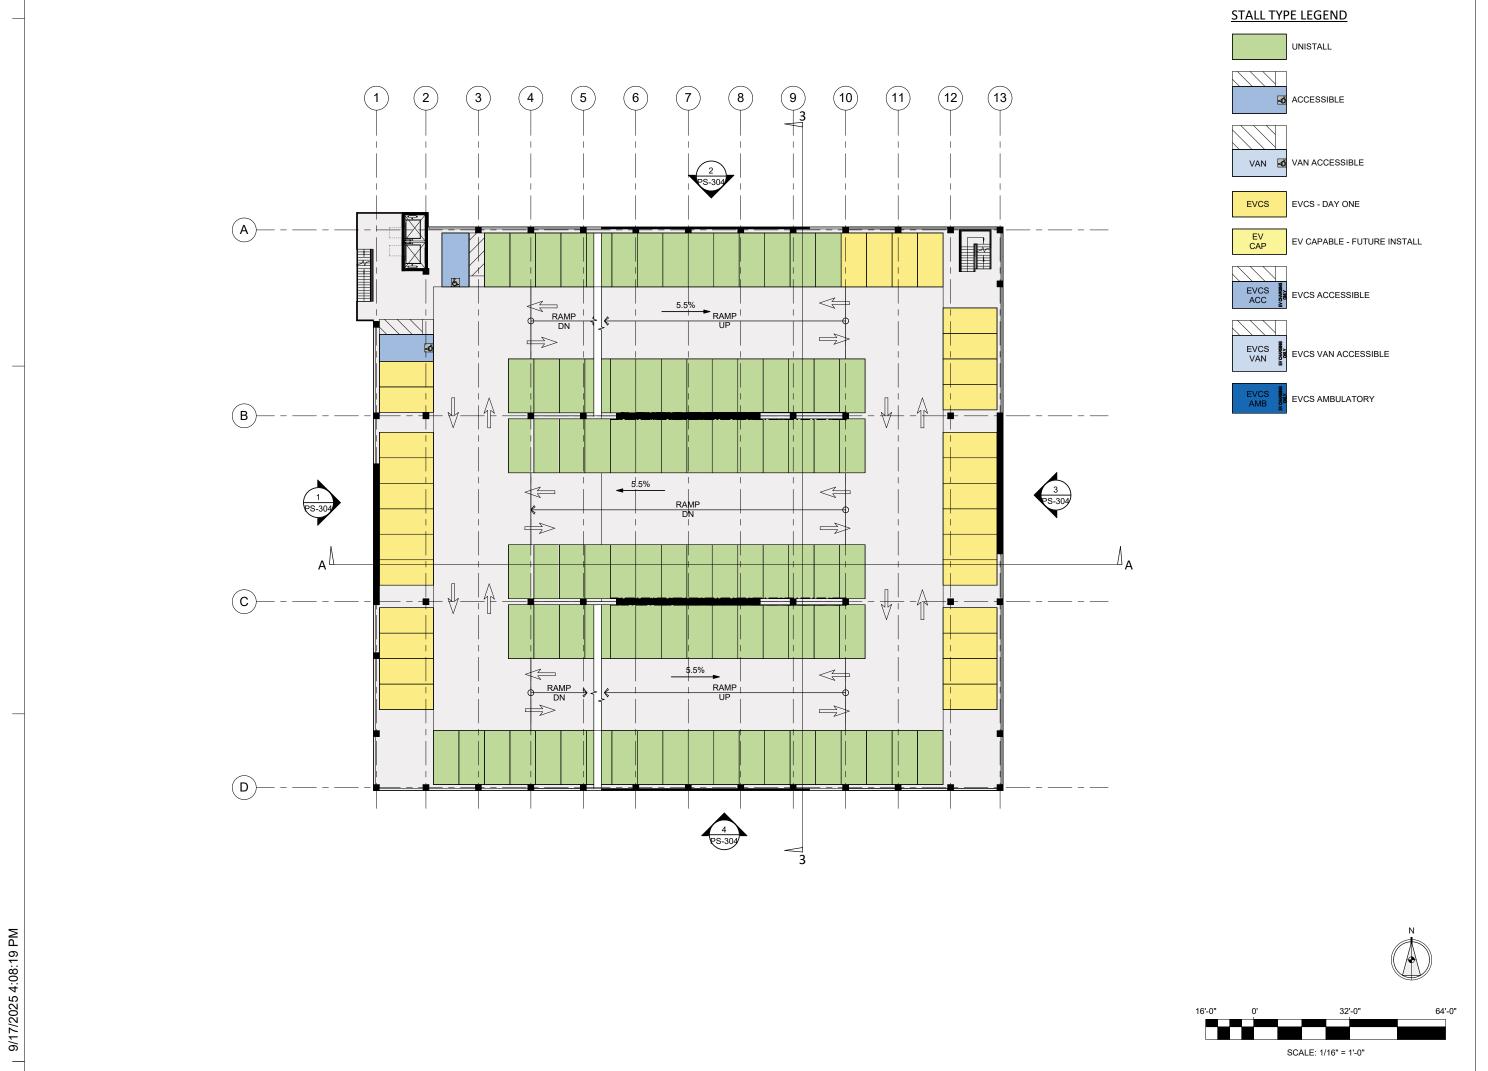
PARKING SOUTH - LEVEL 02 PARKING PLAN

SHEET NO:

64'-0"

PS-102

SCALE: 1/16" = 1'-0"



501 SECOND STREET 4TH FLOOR, STE. 402 SAN FRANCISCO CALIFORNIA 94107 415.489.2224 TEL 415.358.9100 FAX WWW.WRNSSTUDIO.COM

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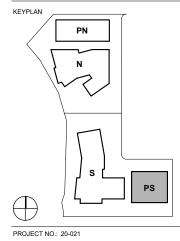


ISSUES	DATE
ENTITLEMENT APPLICATION #1	09/15/2025

REVISION LIST DATE

505 PENOBSCOT PROJECT

505 Penobscot Dr, 301 Penobscot Dr and 701 Galvesto




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SHEET TITLE:

PARKING SOUTH - LEVEL 03 PARKING PLAN

SHEET NO:

PS-103

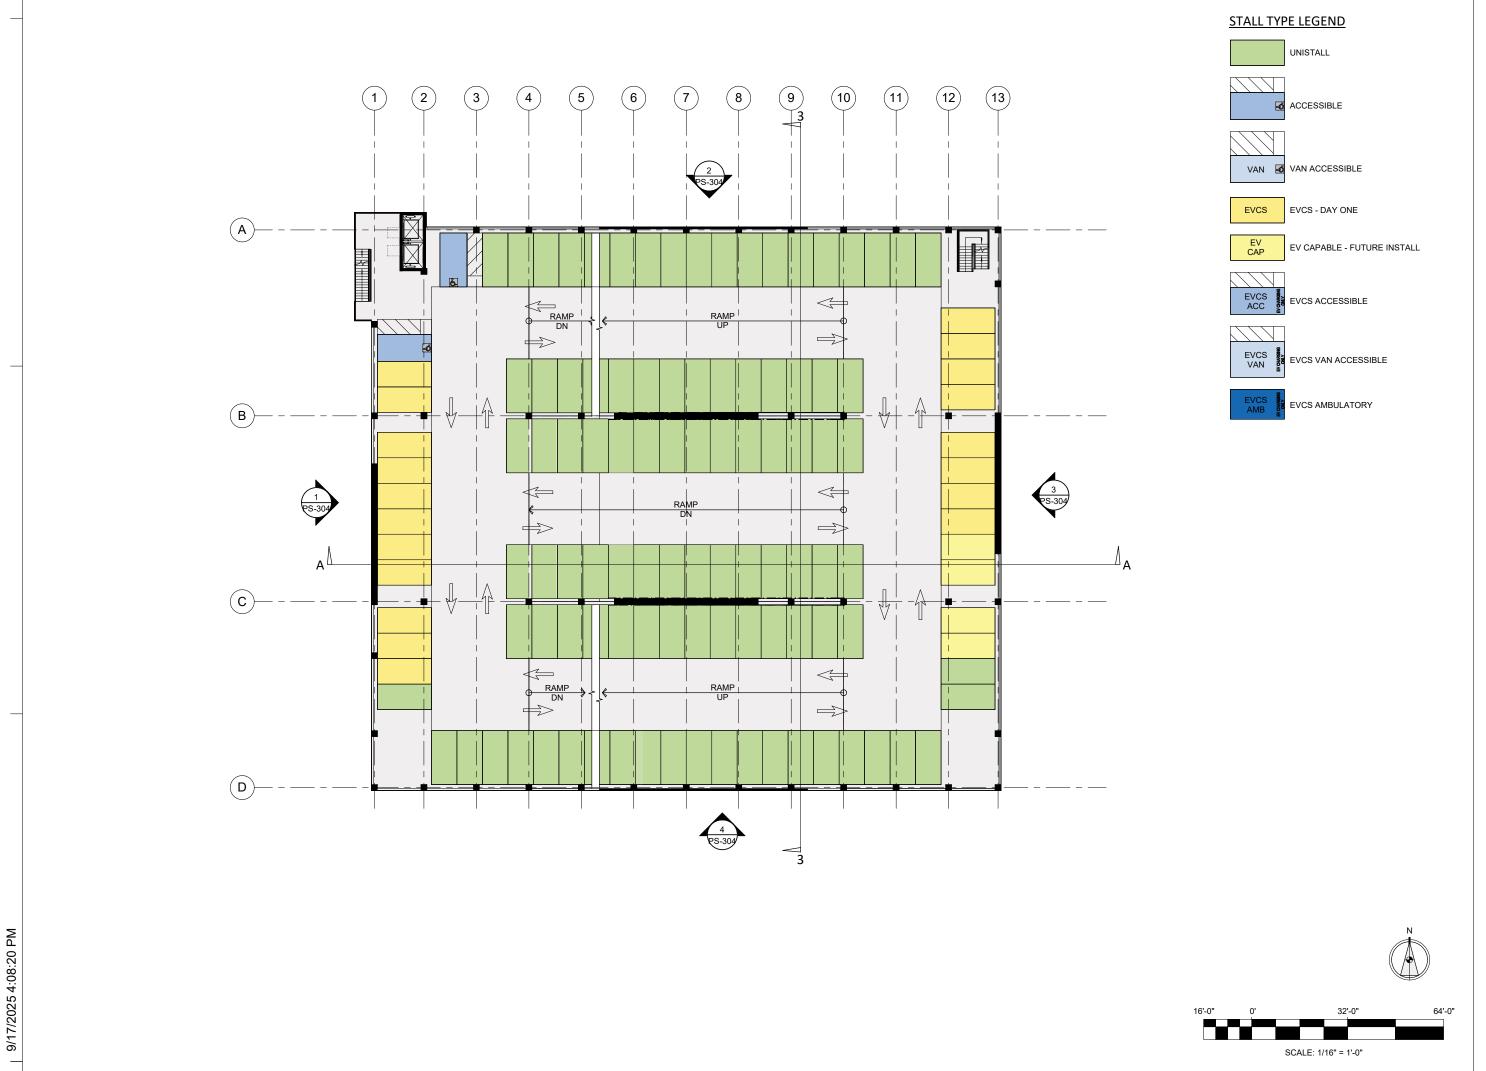

501 SECOND STREET 4TH FLOOR, STE. 402 SAN FRANCISCO CALIFORNIA 94107 415.489.2224 TEL 415.358.9100 FAX WWW.WRNSSTUDIO.COM

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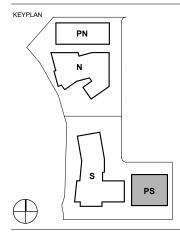
ISSUES DATE
ENTITLEMENT APPLICATION #1 09/15/2025

DATE

REVISION LIST

505 PENOBSCOT PROJECT

Dr, Redwood City, CA 94063




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SHEET TITLE:

PARKING SOUTH - LEVEL 04 PARKING PLAN

SHEET NO:

PS-104

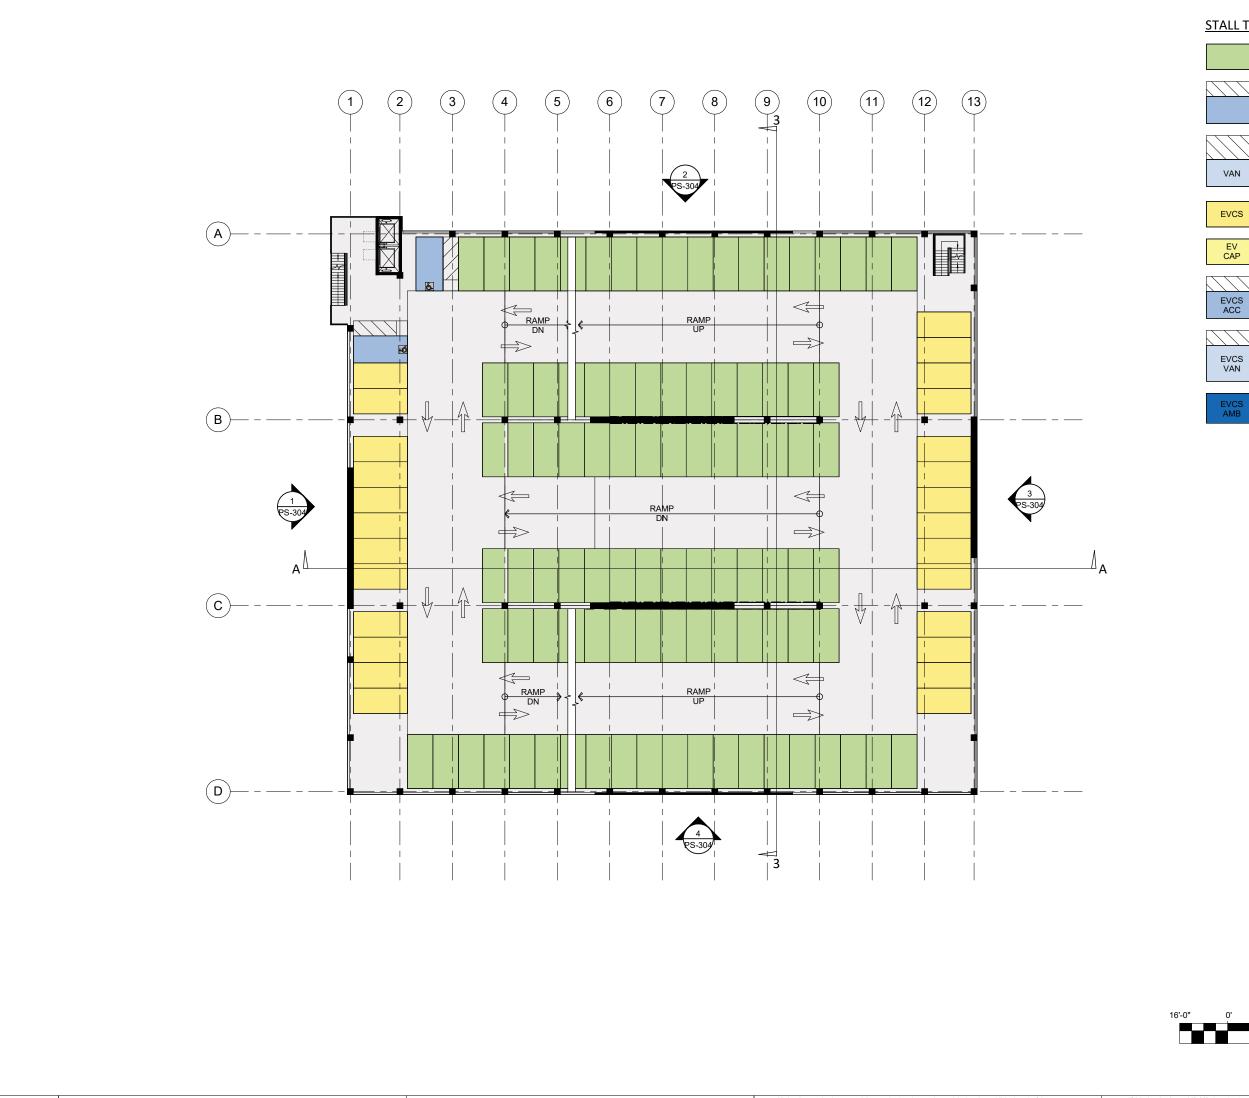

9/17/2025 4:08:21 PM

STALL TYPE LEGEND

UNISTALL





EVCS - DAY ONE

EV CAPABLE - FUTURE INSTALL





EVCS AMBULATORY

WRNSSTUDIO

501 SECOND STREET 4TH FLOOR, STE. 402 SAN FRANCISCO CALIFORNIA 94107 415.489.2224 TEL 415.358.9100 FAX WWW.WRNSSTUDIO.COM


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ISSUES DATE ENTITLEMENT APPLICATION #1 09/15/2025

REVISION LIST DATE

505 PENOBSCOT PROJECT



PROJECT NO.: 20-021 DATE: 09/25/2025 SCALE: 1/16" = 1'-0"

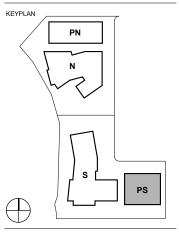SHEET TITLE:


PARKING SOUTH - LEVEL 05 PARKING PLAN

SHEET NO:

64'-0"

PS-105

SCALE: 1/16" = 1'-0"

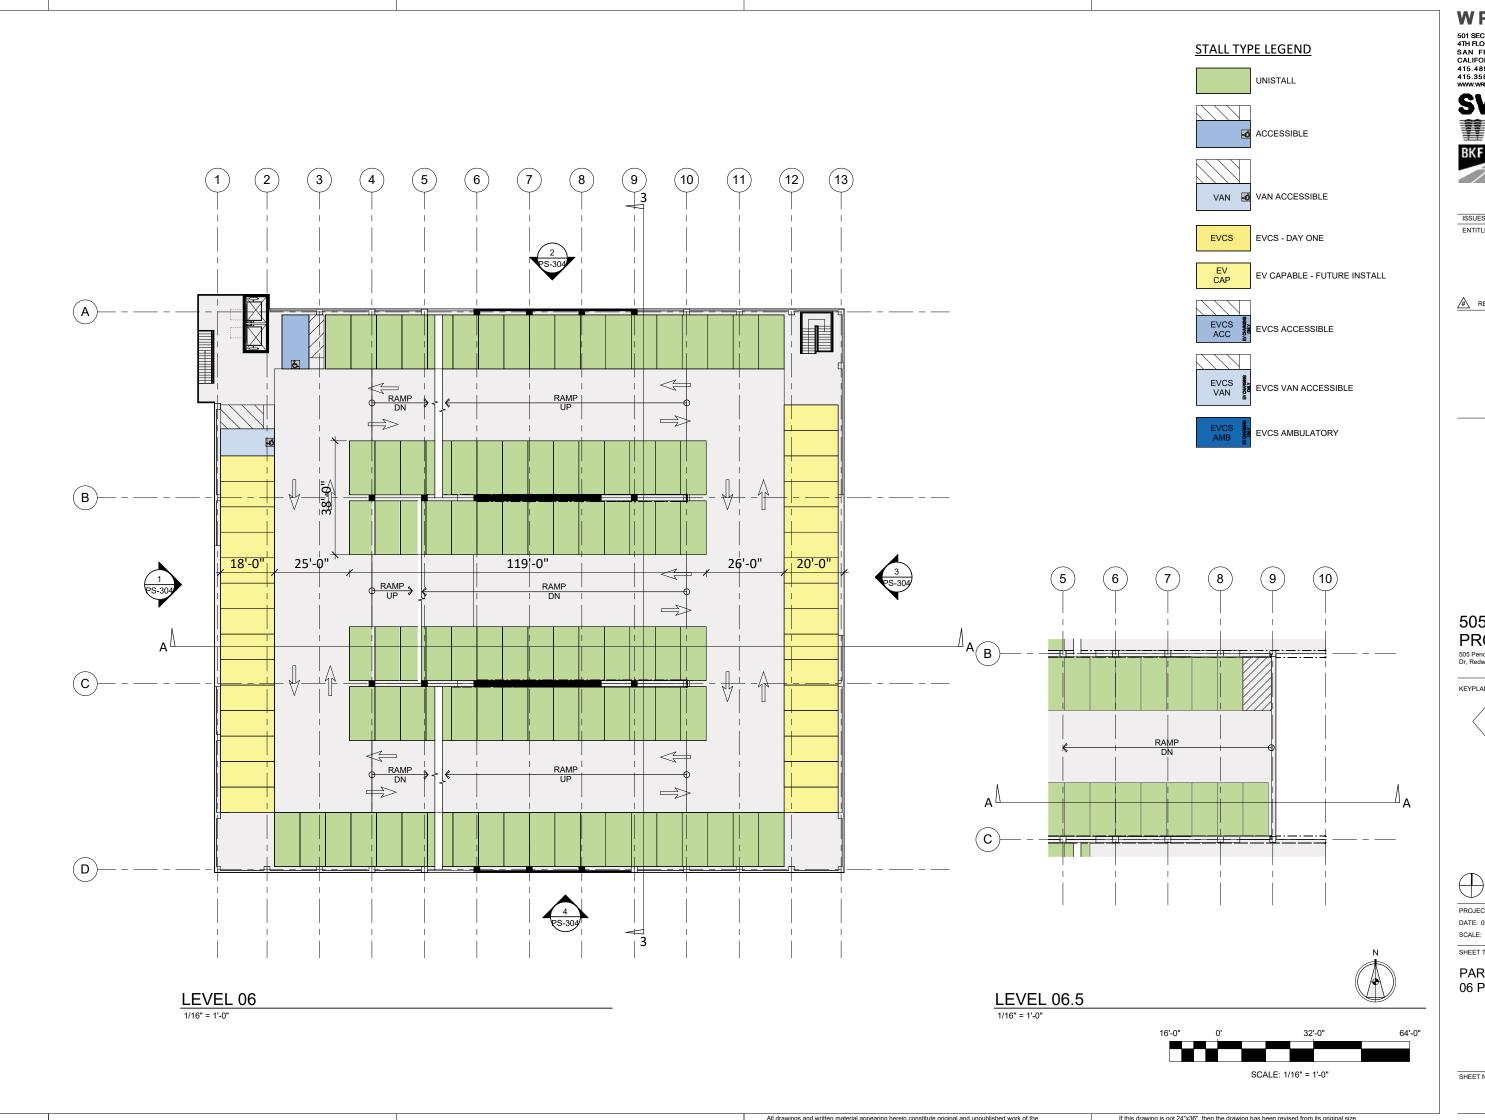

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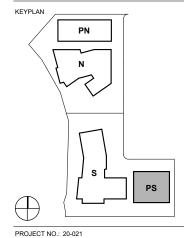
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ISSUES DATE ENTITLEMENT APPLICATION #1 09/15/2025

REVISION LIST DATE

505 PENOBSCOT PROJECT




PROJECT NO.: 20-021 DATE: 09/25/2025 SCALE: 1/16" = 1'-0"

SHEET TITLE:

PARKING SOUTH - LEVEL 06 PARKING PLAN

SHEET NO:

PS-106

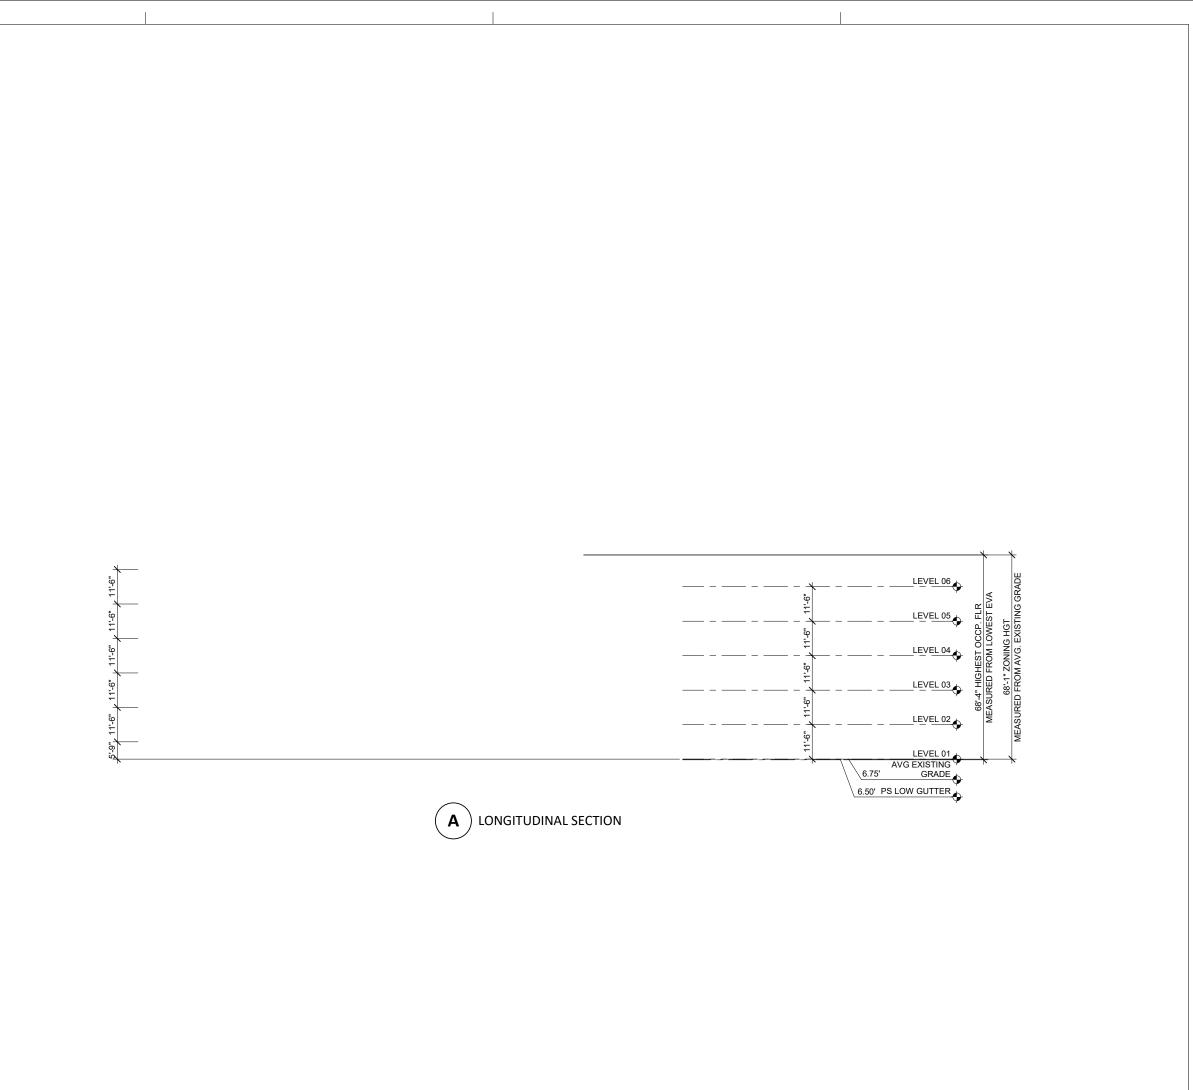

501 SECOND STREET 4TH FLOOR, STE. 402 SAN FRANCISCO CALIFORNIA 94107 415.489.2224 TEL 415.358.9100 FAX WWW.WRNSSTUDIO.COM

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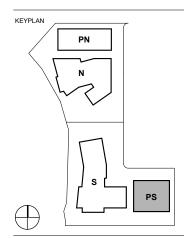
ISSUES DATE
ENTITLEMENT APPLICATION #1 09/15/2025

DATE

REVISION LIST

505 PENOBSCOT PROJECT

505 Penobscot Dr, 301 Penobscot Dr and 701 Galvest Dr. Redwood City, CA 94063



PROJECT NO.: 20-021 DATE: 09/25/2025 SCALE: 1/16" = 1'-0"


SHEET TITLE:

PARKING SOUTH -BUILDING SECTION

SHEET NO:

PS-330

10/1/2025 4:16:26 PM

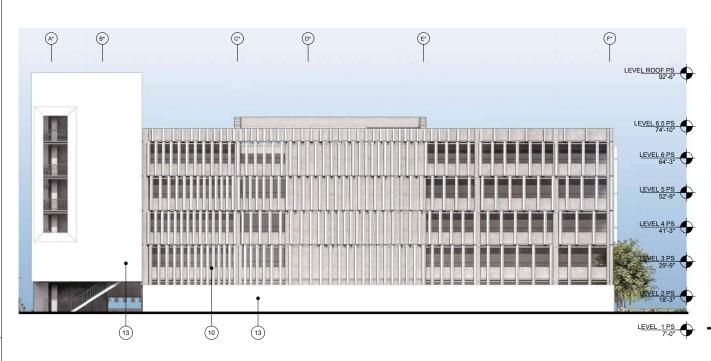

1° LEVEL ROOF PS 92'-6" LEV<u>EL 6.5 PS</u> 74'-10" LEVEL 6 PS 64'-3" LEVEL 5 PS 52'-9" LEVEL 4 PS 41'-3" LEVEL 3 PS 29'-9" LE<u>VEL 2 PS</u> 18'-3" LE<u>VEL 1 PS</u> 7'-0" 10 13

PARKING SOUTH - EXTERIOR ELEVATION - WEST

PARKING SOUTH - EXTERIOR ELEVATION - NORTH



LEVEL ROOF PS 92'-6" LEV<u>EL 6.5 PS</u> 74'-10" LEVEL 6 PS 64'-3" LE<u>VEL 5 PS</u> 52'-9" LEVEL 4 PS 41'-3" 13

PARKING SOUTH - EXTERIOR ELEVATION - EAST

PARKING SOUTH - EXTERIOR ELEVATION - SOUTH 4



10/2/2025 9:50:11 AM



12 GLASS GUARDRAIL























SHEET NO:

DATE: 09/25/2025 SCALE: As indicated SHEET TITLE:

SOUTH PARKING -EXTERIOR ELEVATION

PS-304

WRNSSTUDIO

WATRY DESIGN, INC.

09/25/2025

501 SECOND STREET 4TH FLOOR, STE. 402 SAN FRANCISCO CALIFORNIA 94107 415.489.2224 TEL 415.358.9100 FAX WWW.WRNSSTUDIO.COM

swa

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ENTITLEMENT APPLICATION

REVISION LIST

505 PENOBSCOT

PROJECT

1 ILLUSTRATIVE SITE LIGHTING PLAN

9/17/2025 2:29:15 PM

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ISSUES	DATE

REVISION LIST

505 PENOBSCOT PROJECT

Dr, Redwood City, CA 94063

KEYPLAN



PROJECT NO.: 24040.00 DATE: 09/25/2025 SCALE: NOT TO SCALE

SHEET TITLE:

ILLUSTRATIVE SITE LIGHTING PLAN

SHEET NO:

LT-101

Functional Classification	Pedestrian Activity Level Classification			20.00
	High	Medium	Low	E _{avg} /E _{min}
Major/Major	34/3.2	26/2.4	18/1.7	3.0
Major/Collector	29/2.7	22/2.0	15/1.4	3.0
Major/Local	26/2.4	20/1.9	13/1.2	3.0
Collector/Collector	24/2.2	18/1.7	12/1.1	4.0
Collector/Local	21/2.0	16/1.5	10/0.9	4.0
Local/Local	18/1.7	14/1.3 K	8/0.7	6.0

PEDESTRIAN CLASSIFICATIONS (Source: IES-RP8-2021)

HIGH = over 100 pedestrians/hour

MEDIUM = 1 to 100 pedestrians / hour

LOW = 10 or fewer pedestrians / hour

Project will use this IES target light level @ intersections based on expected pedestrian activity

TARGET ILLUMINATION FOR INTERSECTIONS

Lighting Design Criteria for Streets

(Source: City of Redwood City, 2023 Engineering Standards, Volume III Design Criteria, Section C2)

Recommended Illumination Levels By Illuminating Engineering Society (IES)

Road Classification	Area Classification	Light Level in Average (Footcandles) (See Note a)	Uniformity Ratio (Average to Minimum)
Collector	Commercial Intermediate Residential	1.2 0.9 0.6	4 to 1
Local	Commercial Intermediate Residential	0.9 0.7 0.4	6 to 1
Sidewalks	Intermediate Residential	0.6	6 to 1
Intersections		0.8	

LOCATION

Target Light Level'

PENOBSCOT DR SIDEWALK	0.7fc Average*
SAGINAW DR SIDEWALK	0.7fc Average*
GALVESTON DR SIDEWALK	0.7fc Average*

* IES recommends that sidewalk illumination (adjacent roadways) be 80% of roadway

a. Based upon asphalt road surface with diffuse or slightly specular

b. Based upon using IES Type III light distribution luminaires.



9/17/2025 2:29:15

Provide distribution cut-off, appropriate IES light Distribution luminaires and sHARGET PLANMINATION TORRO ADWAY SI& SIDE WALKS

In private, residential streets, the poles shall be designed for a minimum height of 8' and a maximum height of 16'. Design street lighting to maintain an average horizontal illumination of 0.25 foot-candles with a 10:1 ratio of average to minimum illuminance.

- All luminaires shall be 150 watt minimum High Pressure Sodium Vapor, as indicated on the plans and described in the specifications; all circuits shall be 240 Volts and wired directly to a service pedestal within the public service
- Poles shall be anodized aluminum or steel with two coats of factory-applied paint, applied per City Specifications. Shop drawings of the pole and fixture shall be submitted to the City Engineer for approval.
- Poles, mast arms and footings shall be designed to resist the or caused by a 100-mph wind load.




ROADWAY CLASSIFICATIONS: (Source: IES-RP8-2021)

MAJOR = Principal network for throughtraffic flow [but not Freeway or Expressway]; often known as "arterials or thoroughfares."


COLLECTOR = Roadways servicing traffic between major and local streets.


LOCAL = Primarily for direct access to residential, nercial, industrial, or other abutting property.

ROADWAY CLASSIFICATIONS

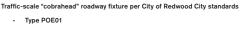


- Type POE01
- LED "cobrahead" fixture, Type III Medium lighting distribution, nominal 15,000 delivered lumens.
- · Final manufacturer and catalog number of POE01 fixture head to be coordinated with City of Redwood City.

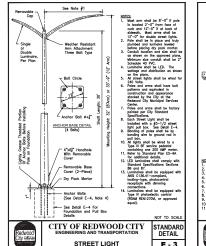

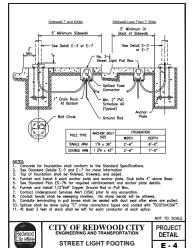

STREET LIGHTING EQUIPMENT (PENOBSCOT DRIVE, SAGINAW DRIVE & GALVESTON DRIVE)

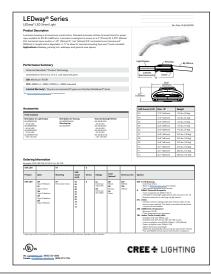

505 PENOBSCOT PROJECT

505 Penobscot Dr, 301 Penobscot Dr and 701 Galveston Dr, Redwood City, CA 94063

WRNSSTUDIO

SEE WATRY DESIGN, INC.

09/25/2025

DATE

501 SECOND STREET 4TH FLOOR, STE. 402 SAN FRANCISCO CALIFORNIA 94107 415.489.2224 TEL

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swa

WATT

REVISION LIST

ENTITLEMENT APPLICATION

ISSUES

KEYPLAN

Excerpted from Table A-3, Recommended Illuminance Criteria for People in Outdoor Environments

(Source: IES-RP43-22, Recommended Practice: Lighting Exterior Applications)

Target Light Level*	Uniformity Ratio*
1-2fc Average	8:1 (Avg / Min)
0.5fc Average	10:1 (Avg / Min)
	1-2fc Average

* assumes LZ2 (Urban Cluster) outdoor lighting zone

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TARGET ILLUMINATION FOR SITE PEDESTRIAN PATHS

PROJECT NO.: 24040.00 DATE: 09/25/2025 SCALE: NOT TO SCALE

SHEET TITLE:

SITE LIGHTING CHARACTER

SHEET NO:

LT-102