
CARRASCO & ASSOCIATES . A PROFESSIONAL CORPORA

neet title

STAMPS & APPROVALS

TITLE SHEET

North Point

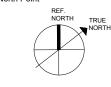

sheet no.

T1.0

NTS

PHASE II

1885 El Camino Real, Palo Alto, CA 94306

### REDWOOD SQUARE - TOWNHOMES RESIDENTIAL PROJECT

NEW SUBMITTAL PLAN CHECK RESPONSE-01 PLAN CHECK RESPONSE-02

11/30/2023 02/12/2024

PROJECT DIRECTORY

OWNER: AUZEREIS INVESTMENTS, LLC

ARCHITECT:
CARRASCO & ASSOCIATES ARCHITECTS
1885 EL CAMINO REAL
PALO ALTO, CA 94306
CONTACT: ABHA NEHRU
PMBII: abha@carrasco com

405 A CURTNER AVE. PALO ALTO, CA 94306

EMAIL: abha@carrasco.con CELL: 510.708.4879

PROJECT DATA PHASE I & II PROJECT ADDRESS: 2336 EL CAMINO REAL, REDWOOD CITY,CA 94063 APN NO: 053-309-200
ZONING DISTRICT: MIXED USE CORRIDOR-EL CAMINO REAL (MUC-ECR)

### PROJECT DATA PHASE I

EXISTING LOT AREA: 23,482 SQ.FT./ 0.539 ACRES EXISTING TYPE OF CONSTRUCTION: TYPE VA EXISTING OCCUPANCY: E

 SCOPE OF WORK:

 SUB DIVISION OF EXISTING LOT INTO TWO LOTS.

 • DAYCARE = LOT A:
 13,995 SQ.FT/±0.321 AC

 • RESIDENTIAL= LOT B:
 9,487 SQ.FT/±0.218 AC

LOTS SPLIT FOR 2336 EL CAMINO REAL-LOT "A" & LOT "B"
 LOT "A" WOULD BE THE EXISTING DAYCARE SITE.
 PARKING AT DAYCARE LOT "A" TO BE REVISED TO MEET PREVIOUSLY APPROVED REQUIREMENTS.

APPROVED REQUIREMENTS.

6. LOT "A" TO HAVE NEW ACCESS DRIVEWAY & SIDEWALK IMPROVEMENTS AT DAYCARE FRONTAGE. SEE CIVIL SHEETS FOR DETAILS,

7. AT LOT "B" NEW RESIDENTIAL DEVELOPMENT IS PROPOSED AS PART OF PHASE II.

8. LOT "B" WOULD HAVE THREE STORY TOWNHOUSE UNITS. A TOTAL OF SIX UNITS.

### PROJECT DATA PHASE II

EXISTING LOT AREA "B": 9.487 SQ.FT PROPOSED OCCUPANCY ON LOT B: R3
TYPE OF CONSTRUCTION: TYPE IIIA

SCOPE OF WORK:

1. NEW MULTIFAMILY RESIDENTIAL UNITS PROPOSED FOR THE NEW LOT "B". SIX THREE STORY TOWNHOUSES UNITS PROPOSED AS PART OF PHASE II.

SEE SHEET A0.1 & A0.3 FOR ZONING & PARKING ANALYSIS.



VICINITY MAP

### FIRE DEPARTMENT NOTES THE NUMBER AND LOCATION OF FIRE HYDRANTS BASED ON THE REQUIRED FIRE

FILE WHO THIS PROJECT SHALL BE DETERMINED UTILIZING APPENDIX B AND C OF THE CFC.

a. THE FIRE SPRINKLER SYSTEM SHALL BE DESIGNED TO NFPA STANDARD 13,

THE REQUIREMENT FOR EMERGENCY ESCAPE AND RESCUE OPENINGS IN THE RESIDENTIAL BUILDING

b. EMERGENCY ESCAPE AND RESCUE OPENINGS IN THE RESIDENTIAL BUILDING MAY BE ELIMINATED.
FIRE DEPARTMENT CONNECTIONS - FDC'S TO THE FIRE SPRINKLER / STANDPIPE SYSTEM SHALL BE LOCATED AT THE FIRE ACCESS SIDE OF THE BUILDING WITHIN 50 FEET OF A FIRE HYDRANT ON THE SAME SIDE OF THE ROAD..
PREMISES IDENTIFICATION SHALL BE MINIMUM 12" AND SHALL BE IN AN ILLUMINATED CONTRASTING BACKGROUND FACING THE STREET FROM WHICH THE BUILDING TAKES THE ADDRESS CFC 505.

### BUILDING DEPARTMENT NOTES

CIVIL ENGINEER: SRM ENGINEERING SOLUTION LLC 616 BOND CT SAN RAMON, CA 94582 TRANSPORTATION CONSULTANT:
HEXAGON TRANSPORTATION CONSULTANTS, INC. KATIE RIUTTA

PLANNER100 CENTURY CENTER COURT, SUITE 501 | SAN JOSE

DEMOLITION SHALL FOLLOW THE RWC DEMOLITION POLICY FOR COMPLETE STRUCTURES, AS APPLICABLE.

## FIRE ALARM SYSTEM AUTOMATIC SPRINKLER SYSTEM. ERRCS TO BE INSTALLED. SOLAR PANELS TO BE INSTALLED ON THE ROOF.

DEFFERRED SUBMITTAL

### P2-TM6.2 PHASE 2-STORM WATER CONTROL DETAILS-2

CALIFORNIA 95112 PHONE 408.971.6100 | FAX 408.971.6102 | DIRECT 669.207.4505

ARCHITECTURAL SHEET INDEX-PHASE I
A0.1-1 NEIGHBORHOOD CONTEXT & ZONING ANALYSIS A0.4-1 EXISTING & DEMOLITION PLAN A1 0-1 SITE PLAN

P2-TM3

P2-TM5

SHEET INDEX

CIVIL SHEET INDEX

COVER SHEET- TENTATIVE MAP

P1-TM1 PHASE 1 LOT CONFIGURATION P2-TM1 PHASE 2 LOT CONFIGURATION

ARCHITECTURAL SHEET INDEX
T1.0 TITLE SHEET: MAPS, SYMBOLS, NOTES, PROJECT DATA

P1-TM2.1 PHASE 1-EXISTING SITE & DEMOLITION PLAN P1-TM2.2 PHASE1-PROPOSED IMPROVEMENTS
P1-TM3 PHASE 1-GRADING PLAN

PHASE 2-PRELIMINARY UTILITY PLAN

PHASE 2-STORM WATER CONTROL PHASE 2-STORM WATER CONTROL DETAILS-1

P2-TM2.1 PHASE 2- EXISTING & DEMOLITION PLAN PHASE 2- PROPOSED IMPROVEMENTS

PHASE 2-GRADING PLAN

L1.0-1 LANDSCAPE PLAN

ARCHITECTURAL SHEET INDEX-PHASE II
A0.1 NEIGHBORHOOD CONTEXT & ZONING ANALYSIS
A0.2 CONCEPT SHEET- EXTERIOR MATERIAL & COLORS

AREA CALCULATIONS
EXISTING & DEMOLITION PLAN A0.5 3D VIEWS A1.0 SITE PLAN

PROPOSED FIRST FLOOR PLAN

PROPOSED SECOND FLOOR PLAN PROPOSED THIRD FLOOR PLAN

A24 ROOF PLAN ENLARGED FIRST FLOOR PLAN

ENLARGED FIRST FLOOR PLAN ENLARGED SECOND FLOOR PLAN ENLARGED SECOND FLOOR PLAN ENLARGED THIRD FLOOR PLAN

A2.9 A2.10 ENLARGED THIRD FLOOR PLAN SECTIONS

SECTIONS

WALL SECTION RENDERED ELEVATIONS

A5.2 RENDERED ELEVATIONS L1.0 LANDSCAPE PLAN

### TENTATIVE MAP REDWOOD SQUARE TOWNHOMES

2336 EL CAMINO REAL, REDWOOD CITY, CA

the 4<sup>th</sup> day of March, 2024

### GENERAL PROJECT INFORMATION

PROJECT NAME: REDWOOD SQUARE TOWNHOMES
 OWNER & SUBDIVIDER: GOLDEN MILLENNIUM ASSETS

405 A CURTNER AVE. PALO ALTO, CA 94306 TEL: 408-644-5995

• STREET LOCATION: 2336 EL CAMINO REAL REDWOOD CITY, CA 94063

EXISTING ZONING: MIXED USE COORIDOR (MUC-ECR)

EXISTING OCCUPANCY: DAYCARE

PROPOSED ZONING:
 MIXED USE COORIDOR (MUC-ECR)


• FLOOD ZONE: ZONE X (AREAS OF 0.2% ANNUAL CHANCE

FLOOD WITH AVERAGE DEPTHS OF LESS THAN 1 FOOT OR WITH DRAINAGE AREAS LESS THAN 1 SQUARE MILE; AND AREAS PROTECTED BY LEVEES FROM 1% ANNUAL CHANCE FLOOD DURING 100-YEAR FLOOD)

STORM DRAIN: REDWOOD CITY
WATER SUPPLY: REDWOOD CITY
SEWAGE DISPOSAL: REDWOOD CITY
GAS: PG&E
ELECTRICAL: PG&E

ASSESSOR'S PARCEL #S: APN 053-309-200
TOTAL SITE AREA: 0.539 ACRES

- $\bullet$  There is no existing watercourses or wells exist on this site.
- ALL DIMENSIONS DEPICTED HERE ARE APPROXIMATE AND ARE SUBJECT TO REVISIONS AT FINAL MAP STAGE.
- TOPOGRAPHY AND BOUNDARY SURVEY WAS PREPARED OR UNDER SUPERVISION OF ERIC S CANTRELL, P.L.S. 7163, AEI CONSULTANTS, DATED APRIL 18, 2019.
- BENCHMARK: ELEVATIONS SHOWN HEREON ARE BASED ON REDWOOD CITY BENCH MARK, BRASS DISK MARKED NO. 36, ELEVATION=27.15' NAVD88 DATUM.
- CIVIL ENGINEER: SRM ENGINEERING SOLUTIONS, LLC, C72794
- GEOTECHNICAL INVESTIGATION REPORT PROVIDED BY VIEN VO, C32296, SILICON VALLEY SOIL ENGINEERING, DATED JANUARY 9, 2017.

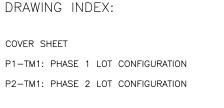

P1-TM2.1: PHASE 1 EXISTING SITE & DEMOLITION PLAN

P1-TM2.2: PHASE 1 PROPOSED IMPROVEMENTS

P1-TM3: PHASE 1 GRADING PLAN

P2-TM2.1: PHASE 2 EXISTING SITE & DEMOLITION PLAN

P2-TM2.2: PHASE 2 PROPOSED IMPROVEMENTS

P2-TM3: PHASE 2 GRADING PLAN

P2-TM4: PHASE 2 PRELIMINARY UTILITY PLAN

P2-TM5: PHASE 2 STORM WATER CONTROL

P2-TM6.1: PHASE 2 STORM WATER CONTROL DETAILS - 1

P2-TM6.2: PHASE 2 STORM WATER CONTROL DETAILS - 2



KEY MAP NTS



CLIENT



Golden Millennium Assets

405 A Curtner Ave. Palo Alto, CA 94306
408-644-5995
www.goldenmillenniumadvisory.com



COVER SHEET

2 03.04.24 PC COMMENTS

2 03.04.24 PC COMMENTS

A 02.12.24 PC COMMENTS

11.28.23 NEW SUBMITAL

A 11.10.22 PC COMMENTS

0 8.09.22 PC COMMENTS

NO DATE DESCRIPTION

DESIGNED: J. WU

CHECKED: J. JI

March 4, 2024

AS SHOWN

JOB No.: SHEET No.:

SCALE:

### PHASE 1 - LOT SPLIT

### PHASE 1 NOTES:

• EXISTING OCCUPANCY: DAYCARE

 PROPOSED OCCUPANCY: DAYCARE (LOT A)

 TOTAL SITE AREA: 0.539 ACRES

 NET NEW BUILDING AREA: 0 SQFT

PROPOSED PHASE 1: THE EXISTING LOT2 IS SPLIT INTO 2 LOTS. PHASE 1 PROPOSED LOT A, ±0.321 ACRES, IS FOR DAYCARE PARKING LOT REVISION. THE REMAINDER LOT2, ±0.218 ACRES, IS DESIGNATED AS LOT B FOR FUTURE CONDO. THE LOT LINE IS PROPOSED TO BE ADDED WITH THIS TENTATIVE MAP.

THIS LOT SPLIT WILL CONFORM TO THE STREET TREE PLAN OF REDWOOD CITY.

### LEGEND & ABBREVIATION:

— - - — EXISTING LOT LINE


PROPOSED LOT LINE

\_\_\_\_\_\_ EXISTING BUILDING TO REMAIN

EXISTING TREE TO BE REMOVED 100 B EXISTING TREE TO REMAIN

NEW TREE W/NEW TREE WELL

REMAINDER LOT

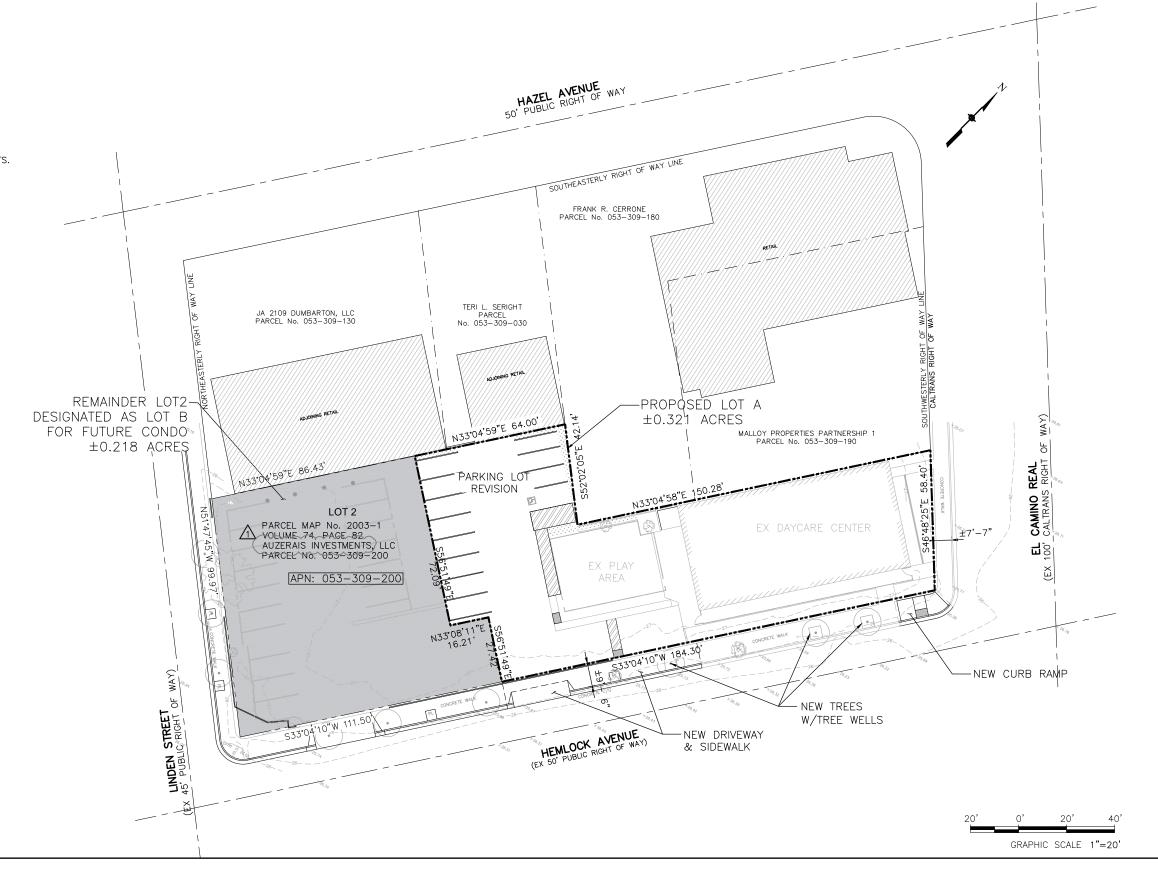



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## CONFIGURATION **PHASE**

LOT

02.12.24 PC COMMENTS 11.28.23 NEW SUBMITTAL PC COMMENTS PC COMMENTS DESCRIPTION O DATE CHECKED:


February 12, 2024 SCALE: AS SHOWN JOB No.:

SHEET No.

**P1-TM1** 

### PHASE 2

### FOR CONDOMINIUM PURPOSES 6-UNIT TOWNHOUSE

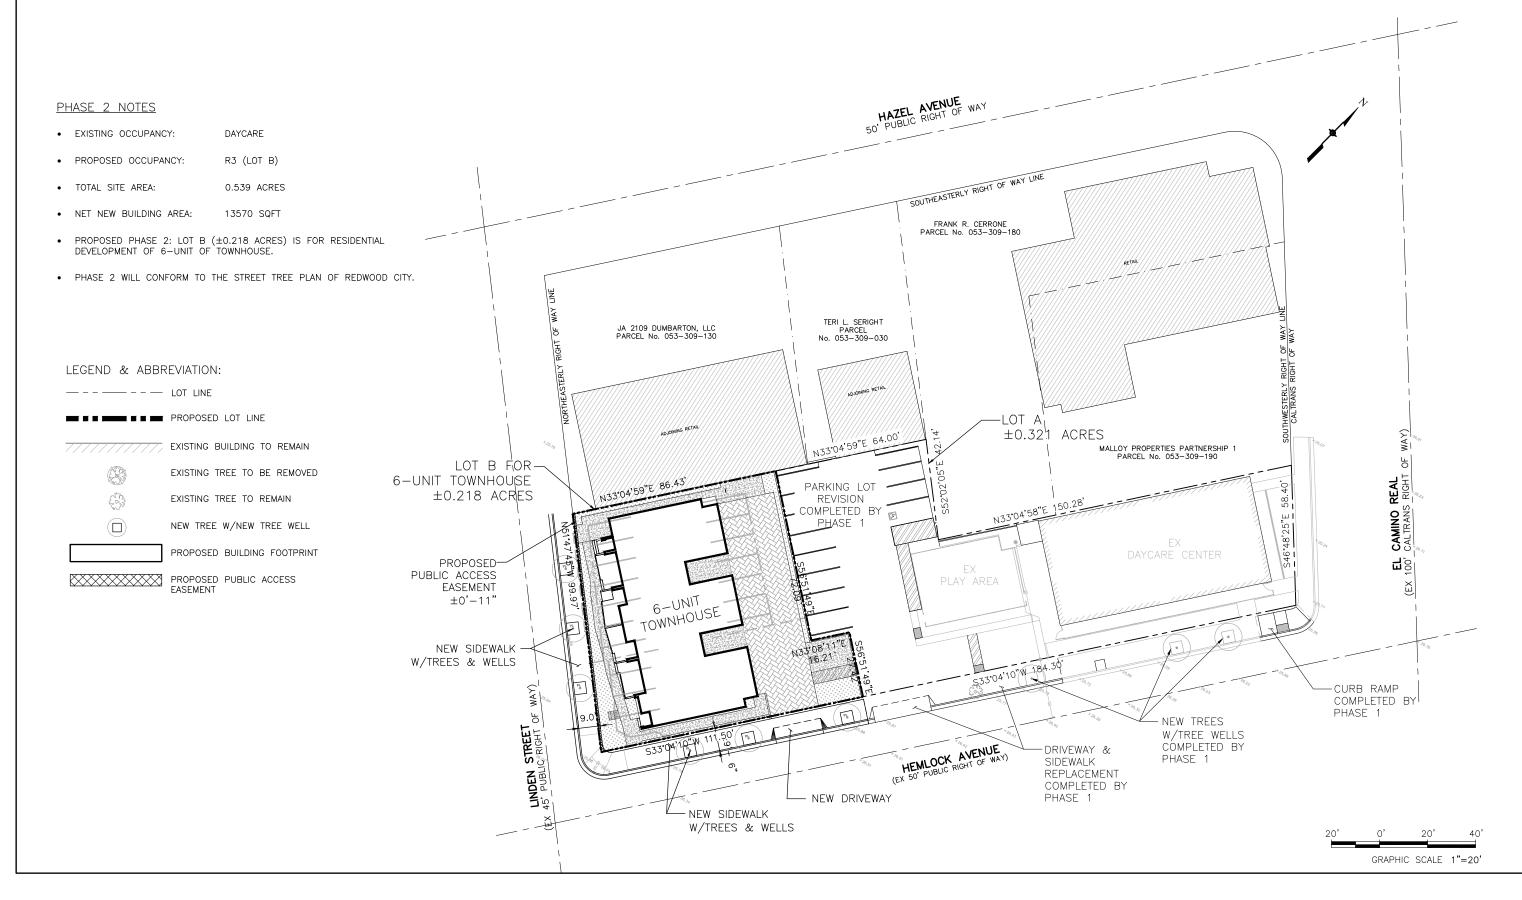



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ATION

LOT CONFIGURATION
REDWOOD SQUARE
2338 EL CAMINO REAL
DERWOOD SITY CA

PHASE

DATE: February 12, 2024

COMMENTS

A 11.28.23 NEW SUBMITIAL

A 11.10.22 PC COMMENTS

A 08.09.22 PC COMMENTS

DESCRIPTION

DESIGNED: J. WU

CHECKED: J. JI

DATE: February 12, 2024

SCALE: AS SHOWN

**P2-TM1** 

JOB No.:

SHEET No.



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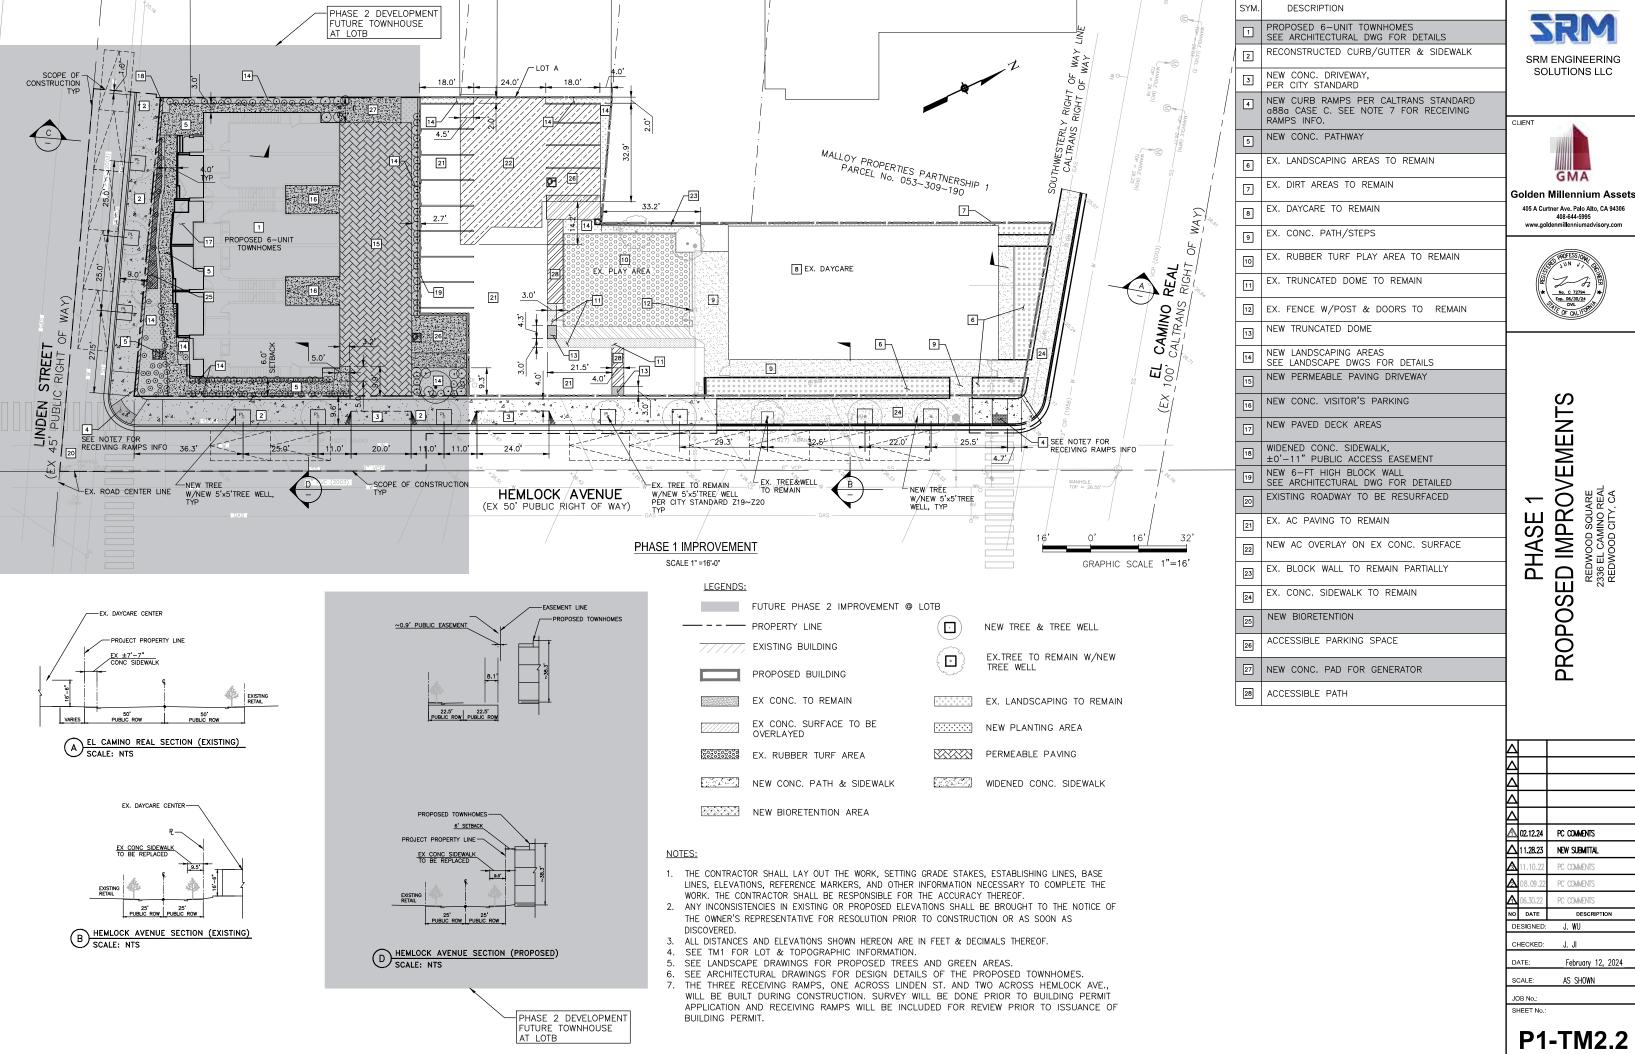
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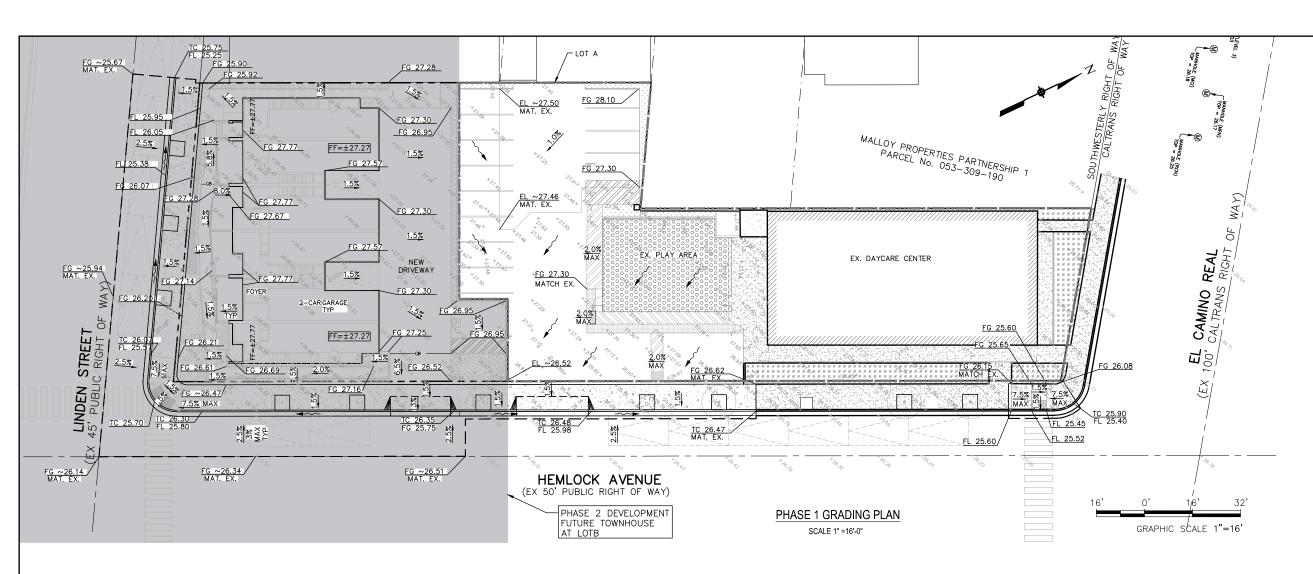
## SITE & DEMOLITION PLAN **PHASE EXISTING**

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CI	HECKED:	J. JI
DATE:		March 4, 2024
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	CALE: DB No.:	AS SHOWN

P1-TM2.1



P1-TM2.2



### **ABBREVIATIONS**

ASPHALT CONCRETE CONCRETE CONC C/G DI EB CURB & GUTTER DRAIN INLET ELECTRIC BOX ELEVATION EL EX FF GB GE INV EXISTING FINISH FLOOR FINISH GROUND GRADE BREAK GROUND ELEVATION INVERT MAT. EX MATCH EXISTING SD SDCO STORM DRAINAGE STORM CLEANOUT SDMH SS TC TYP TW STORM MANHOLE SANITARY SEWER TOP OF CURB TYPICAL TOP OF WALL WATER OVER HEAD UTILITY W OHU



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PLAN

## **PHASE** GRADING

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### SHEET No. **P1-TM3**

JOB No.:

- 1. THE CONTRACTOR SHALL LAY OUT THE WORK, SETTING GRADE STAKES, ESTABLISHING LINES, BASE LINES, ELEVATIONS, REFERENCE MARKERS, AND OTHER INFORMATION NECESSARY TO COMPLETE THE WORK. THE CONTRACTOR SHALL BE RESPONSIBLE FOR THE ACCURACY THEREOF.
- 2. THE TYPES, LOCATIONS, SIZES AND/OR DEPTHS OF EXISTING UNDERGROUND UTILITIES AS SHOWN ON THIS DRAWING WERE OBTAINED FROM SOURCES OF VARYING RELIABILITY. THE CONTRACTOR IS CAUTIONED THAT ONLY ACTUAL EXCAVATION WILL REVEAL THE TYPES, EXTENT, SIZES, LOCATIONS AND DEPTHS OF SUCH UNDERGROUND UTILITIES. (A REASONABLE EFFORT HAS BEEN MADE TO LOCATE AND DELINEATE ALL KNOWN UNDERGROUND UTILITIES). HOWEVER, THE ENGINEER CAN ASSUME NO RESPONSIBILITY FOR THE COMPLETENESS OR ACCURACY OF ITS DELINEATION OF SUCH UNDERGROUND UTILITIES WHICH MAY BE ENCOUNTERED, BUT WHICH ARE NOT SHOWN ON THESE DRAWINGS.
- 3. ANY INCONSISTENCIES IN EXISTING OR PROPOSED ELEVATIONS SHALL BE BROUGHT TO THE NOTICE OF THE OWNER'S REPRESENTATIVE FOR RESOLUTION PRIOR TO CONSTRUCTION OR AS SOON AS DISCOVERED.
- 4. ALL DISTANCES AND ELEVATIONS SHOWN HEREON ARE IN FEET & DECIMALS THEREOF.
- 5. SEE CO.1 FOR SITE EXISTING CONDITION, INCLUDING EXISTING TREE & FEATURES TO BE
- 6. SEE ARCHITECTURAL DRAWINGS FOR REMODEL DETAILS OF THE EXISTING BUILDING.
  7. ALL ELEVATIONS USED FOR THIS PROJECT ARE APPROXIMATE. CONTRACTOR NEED TO VERIFY ON

### LEGENDS:

FUTURE PHASE 2 IMPROVEMENT @ LOTB

-- PROPERTY LINE

EX. FIRE HYDRANT

EX. FIRE DEPARTMENT CONNECTION (FDC)

EX. WATER VALVE

EX. SEWER CLEAN OUT

EX. SEWER MANHOLE

### UTILITY LINE LEGENDS

EXISTING	PROPOSED
SD	STORM DRAIN LINE
SS	
W	
—— ОНИ ——	
GAS	
FS	



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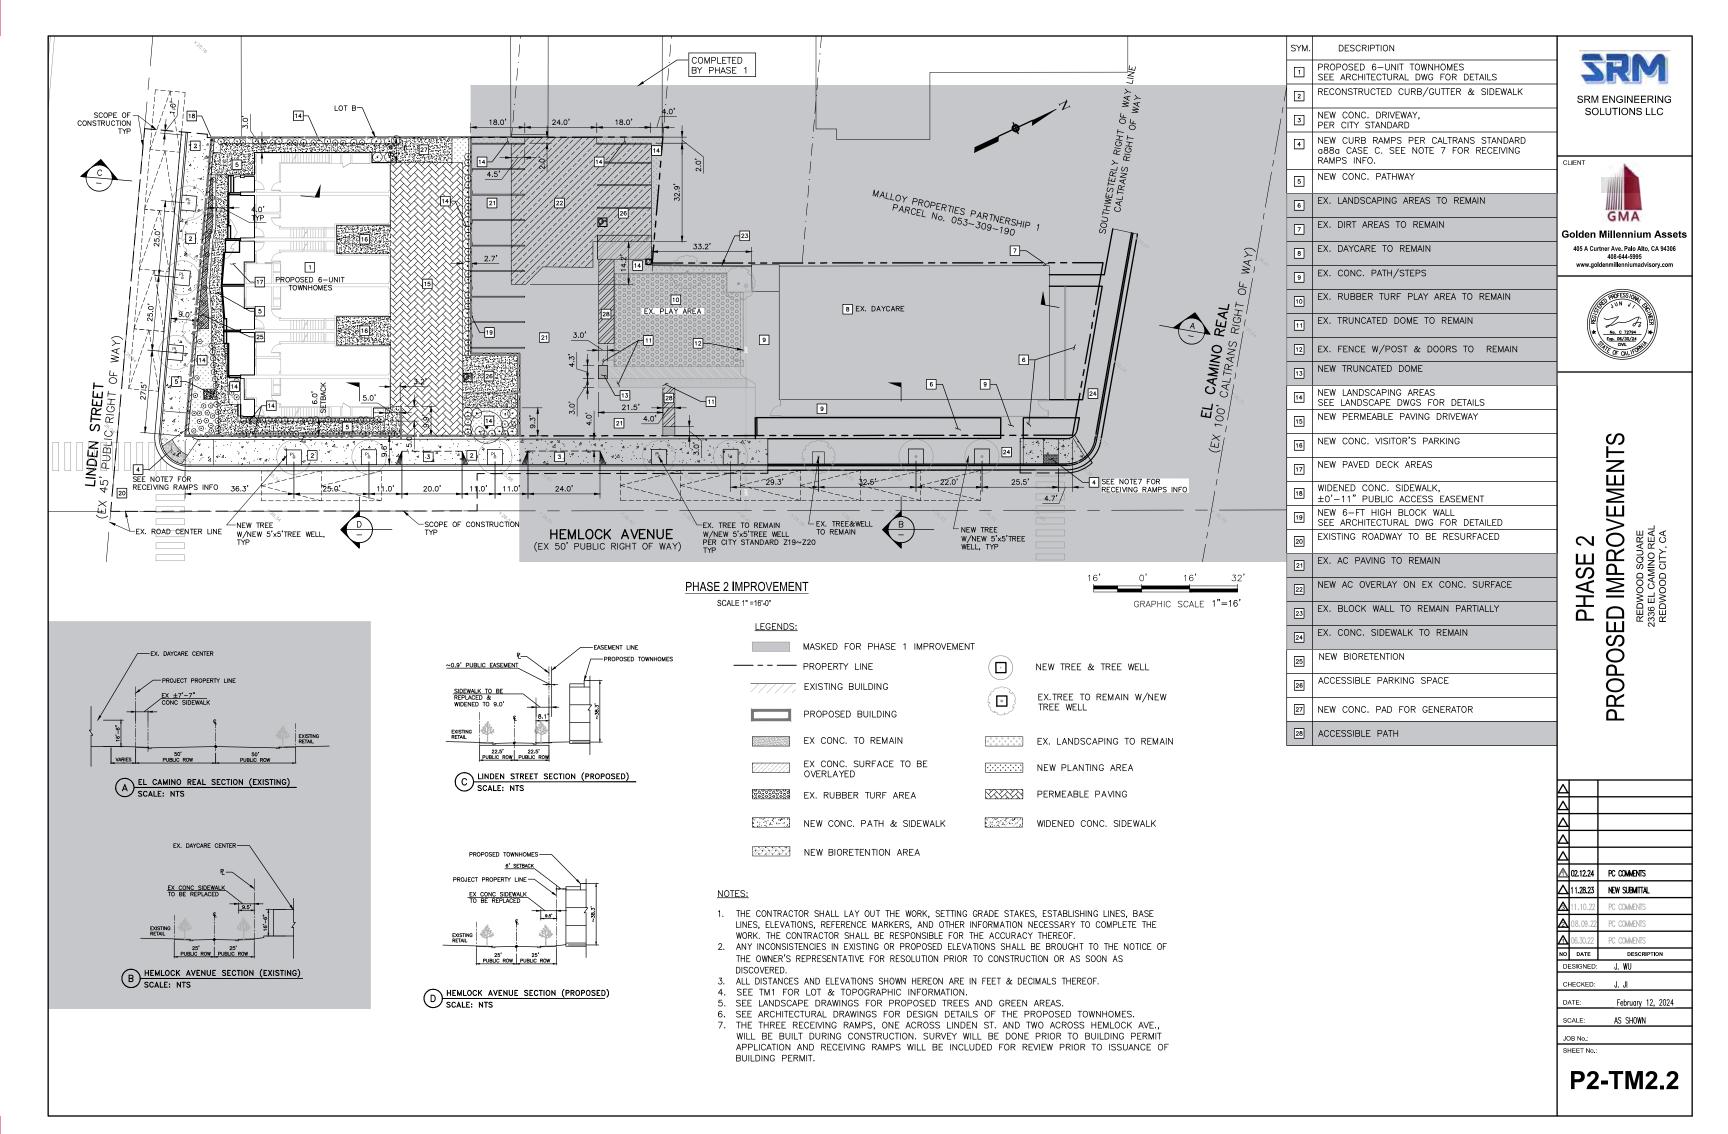



SITE & DEMOLITION PLAN
REDWOOD SQUARE
2336 EL CAMINO REAL
REDWOOD CITY, CA PHASE **EXISTING** 

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CI	HECKED:	J. Jl
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P2-TM2.1

SHEET No.:



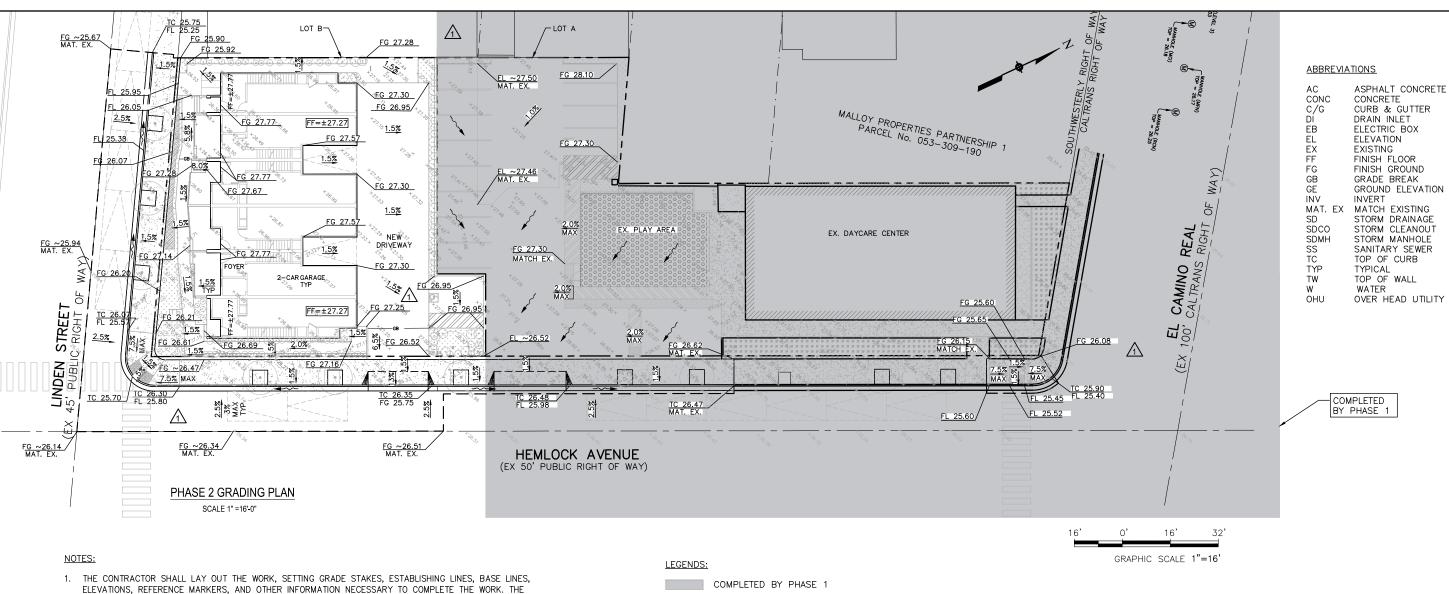

- ELEVATIONS, REFERENCE MARKERS, AND OTHER INFORMATION NECESSARY TO COMPLETE THE WORK. THE CONTRACTOR SHALL BE RESPONSIBLE FOR THE ACCURACY THEREOF.
- 2. THE TYPES, LOCATIONS, SIZES AND/OR DEPTHS OF EXISTING UNDERGROUND UTILITIES AS SHOWN ON THIS DRAWING WERE OBTAINED FROM SOURCES OF VARYING RELIABILITY. THE CONTRACTOR IS CAUTIONED THAT ONLY ACTUAL EXCAVATION WILL REVEAL THE TYPES, EXTENT, SIZES, LOCATIONS AND DEPTHS OF SUCH UNDERGROUND UTILITIES. (A REASONABLE EFFORT HAS BEEN MADE TO LOCATE AND DELINEATE ALL KNOWN UNDERGROUND UTILITIES). HOWEVER, THE ENGINEER CAN ASSUME NO RESPONSIBILITY FOR THE COMPLETENESS OR ACCURACY OF ITS DELINEATION OF SUCH UNDERGROUND UTILITIES WHICH MAY BE ENCOUNTERED, BUT WHICH ARE NOT SHOWN ON THESE DRAWINGS.
- 3. ANY INCONSISTENCIES IN EXISTING OR PROPOSED ELEVATIONS SHALL BE BROUGHT TO THE NOTICE OF THE OWNER'S REPRESENTATIVE FOR RESOLUTION PRIOR TO CONSTRUCTION OR AS SOON AS DISCOVERED.
- 4. ALL DISTANCES AND ELEVATIONS SHOWN HEREON ARE IN FEET & DECIMALS THEREOF.
- SEE CO.1 FOR SITE EXISTING CONDITION, INCLUDING EXISTING TREE & FEATURES TO BE
- 6. SEE ARCHITECTURAL DRAWINGS FOR REMODEL DETAILS OF THE EXISTING BUILDING.
  7. ALL ELEVATIONS USED FOR THIS PROJECT ARE APPROXIMATE. CONTRACTOR NEED TO VERIFY ON

--- PROPERTY LINE

EX. FIRE HYDRANT

EX. FIRE DEPARTMENT CONNECTION (FDC)

EX. WATER VALVE

EX. SEWER CLEAN OUT

EX. SEWER MANHOLE

### UTILITY LINE LEGENDS

EXISTING	PROPOSED	
SD	— <b>(130</b> — S	TORM DRAIN LINE
ss	— <b>ss</b> — S	ANITARY SEWER LINE
W	— <b>w</b> — w	ATER LINE
—— ОНИ ——	— они — О	VERHEAD ELECTRICAL LINE
—— GAS ——	— GAS — G	AS LINE
FS	—	RE SERVICE LINE
	PI	ERFORATED UNDERDRAIN



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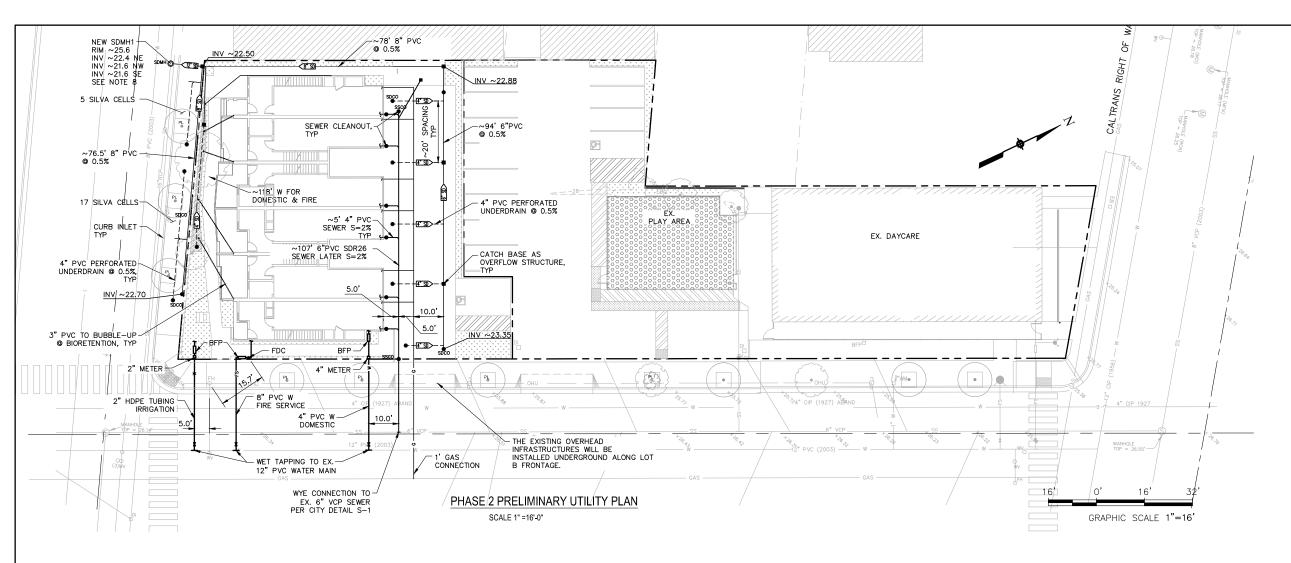


PLAN **PHASE** GRADING

02.12.24 PC COMMENTS 11.28.23 NEW SUBMITTAL PC COMMENTS PC COMMENTS DESCRIPTION NO DATE DESIGNED: J. Jl CHECKED: DATE: February 12, 2024 SCALE: AS SHOWN

**P2-TM3** 

JOB No.: SHEET No.



### ABBREVIATIONS

ASPHALT CONCRETE CONCRETE CURVE NUMBER DRAIN INLET EΒ ELECTRIC BOX ELEVATION EL EX FF GB GE INV FINISH FLOOR FINISH GROUND GRADE BREAK GROUND ELEVATION INVERT L# LINE NUMBER
MAT. EX MATCH EXISTING SD SDC0 STORM DRAINAGE STORM CLEANOUT SS TC TYP TW WV SANITARY SEWER TOP OF CURB TYPICAL TOP OF WALL OVER HEAD UTILITY



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# PHASE 2 RELIMINARY UTILITY PLAN

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_	08.09.22	PC COMMENTS
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)	HECKED:	J. JI
),	ATE:	February 12, 2024
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**P2-TM4** 

JOB No.: SHEET No.

### NOTES

- THE CONTRACTOR SHALL LAY OUT THE WORK, SETTING GRADE STAKES, ESTABLISHING LINES, BASE LINES, ELEVATIONS, REFERENCE MARKERS, AND OTHER INFORMATION NECESSARY TO COMPLETE THE WORK. THE CONTRACTOR SHALL BE RESPONSIBLE FOR THE ACCURACY THEREOF.
- 2. THE TYPES, LOCATIONS, SIZES AND/OR DEPTHS OF EXISTING UNDERGROUND UTILITIES AS SHOWN ON THIS DRAWING WERE OBTAINED FROM SOURCES OF VARYING RELIABILITY. THE CONTRACTOR IS CAUTIONED THAT ONLY ACTUAL EXCAVATION WILL REVEAL THE TYPES, EXTENT, SIZES, LOCATIONS AND DEPTHS OF SUCH UNDERGROUND UTILITIES. (A REASONABLE EFFORT HAS BEEN MADE TO LOCATE AND DELINEATE ALL KNOWN UNDERGROUND UTILITIES). HOWEVER, THE ENGINEER CAN ASSUME NO RESPONSIBILITY FOR THE COMPLETENESS OR ACCURACY OF ITS DELINEATION OF SUCH UNDERGROUND UTILITIES WHICH MAY BE ENCOUNTERED, BUT WHICH ARE NOT SHOWN ON THESE DRAWINGS.
- 3. ANY INCONSISTENCIES IN EXISTING OR PROPOSED ELEVATIONS SHALL BE BROUGHT TO THE NOTICE OF THE OWNER'S REPRESENTATIVE FOR RESOLUTION PRIOR TO CONSTRUCTION OR AS SOON AS DISCOVERED.
- 4. ALL DISTANCES AND ELEVATIONS SHOWN HEREON ARE IN FEET & DECIMALS THEREOF.
- 4. SEE TM1 FOR LOT & TOPOGRAPHIC INFORMATION.
- 5. SEE LANDSCAPE DRAWINGS FOR PROPOSED TREES AND GREEN AREAS.
- 6. SEE ARCHITECTURAL DRAWINGS FOR DESIGN DETAILS OF THE PROPOSED CONDOMINIUM.
- 7. SEE TABLE—1 ON TM5 FOR DETAILS OF HOW RUNOFF IS DIVERTED AND DRAINED.
- 7. SEE TABLE I ON THIS FOR DETAILS OF HOW RUNOFF IS DIVERTED AND DRAINED.

  8. EXISTING PIPE LOCATION AND INVERT AT NEW SDHM NEED TO BE VERIFIED SITE BY CONTRACTORS BEFORE CONSTRUCTION.

## LEGENDS: PROPERTY LINE EX. FIRE HYDRANT EX. FIRE DEPARTMENT CONNECTION (FDC) EX. WATER VALVE SDCO NEW STORM MANHOLE EX. SEWER CLEAN OUT SSCO NEW SEWER CLEAN OUT NEW SILVA CELL NEW CURB INLET NEW CATCH BASIN AS

OVERFLOW STRUCTURE

UTILITY LINE LEGENDS

PROPOSED


-STORM DRAIN LINE

--- W ----- WATER LINE

─-G ---- GAS LINE

---- PERFORATED UNDERDRAIN

**EXISTING** 

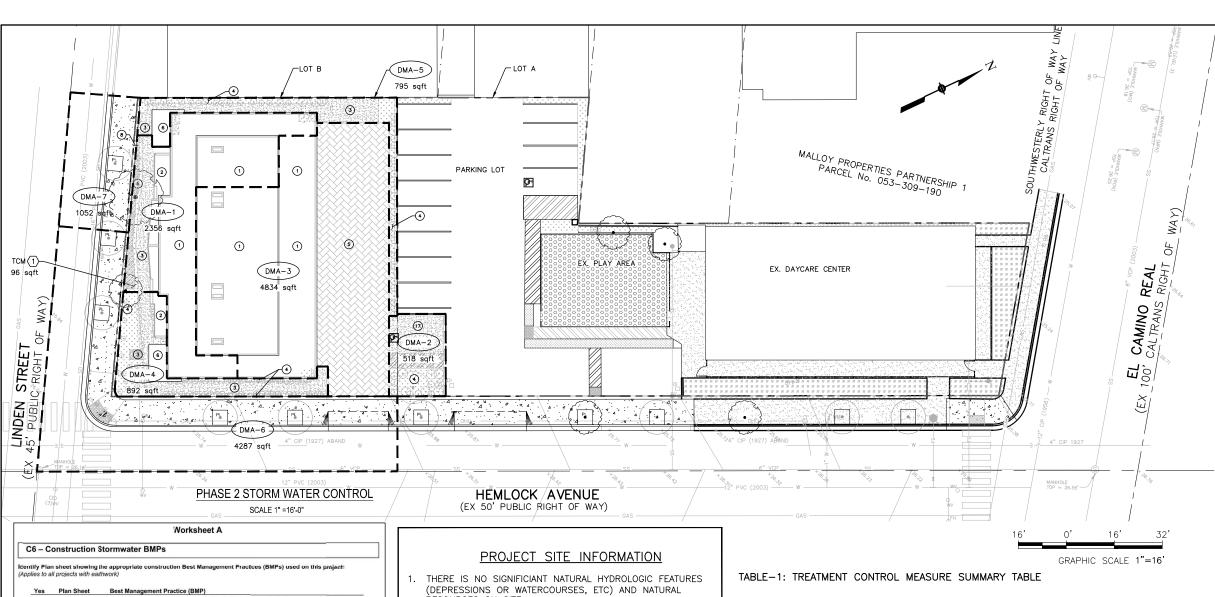

- (DEPRESSIONS OR WATERCOURSES, ETC) AND NATURAL

Control and prevent the discharge of all potential pollutants, including pavement cutting wastes, paints, concrete, petroleum products, chemicals, wash water or sediments, rinse water from architectural copper, and non-stormwater discharges to storm drains and

Do not clean, fuel, or maintain vehicles on-site, except in a designated area where wash

Train and provide instruction to all employees/subcontractors re: construction BMPs.

Limit construction access routes and stabilize designated access points.

Protect all storm drain inlets in vicinity of site using sediment controls such as berme, fiber rolls, or filters.

Attach the San Mateo Countywide Water Pollution Prevention Program's construction BMP plan sheet to project plans and require contractor to implement the applicable BMPs on the

Delineate with field markers clearing limits, easemens, setbacks, sensitive or critical areas outfer zones, trees, and drainage courses.

inspection frequency;

Methods and scheduls for grading, excavation, filling, clearing of vegetation, and storage and disposal of excavated or cleared material;

Specifications for vegetative cover & mulch, include methods and schedules for planting and fertilization;

Provisions for temporary and/or permanent irrigation.

Divert on-site runoff around exposed areas; divert off-site runoff around the site (e.g., swales

Protect adjacent properties and undisturbed areas from construction impacts using vegetatibuffer strips, sediment barriers or filters, dikes, mulching, or other measures as appropriate.

Use temporary erosion controls to stabilize all denuded areas until permanent erosion controls are established.

Provide notes, specifications, or attachments describing the following:

Construction, operation and maintenance of erosion and sediment controls, include inspection frequency;

Use sediment controls or filtration to remove sediment when dewatering and obtain all

silt fences, check dams, soil blankets or mats, covers for soil stock piles, etc.

Perform clearing and earth moving activities only during dry weather.

1. PLEASE SEE THE BEST MANAGEMENT PRACTICES PLAN SHEET IN

EMAIL: zhenzli@gmail.com ADDRESS: 405 A CURTNER AVE, PALO ALTO CA, 94306

2. RESPONSIBLE PARTY FOR OPERATION & MAINTENANCE:

GOLDEN MILLENNIUM ASSETS CONTACT: MS ZHEN ZHEN LI PHONE: 1-408-644-5995

water is contained and treated.

plan sheet.

necessary permits.

and dikes).

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NOTE:

- SEE TM1 FOR SITE EXISTING CONDITION, INCLUDING IMPERVIOUS/PERVIOUS, TREE LOCATION & SIZE AND EXISTING BUILDING TO REMAIN.
- THERE IS NO SENSITIVE NATURAL AREAS TO BE PRESERVED
- AND PROTECTED FROM DEVELOPMENT.
  THERE IS NO OTHER POLLUTANT SOURCES.

### RESOURCES ON SITE. SOILS TYPE IS SILTY CLAY. GROUND WATER DEPTH IS 12 FEET BELOW SURFACE.

- NAME OF THE RECEIVING BODY: REDWOOD CREEK.
  DRAINAGE FROM NEW DEVELOPMENT WILL BE TIED AND DISCHARGE TO EXISTING 16"RCP ALONE LINDEN ST.
- SEE 1/- FOR PROPOSED IMPERVIOUS/PERVIOUS DETAILS.

### LOW IMPACT - SITE DESIGN MEASURES

MINIMIZE IMPERVIOUS SURFACES BY ADOPTING PERVIOUS PAVING AND LANDSCAPE AREAS.

DMA.	TCM #	Treatment Type	Drainage Area (s.1.)	Impervious Area (s.l.)	Pervious Area (s.f.)	Bioretention/ treatment Area Requed (s.f.)	Bioretention/ treatment/Silva Cell Provided (s.f./ea)	Methods that runoff from each DMA is drained to TCM.
1	1.0	Dioretention	2,356	2,203	153	- 89	96	Gee note 182
2	n/a	Self-retaining (landscape)	518	345	173	173	173	See note 3
3	0/a	Self-retaining (permeable paving)	4.834	2.684	2.150	1.342	2.150	See note 4
4	rva .	Self-retaining (landscape)	892	515	377	258	377	See note 5
5	n/a	Self retaining (fandscape)	705	521	274	261	274	See note 5
6	70'0	Silva Cell	4,287	-4,208	81	169	17	See note 6
7	190	Silva Cell	1052	1.032	20	- 41	- 5	See note 6

Simplified flow-based 4% Method is used for sizing Bioretention Area. [(Impervious Area+pervious Arex 0.1) x 0.04].
For DMA-1 roof drain, through downspoots and sloped drain pipes, the roof drain is connected to bubble-up drains at the bioretention. For DMA-1 lower roof drain, it If be collected and drain to the ground. For DMA-1 deck drain, it will be collected a

- For DMA 2, drain from accesible parking sheetflow to the lanscape area
- For DMA-9 froit from concrete parties because the management of the analysis and discharge to permeable paving area.

  For DMA-486, drain from concrete paths, pads etc. sheetflow to the lanscape area.

  For DMA-687, drain from sidewalks and roadways sheetflow to gutters, and diverte to the curb inlets, from where it is distributed to and treated at the Silva cells.

1. STORM WATER CONTROL IS DESIGNED IN COMPLIANCE WITH PROVISION C.3 OF MRP (BAY AREA MUNICIPAL REGIONAL STORM PERMIT).

1 PROPOSED CONC. PARKING - IMPERVIOUS

STORM WATER CONTROL NOTES:

- THE PROJECT IS C.3 REGULATED PROJECT. SEE "C.3 AND C.6 DEVELOPMENT REVIEW
- CHECKLIST" FOR DETAILS.
  THE TOTAL EXISTING IMPERVIOUS SURFACES TO BE REPLACED IS LESS THAN 50% OF PRE-PROJECT IMPERVIOUS SURFACES, SITE DESIGN, SOURCE CONTROL AND STORM WATER TREATMENT ARE REQUIRED FOR IMPERVIOUS SURFACES REPLACED AND/OR CREATED.
- SEE TABLE—1 FOR WATER TREATMENT CONTROL MEASURE SUMMARY.
- SEE TABLE-2 FOR STORMWATER SOURCE CONTROL MEASURES.
- SEE WORKSHEET A ON THIS SHEET FOR CONSTRUCTION STORM WATER BMPS.

### **LEGENDS:**

SYM

(5)

6

7

(8)

DESCRIPTION

DETAIL 5/6.1

IMPERVIOUS

IMPERBIOUS

① | PROPOSED ROOF - IMPERVIOUS

2 PROPOSED DECK - IMPERVIOUS

3 PROPOSED CONC. WALKWAY/STEPS - IMPERVIOUS

PROPOSED PERMEABLE PAVING - PERVIOUS, SEE

PROPOSED LANDSCAPING AREA - PERVIOUS

PROPOSED LOWER ROOF - IMPERVIOUS

PROPOSED AC OVERLAY OVER EX. PCC -

PROPOSED WIDENED CONC. SIDEWALK -

EXISTING BUILDING

DRAINAGE MANAGEMENT AREA (DMA) BOUNDARY

EX. PATH TO REMAIN EX CURB/GUTTER SIDEWALK

EX. LANDSCAPING AREA

EX. RUBBER TURF AREA

NEW CEMENT CONCRETE

NEW PLANTING AREA

PERMEABLE PAVING

NEW BIORETENTION AREA EX. TREE TO REMAIN W/NEW 

TREE WELL

( 🖸 ) NEW TREE & TREE WELL

102.12.24 PC COMMENTS **1**11.28.2 NEW SUBMITTAL C COMMENTS PC COMMENTS O DATE DESCRIPTION .I WII CHECKED: February 12, 2024 SCALE: AS SHOWN

SRM ENGINEERING SOLUTIONS LLC

Golden Millennium Assets

405 A Curtner Ave. Palo Alto, CA 94306

408-644-5995

ONTRO

Ö

WATER

STORM

**PHASE** 

CLIENT


**P2-TM5** 

IOB No. SHEET No.




### TABLE-2: STORMWATER SOURCE CONTROL MEASURE


POTENTIAL SOURCE OF POLLUTANTS	STRUCTURAL SOURCE CONTROLS	OPERATIONAL SOURCE CONTROLS
ON-SITE STORM DRAIN	ON-SITE STORM DRAINS SHALL BE MARKED WITH THE WORDS "NO DUMPING! FLOWS TO BAY" (OR APPLICABLE WATER BODY) APPLIED WITH THERMOPLASTIC OR A MEDALLION.	ALL ON-SITE STORM DRAIN INLETS SHALL BE CLEANED AT LEAST ONCE A YEAR IMMEDIATELY PRIOR TO THE RAINY SEASON.
LANDSCAPING	RETAIN EXISTING VEGETATION AS PRACTICABLE.     SELECT DIVERSE SPECIES APPROPRIATE TO THE SITE. INCLUDE PLANTS THAT ARE PEST— AND/OR DISEASE—RESISTANT, DROUGHT—TOLERANT, AND/OR ATTRACT BENEFICIAL INSECTS.     USE EFFICIENT IRRIGATION SYSTEM; DESIGN TO MINIMIZE RUNOFF.	MINIMIZE USE OF PESTICIDES AND QUICK-RELEASE FERTILIZERS. EMPLOY NON-CHEMICAL CONTROLS (BIOLOGICAL, PHYSICAL AND CULTURAL CONTROLS) TO TREAT A PEST PROBLEM. DO NOT OVER WATER.

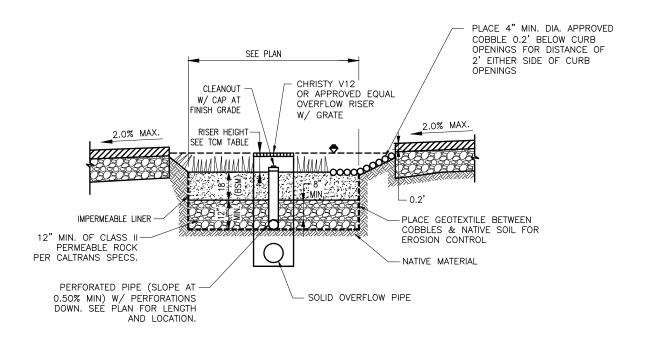

**BIORETENTION** SIZING METHODS: FLOW 4%

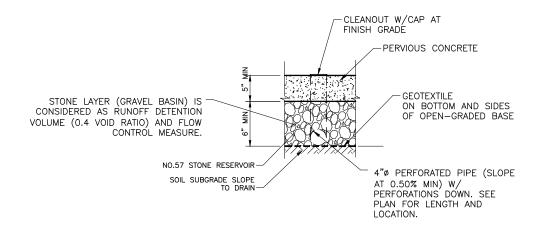



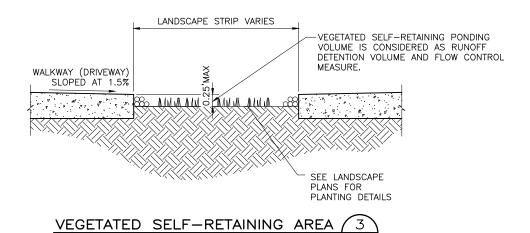




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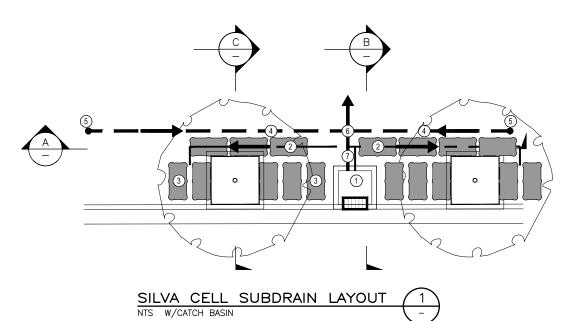


## STORM WATER CONTROL DETAILS-1 PHASE


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A	02.12.24	PC COMMENTS
Δ	11.28.23	NEW SUBMITTAL
◬	11.10.22	PC COMMENTS
Δ	08.09.22	PC COMMENTS
$\nabla$	06.30.22	PC COMMENTS
NO	DATE	DESCRIPTION
DE	SIGNED:	J. WU
CHECKED:		J. Jl
D	ATE:	February 12, 2024
so	CALE:	AS SHOWN

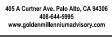JOB No.: SHEET No.

P2-TM6.1




- STORMWATER ENTERS THE SILVA CELL SYSTEM THROUGH A CATCH BASIN
- (2) WATER IS DISTRIBUTED THROUGH THE SILVA CELL SYSTEM THROUGH PERFORATED PIPES
- (3) WATER THEN MOVES THROUGH THE PLANTING SOIL HOUSED WITHIN THE SILVA CELL SYSTEM
- 4 EXCESS WATER IS COLLECTED IN A PERFORATED COLLECTION DRAIN PIPE
- 5 CLEANOUT
- 6 WATER COLLECTED IN THE COLLECTION PIPE IS DIRECTED TO STORM SYSTEM
- 7 6" PVC OVERFLOW PIPE

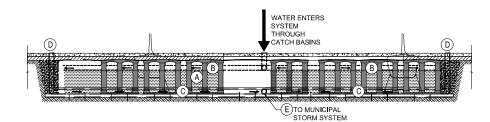

- A SILVA CELL SYSTEM ( DECK, BASE, AND POSTS)
- B DISTRIBUTION PIPE
- © COLLECTION PIPE


- D CLEANOUT
- (E) CONVEY TO OFFSITE STORM SYSTEM
- → DIRECTION OF WATERFLOW



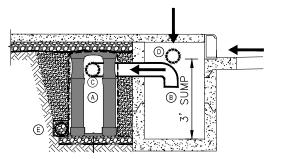

- A SILVA CELL SYSTEM ( DECK, BASE, AND POSTS)
- B CURB INLET
- © DISTRIBUTING PIPE
- O OVERFLOW
- © COLLECTING PIPE
- → DIRECTION OF WATERFLOW



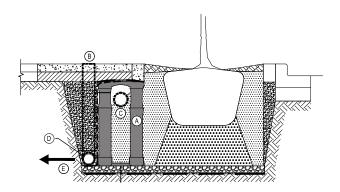

- A SILVA CELL SYSTEM ( DECK, BASE, AND POSTS)
- B CLEANOUT
- © DISTRIBUTING PIPE
- COLLECTING PIPE
- © CONVEY TO STORM MAIN
- → DIRECTION OF WATERFLOW





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PHASE 2
STORM WATER CONTROL DETAILS-2

A D. 11.28.23 PC COMMENTS
A 11.28.23 NEW SUBMITFAL
A 11.10.22 PC COMMENTS
A 08.09.22 PC COMMENTS
NO DATE DESCRIPTION
DESIGNED: J. WU
CHECKED: J. JI
DATE: February 12, 2024
SCALE: AS SHOWN

P2-TM6.2


JOB No : SHEET No









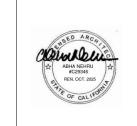

CAMINO F

LOT SPLIT FOR 2336 EL (

NEW SUBMITTAL

**PHASE I** 

11.30.2023

CARRASCO & ASSOCIATES

VIEW 1 - EL CAMINO REAL

VIEW 2 - 26 HEMLOCK AVE

VIEW 3 - 26 HEMLOCK AVE

VIEW 4 - 65 HEMLOCK AVE VIEW 5 - 47 HEMLOCK AVE









KEY PLAN

VIEW 6- 202 LINDEN STREET

VIEW 7- CORNER OF HEMLOCK AVE & LINDEN STREET

VIEW 8 - 102 LINDEN STREET

VIEW 9 - 134 HEMLOCK AVE

PROPOSED SITE, VICINITY MAP & ADJACENT ZONING

NEIGHBORHOOD CONTEXT & ZONING ANALYSIS

sheet no.

heet title

A0.1-1

1885 El Camino Real, Palo Alto, CA 94306

PROJECT DATA PROJECT ADDRESS: APN NO: EXISTING LOT AREA:

2336 EL CAMINO REAL, REDWOOD CITY,CA 94063 053-309-200 23,482 SQ.FT./ 0.539 ACRES

ZONING ANALYSIS

MIXED USE CORRIDOR (MUC-ECR)

PHASE I LOT "A" EXISTING OCCUPANCY TO REMAIN

PRE-SCHOOL PARKING
5 TEACHERS\*
1 DIRECTOR
60 KIDS
ACCESSIBLE+EVSE PARKING\*\*


\*ONLY TWO CLASSROOMS WITH 5 TEACHERS
\*\*ACCESSIBLE AISLE WITH PROVISION FOR EVSE ALLOWS FOR THE SPACE TO BE COUNTED TWICE PER AB1100-22511.2 STATE LAW


BIKE PARKING PROVIDED AT PRE-SCHOOL: 6 (NO CHANGE)


PARKING & OPEN SPACE ANALYSIS

STREET PARKING SPACES: AVAILABLE
ALONG HEMLOCK: 7 SPACES

TIMED CURBSIDE PARKING ALONG HEMLOCK TO BE ASSIGNED FOR DAYCARE DROP OFF PER CITY TRANSPORTATION DEPARTMENT.

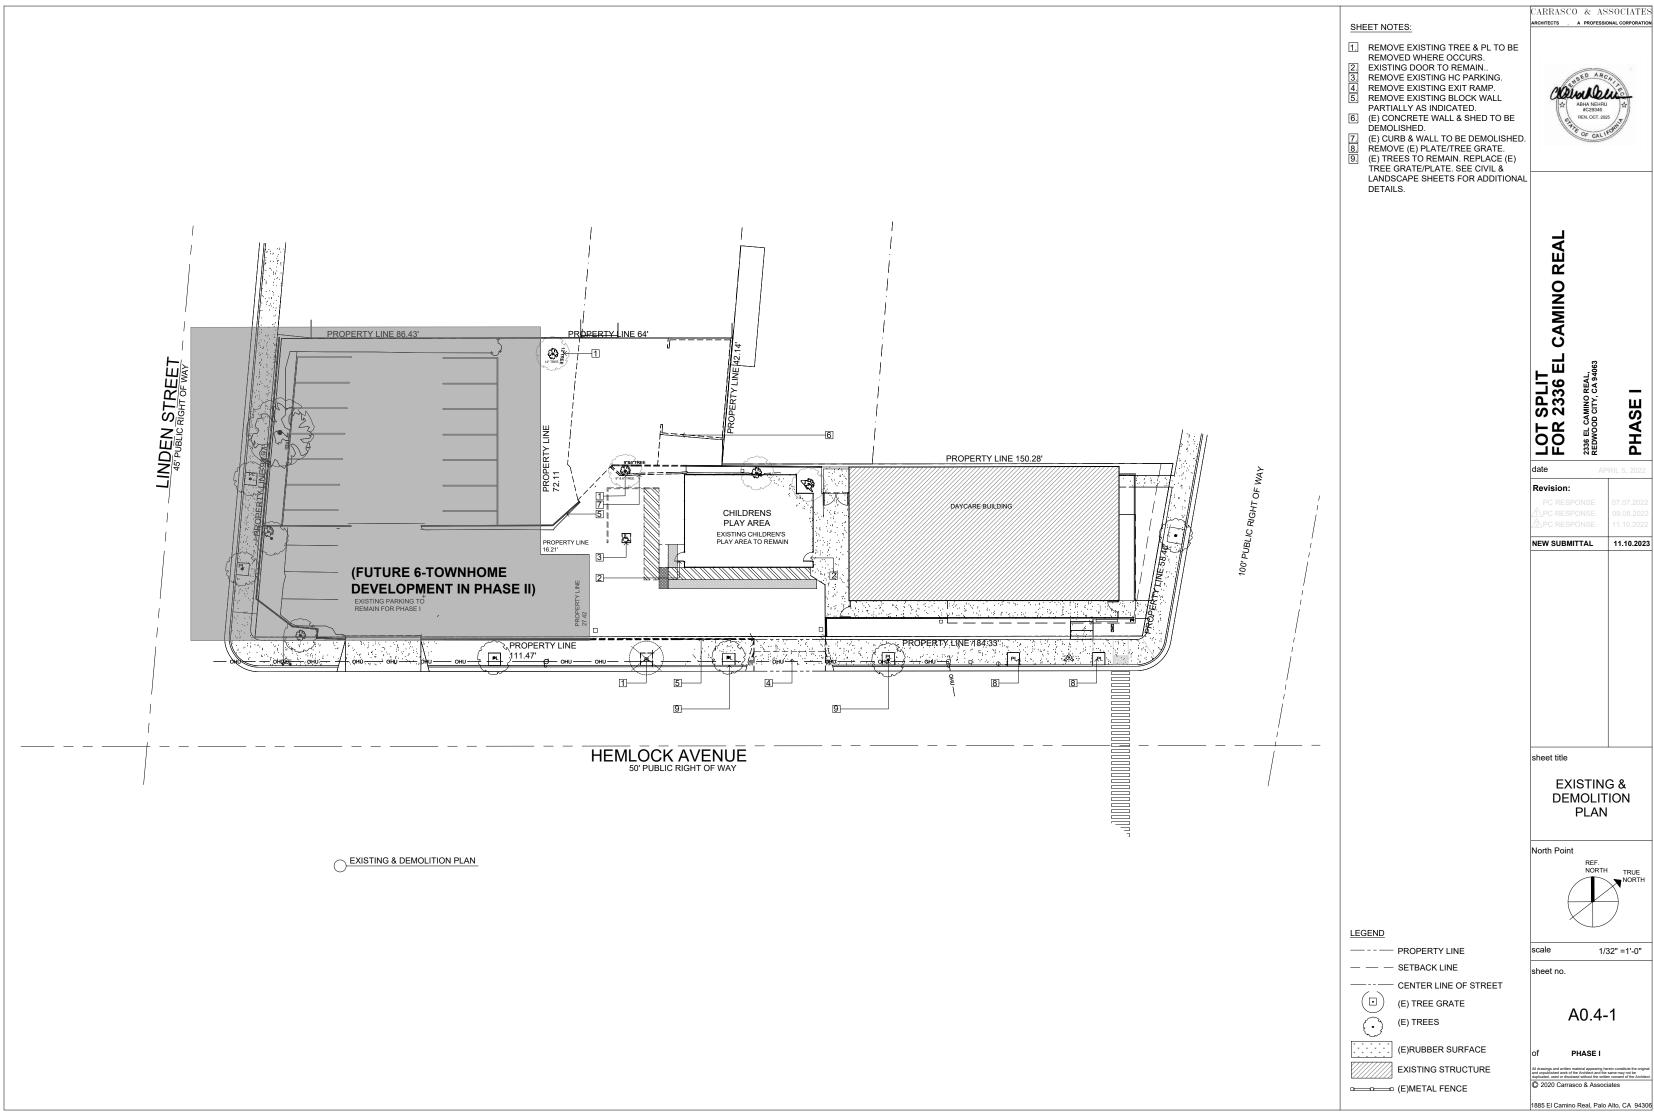

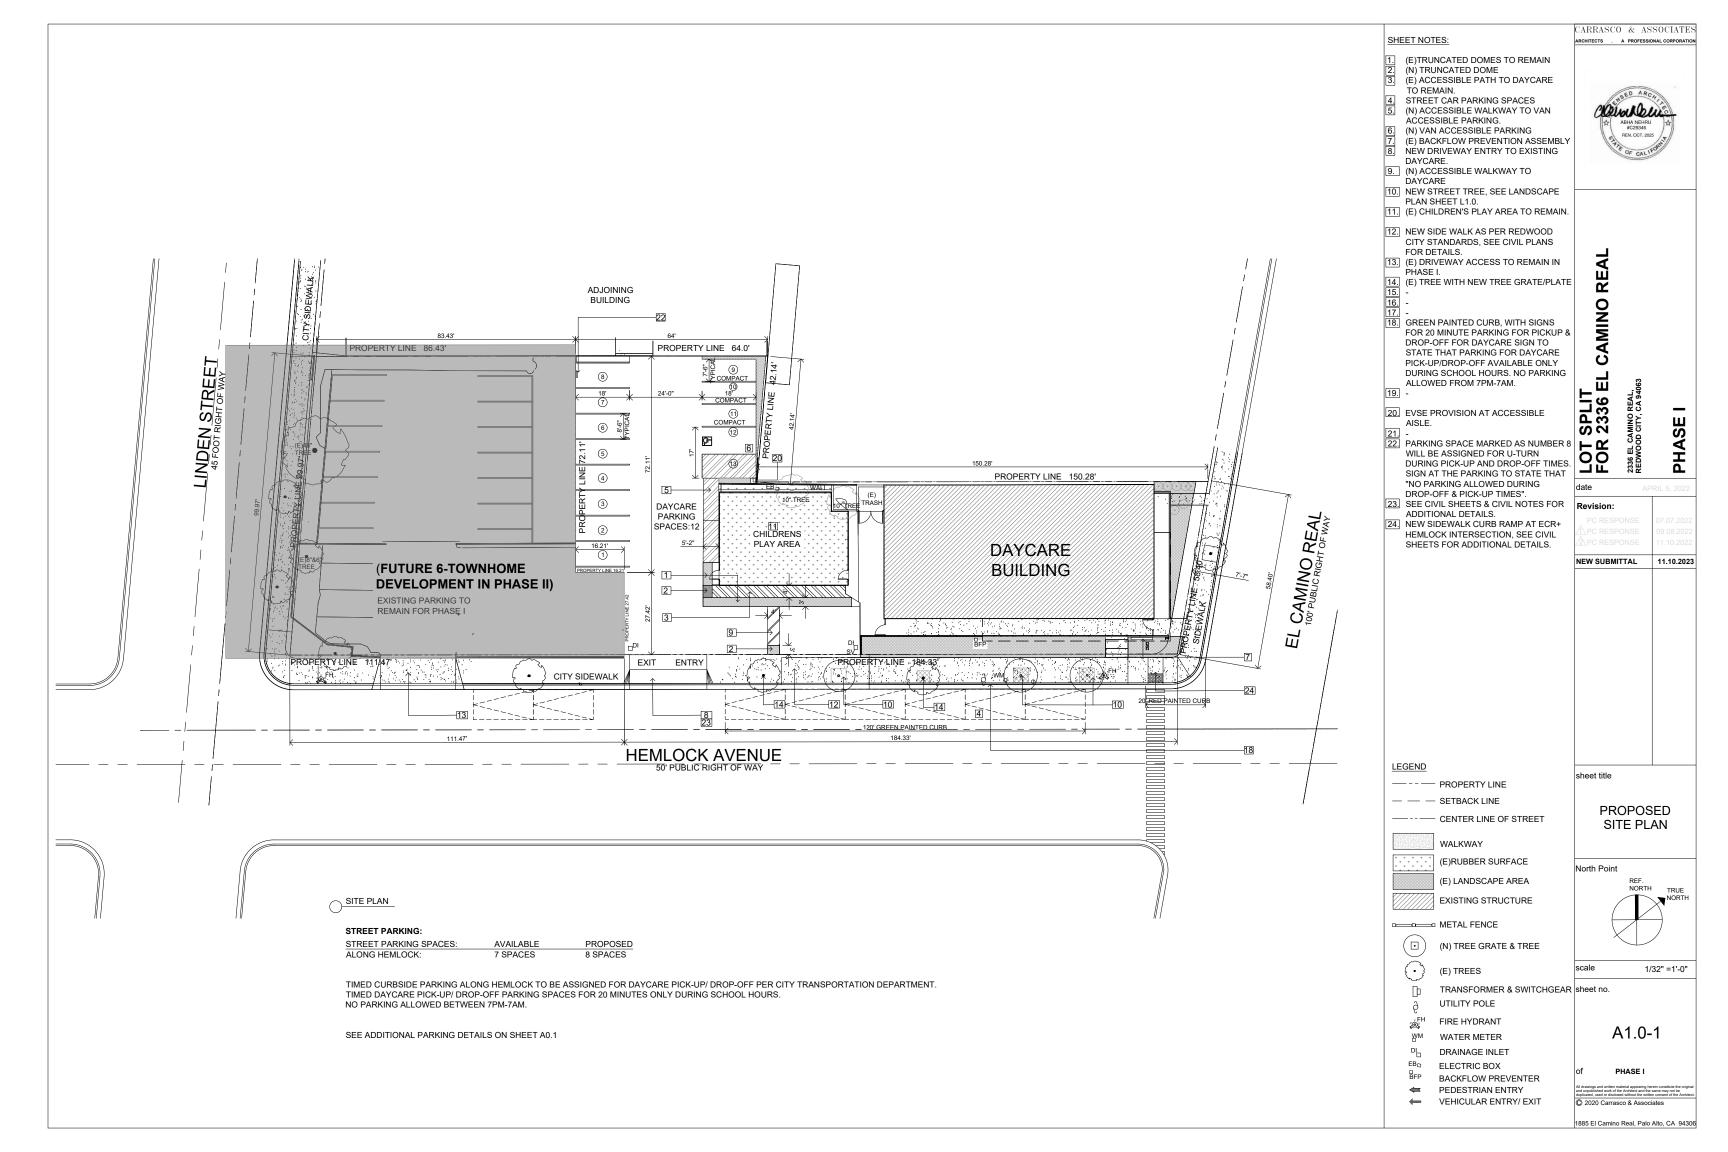

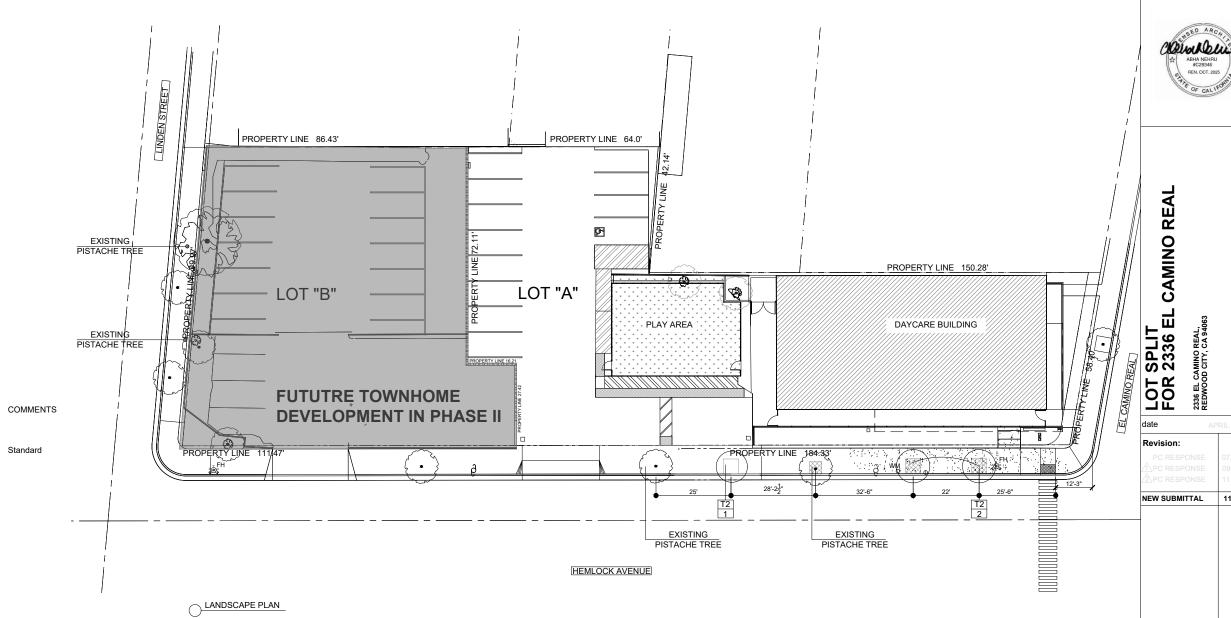



WATER

Standard

REQ'T

T2 - CHINESE PISTACHE

PLANT LEGEND:

TREES:

NOTES:

KEY BOTANICAL & COMMON NAMES


2. T2 — indicates plant key
3 — indicates plant count

T2 Pistacia c. "Keith Davies" / Chinese Pistache

1. Quantities in the Plant Legend are for general reference only (Verify count per Plan).

3. Location of trees and shrubs are schematic and shall be adjusted in the filed. TO avoid conflicts with utilities,tree roots, irrigation equipments, etc.

4. Refer to Details and Specifications for further information.

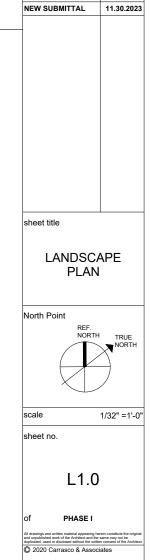

1885 El Camino Real, Palo Alto, CA 94306

CARRASCO & ASSOCIATES

**PHASE I** 







VIEW 5 - 47 HEMLOCK AVE



VIEW 2 - 26 HEMLOCK AVE

VIEW 3 - 26 HEMLOCK AVE







PROPOSED SITE, VICINITY MAP & ADJACENT ZONING

VIEW 6- 202 LINDEN STREET

VIEW 7- CORNER OF HEMLOCK AVE & LINDEN STREET





VIEW 9 - 134 HEMLOCK AVE



sheet title

PROJECT DATA ZONING ANALYSIS PARKING & OPEN SPACE ANALYSIS KEY PLAN MIXED USE CORRIDOR-EL CAMINO REAL (MUC-ECR) R3 OPEN SPACES: PROJECT ADDRESS: APN NO: PROPOSED 2336 EL CAMINO REAL, REDWOOD CITY,CA 94063 053-309-200 REQUIRED ZONING: PROPOSED OCCUPANCY ON LOT B: PRIVATE RESIDENTIAL OPEN SPACE REQUIREMENT:
MINIMUM AREA: 125 SQ.FT/PER UNIT
MINIMUM DIMENSION: 6 FT MIN. L/W 127 SQ.FT.MIN - 133 SQ.FT. ( VARIES), SEE IN SHEET A0.3 6 FT MIN (VARIES) LOT AREA A: LOT AREA B: 13,995 SQ.FT/ 0.32 ACRES (PHASE I) 9,487 SQ.FT/0.217 ACRES (PHASE II) TYPE OF CONSTRUCTION PROPOSED: TYPE IIIA PERMITTED
(FAR APPLICABLE TO COMMERCIAL USE ONLY) PRIVATE STORAGE AREA: (IN GARAGE) 80 CU.FT MIN. 6-TOWNHOMES (3 BR UNITS) PARKING: Per Article 30.4B of Redwood City Municipal Code PARKING SPACES REQUIR
PER RESIDENTIAL UNIT:
2 BR UNITS OR LARGER:
TOTAL PARKING REQUIREMENT HEIGHT & DENSITY STANDARDS 1 PER UNIT MAXIMUM HEIGHT & STORY: 85 FEET 34'-10" & THREE STORIES 17 DU ALLOWABLE DENSITY (80 DU/AC) 6 UNITS

BIKES PARKING: 1 CLASS 1 PER 3 UNITS 2 CLASS I BIKES 3 BIKE LOCKERS SETBACKS & SIDEWALK: GUEST BIKES PARKING 2 CIRCULAR BIKE RACKS PROPOSED 9'-7" & 9'-0" (HEMLOCK & LINDEN) FRONT SETBACK:
SIDE SETBACK:
STREET SIDE SETBACK:
REAR SETBACK: 6'-0" 5'-0" MIN (VARIES) 5'-0" MIN 5'-0" STREET PARKING SPACES: ALONG HEMLOCK: 4 SPACES ALONG LINDEN: TOTAL STREET PARKING

TIMED CURBSIDE PARKING ALONG HEMLOCK TO BE ASSIGNED FOR DAYCARE DROP OFF PER CITY TRANSPORTATION DEPARTMENT.




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SQUARE TOWNHOMES REDWOOD (2336 EL CAMINO REAL, REDWOOD CITY, CA 94063

REDWOOD 2336 EL CAMINO REA REDWOOD CITY, CA	PHASE II
date	
Revision:	
	SE 07.07.2022
	SE 09.08.2022
	SE 11.10.2022
NEW SUBMITTA	L 11.30.2023
⚠PC RESPONS	SE 02.12.2024
⚠PC RESPON	SE 03.04.2024

**NEIGHBORHOOD** CONTEXT & ZONING **ANALYSIS** 



sheet no.

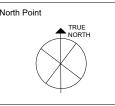A0.1 PHASE II 1885 El Camino Real, Palo Alto, CA 94306

NEW SUBMITTAL 11.30.2023

sheet no.


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NTS

### **EXTERIOR MATERIAL COLORS**



WINDOW SHADING PATTERN CREATES

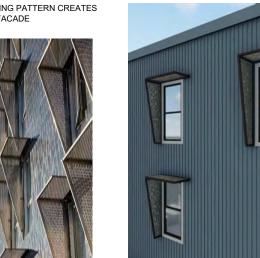

HORIZONTAL WINDOW AWNING

VERTICAL WINDOW AWNING

WINDOW CLOSE UP VIEW

WINDOW SHADING USING PERFORATED



(STREET TREES NOT SHOWN FOR CLARITY)




PROPOSED RENDERING OF PROJECT



COLOR TREATMENT OF WINDOW PROJECTIONS NIGHT SHADE-2116-10 AT FRAME WITH HINT OF MINT-505 (PERFORATED STEEL AWNING)



PANEL SIDING CREATING VERTICAL FACADE PATTERN WITH 6" AND 11" EXPOSURE

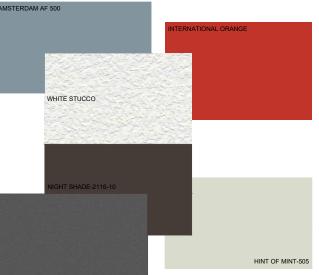

COLOR PALETTE



SELECTED COLOR MIX OF GREY, WHITE & BLUE WITH SIDING


COLOR TREATMENT OF GUARD RAIL - PERFORATED STEEL INFILL


FROSTED GLASS GARAGE DOORS

- HINT OF MINT-505

- TRELLIS INTERNATIONAL ORANGE
  (ENGINEERING)
  VERTICAL SIDING AMSTERDAM AF 500
  WOOD TRIM DARK GREY STUCCO
  WINDOW FRAME NIGHT SHADE-2116-10
  GARAGE DOOR FRAME NIGHT
- SHADE-2116-10 PERFORATED STEEL AWNING - HINT OF MINT-505
- GUARD RAIL-PERFORATED STEEL INFILL-HINT OF MINT-505 BIKE LOCKERS HINT OF MINT-505
- - WALKWAY DARK GREY MECHANICAL SCREENING DARK GREY

PHASE II

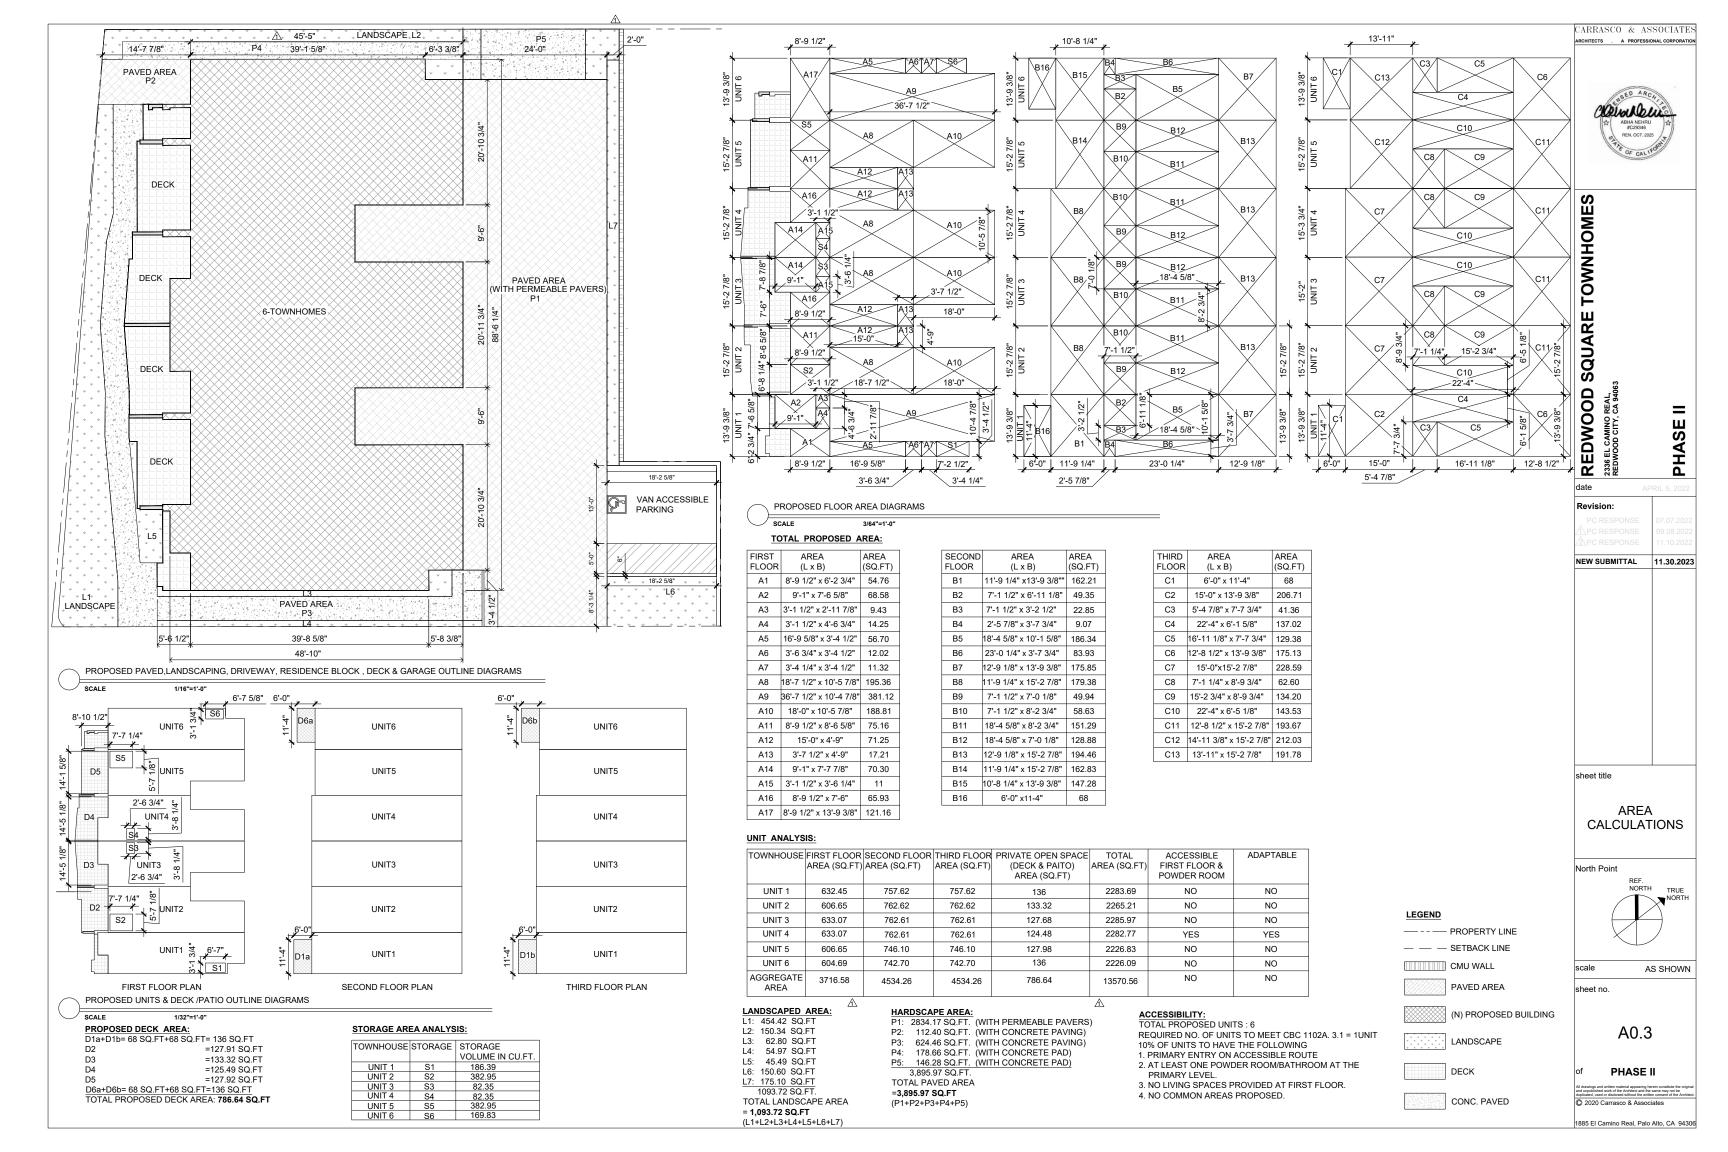

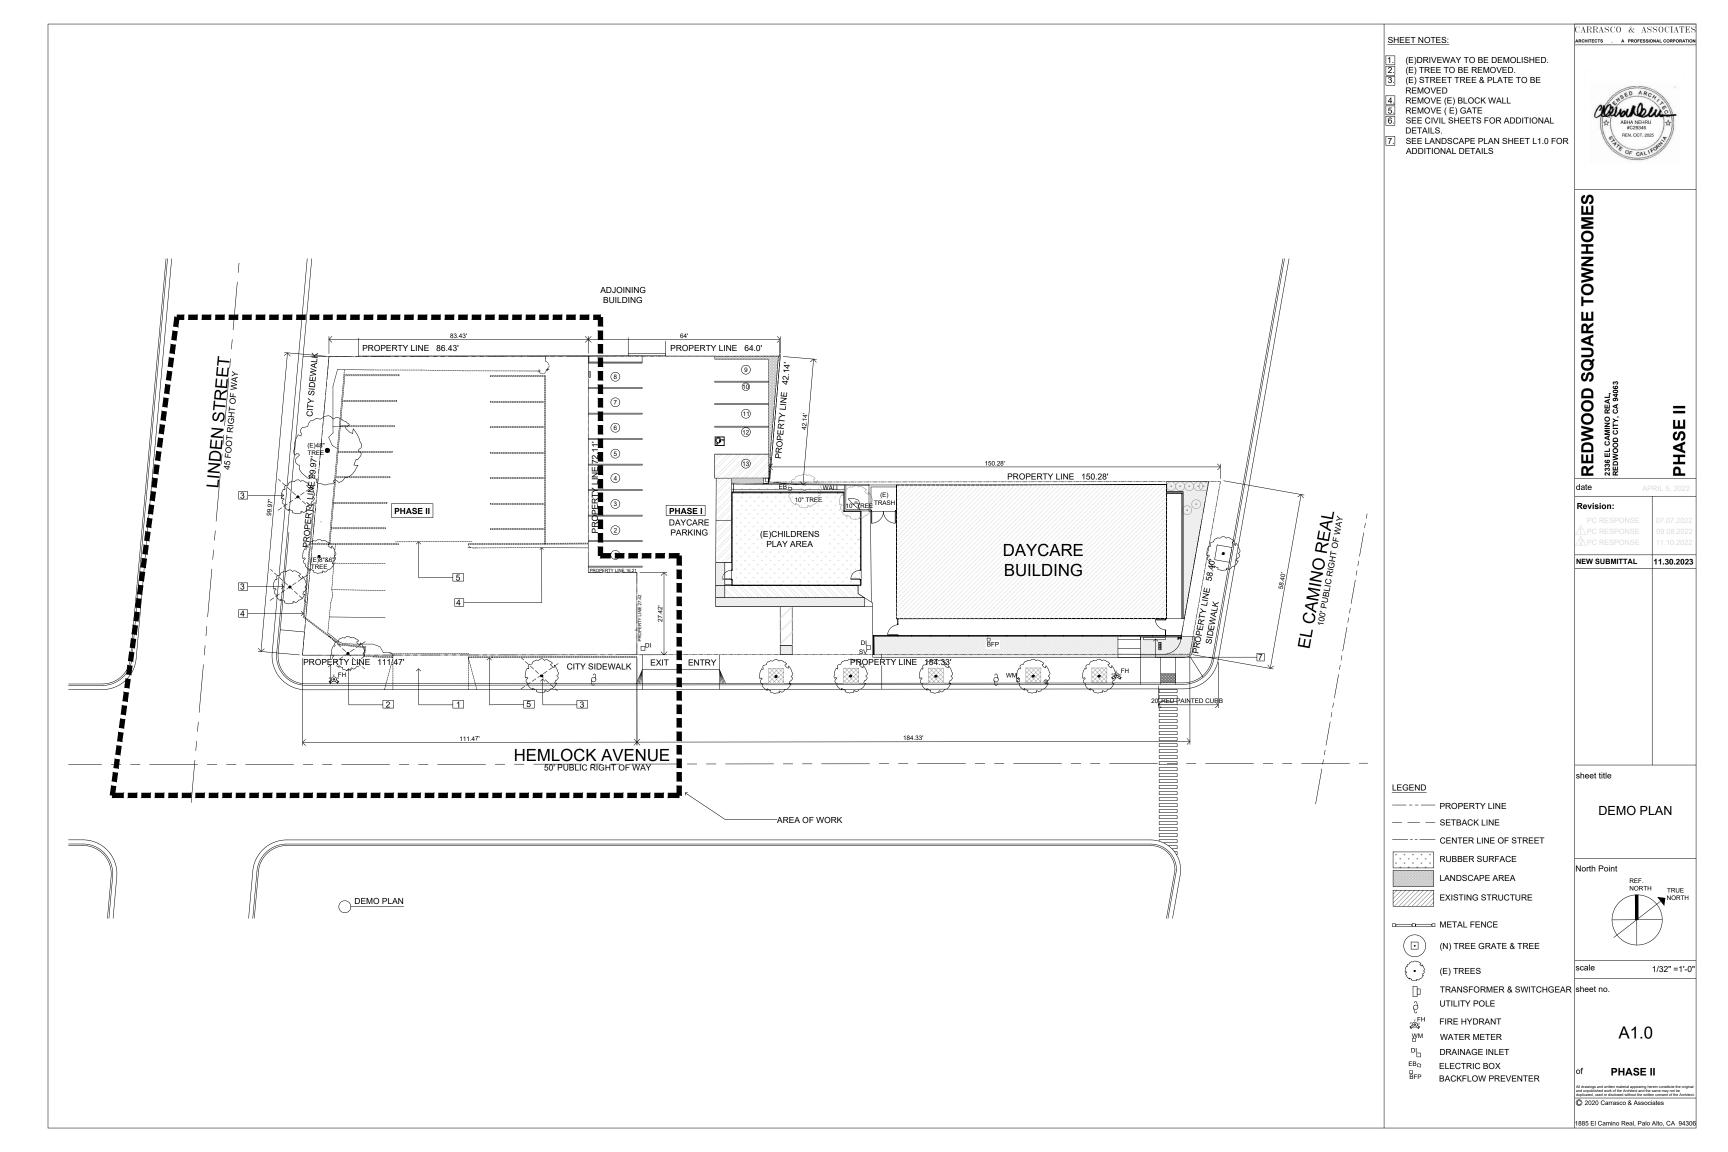



VIEW -1
LOOKING WEST ON LINDEN STREET



<u>VIEW -2</u> LOOKING SOUTH ON HEMLOCK AVENUE

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REDWOOD SQUARE TOWNHOMES
2336 EL CAMINO REAL,
REDWOOD CITY, CA 94063

DAMOOD CITY, CASP.

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PC RESPONSE

11.10.2022

NEW SUBMITTAL 11.30.2023

sheet title

3D VIEWS

North Point

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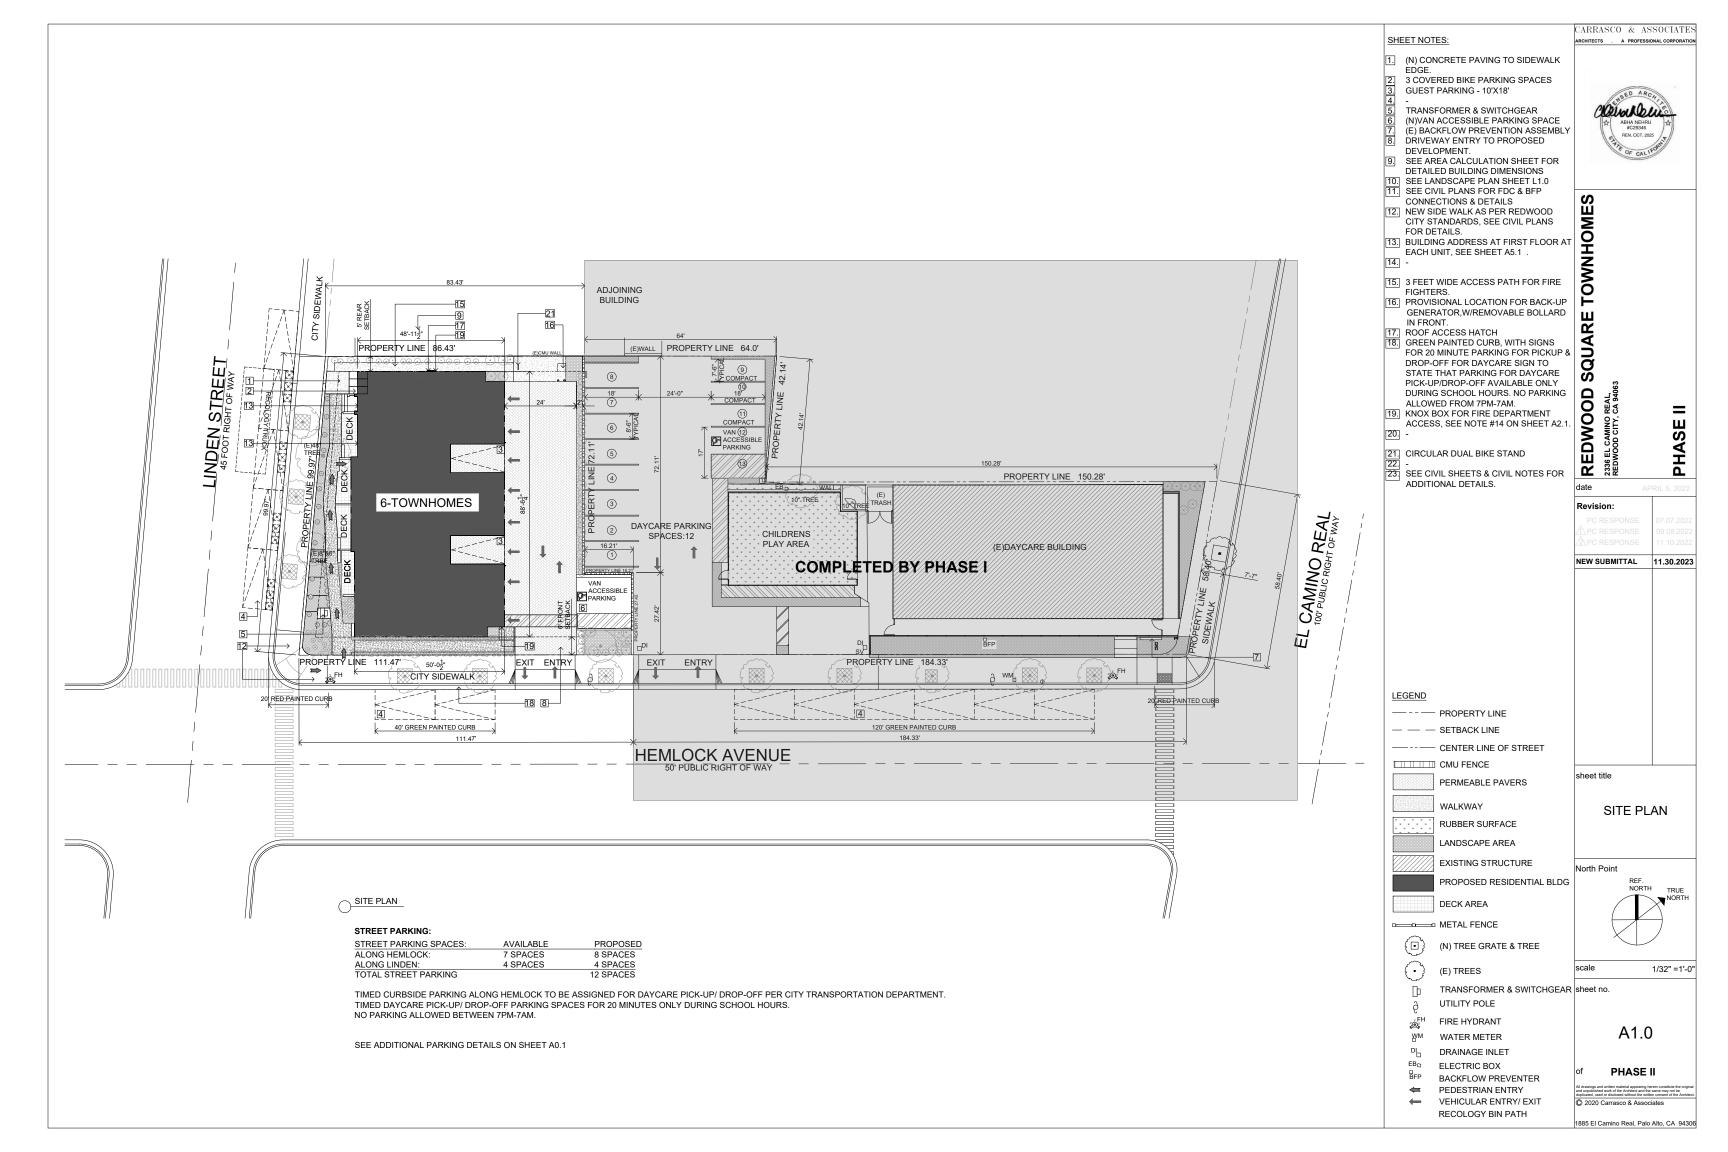
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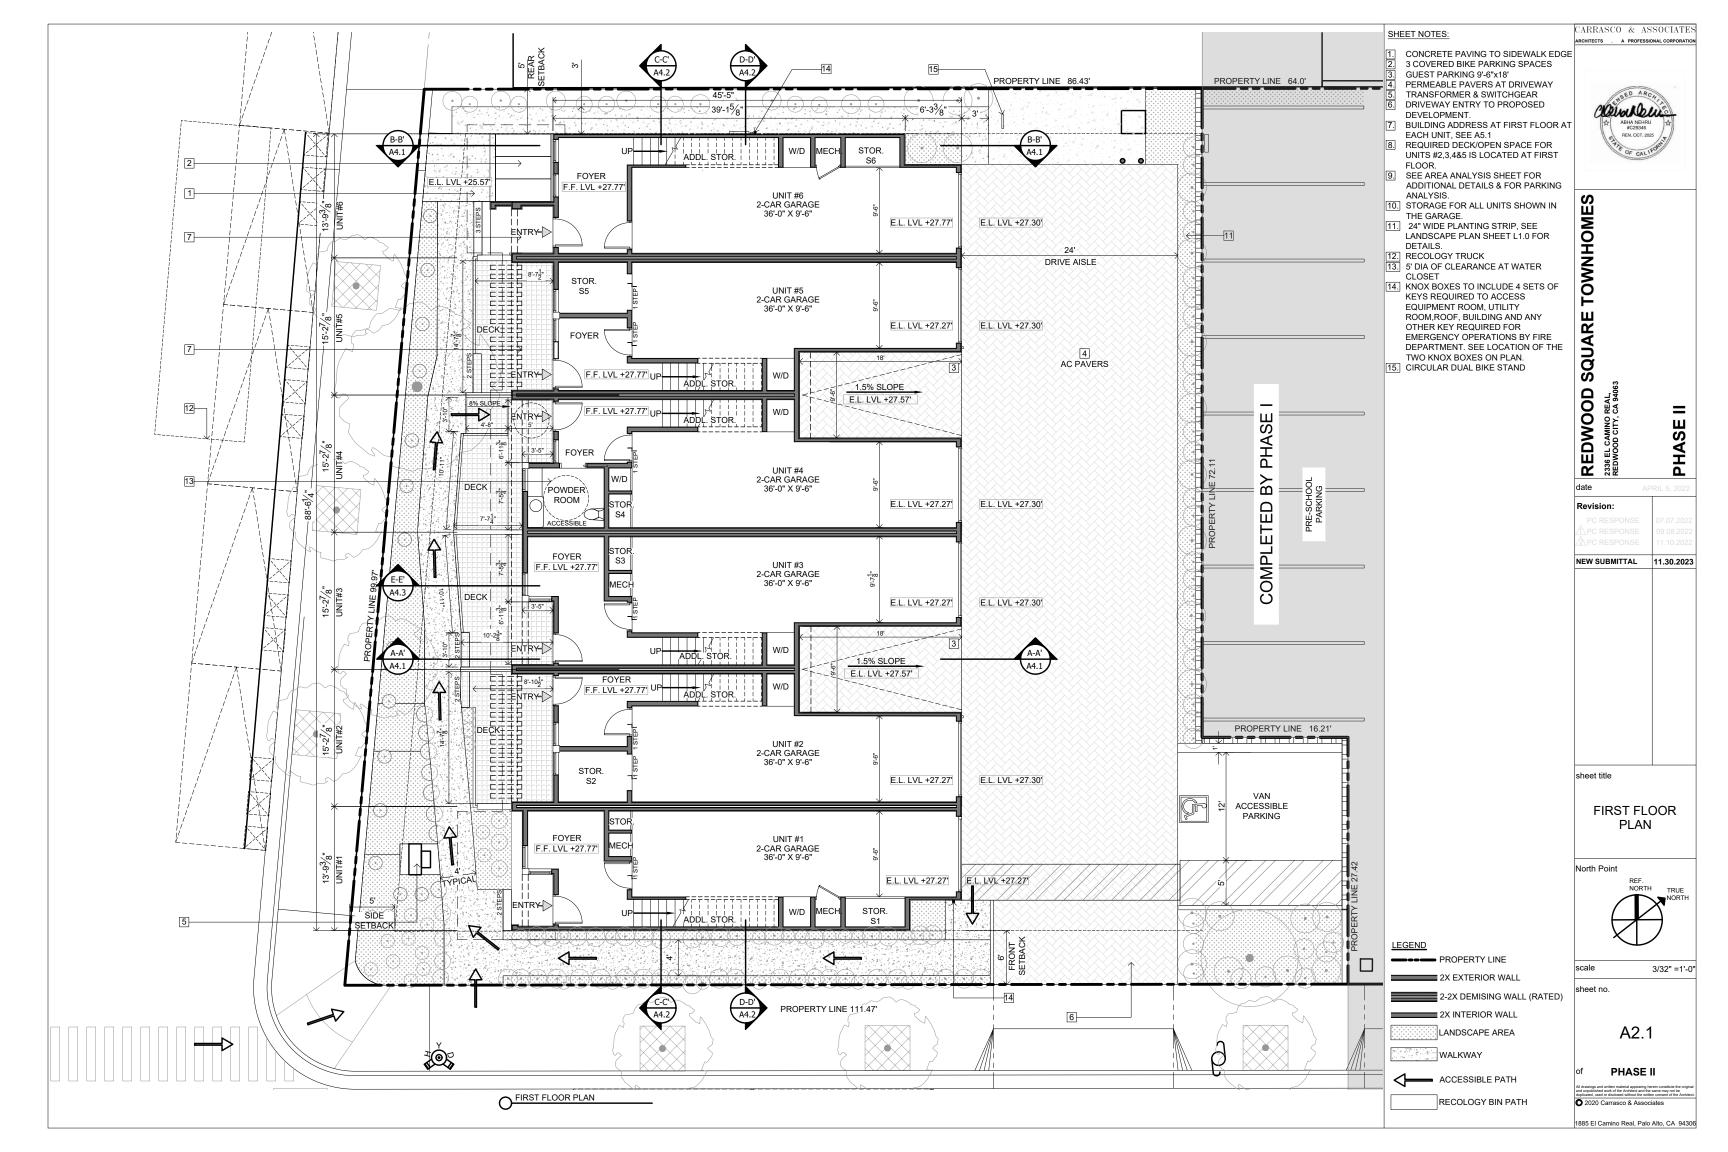
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f PHASE II

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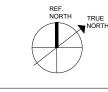
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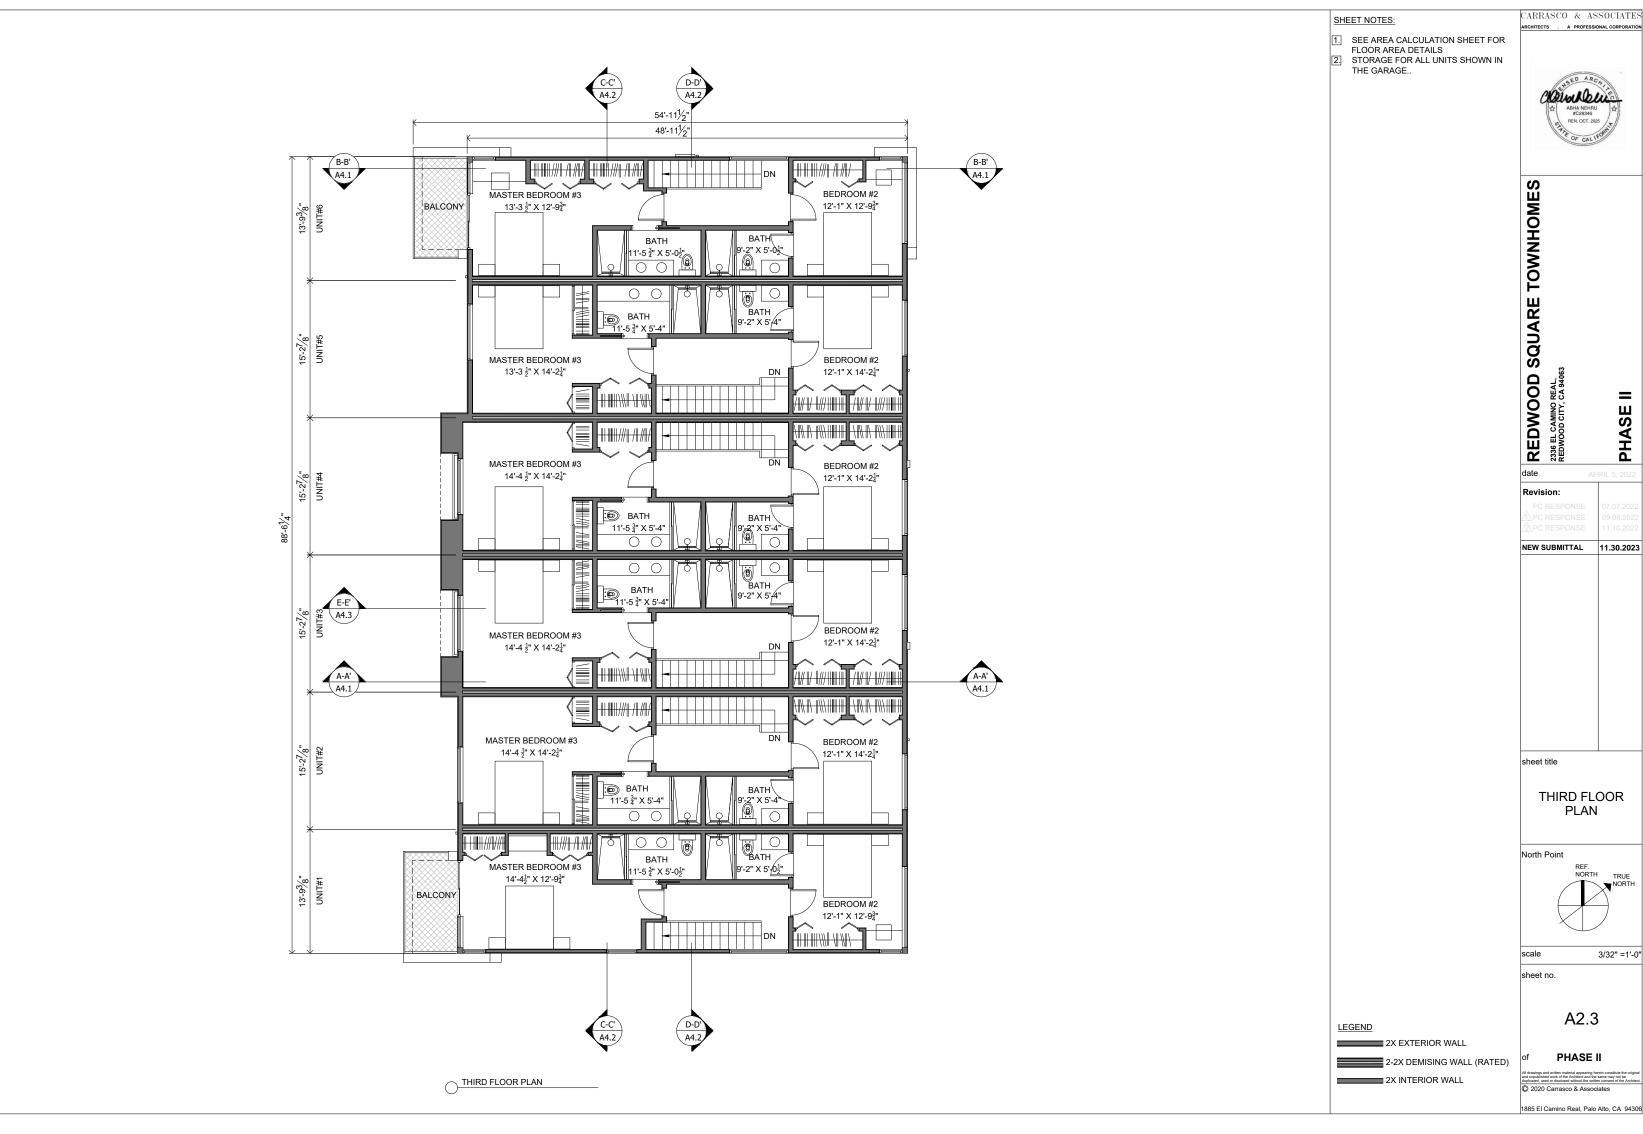
















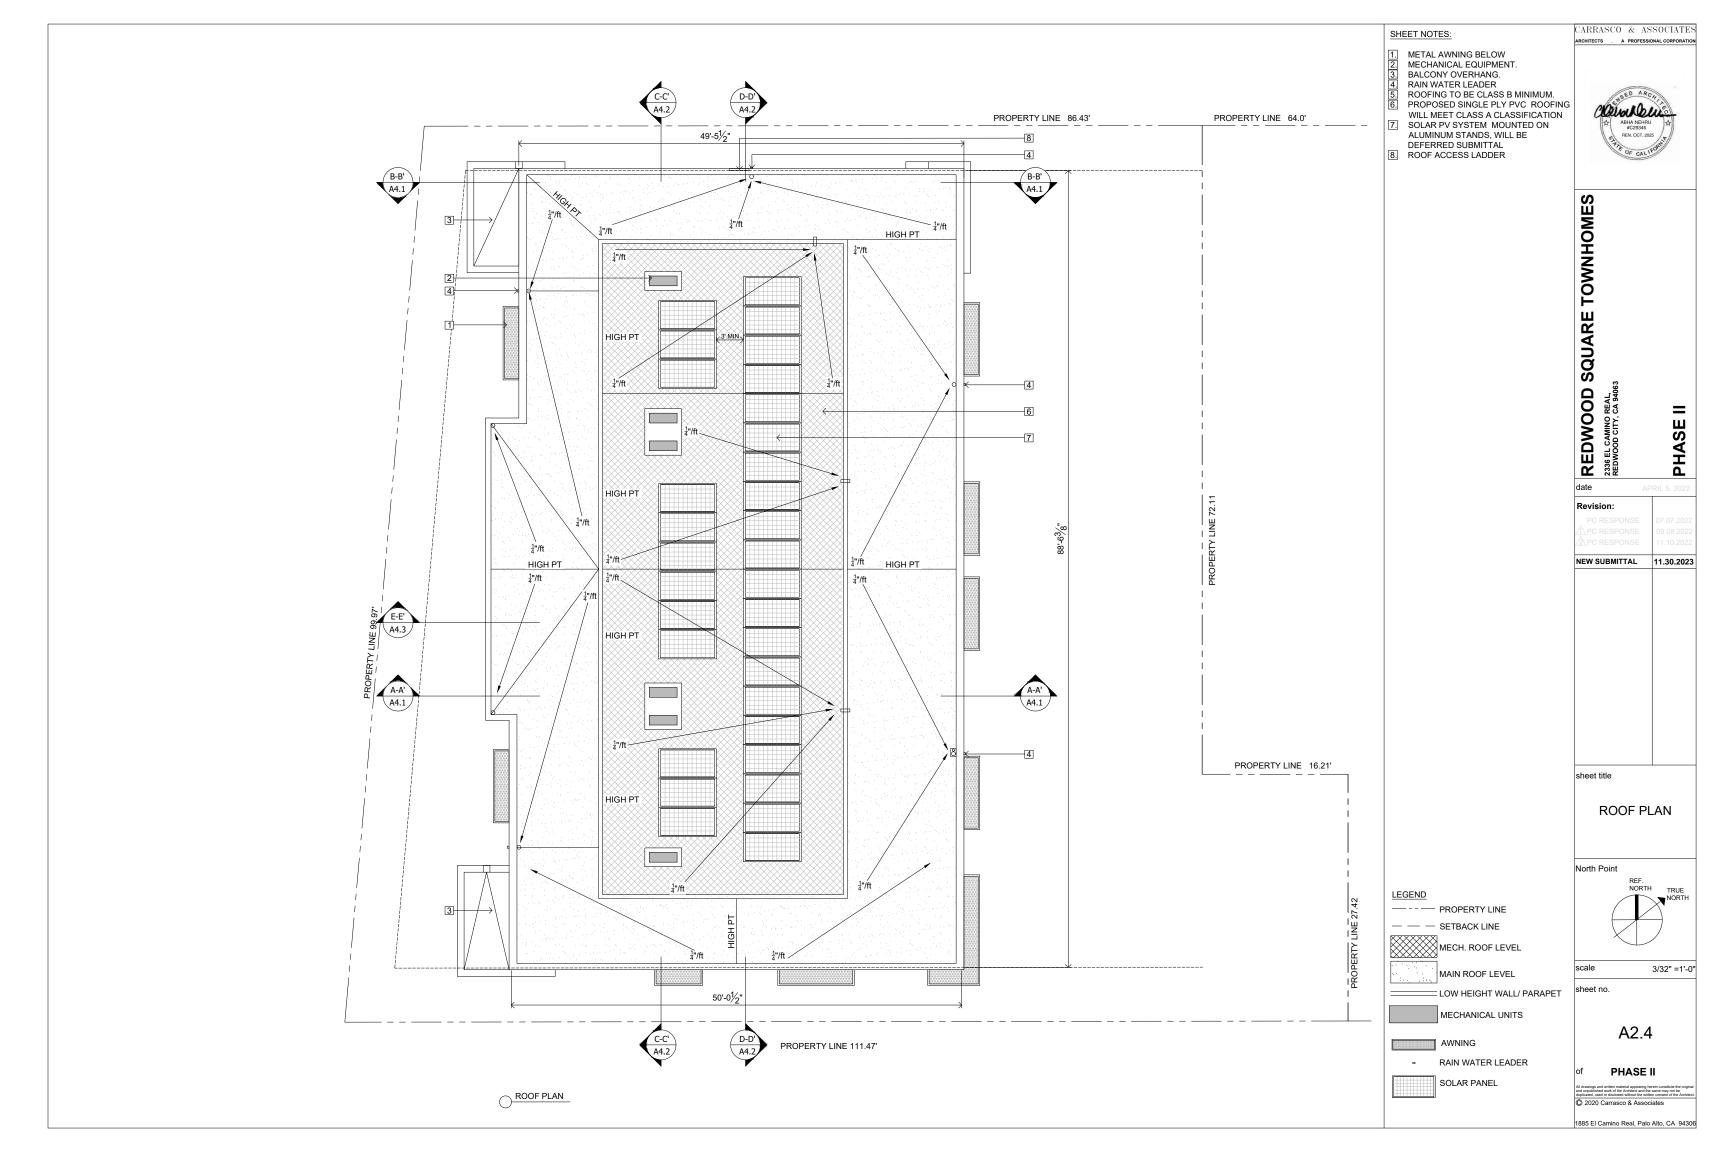

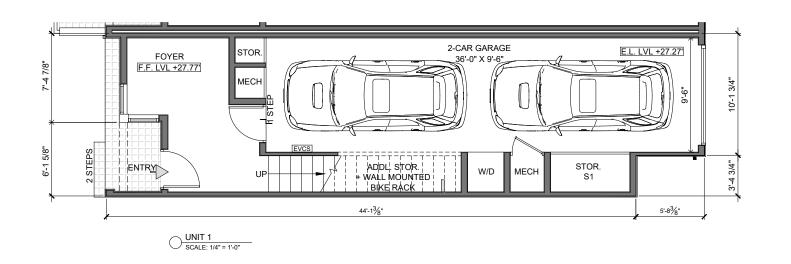

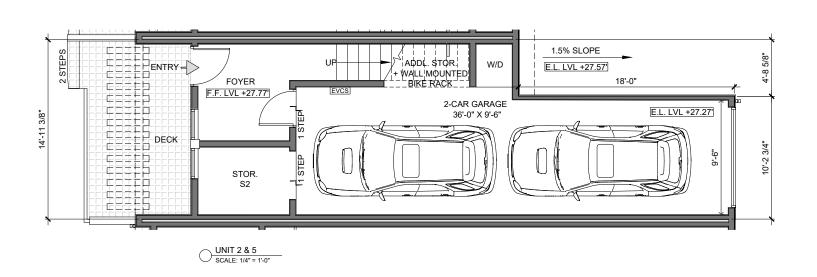

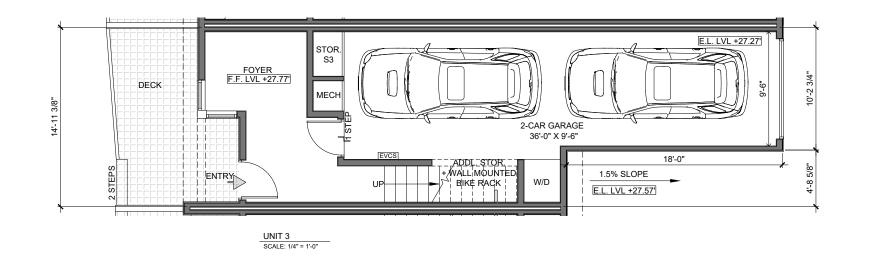

### SHEET NOTES:

1. ALL PROPOSED PRIVATE GARAGES TO HAVE A LEVEL 2 EV READY CIRCUIT AND LEVEL 1 EV READY CIRCUIT , PER GBSC 4.106.4.1 AMENDED BY RWC



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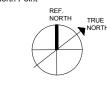
# REDWOOD SQUARE TOWNHOMES 2335 EL CAMINO REAL, REDWOOD CITY, CA 94063 PHASE II

date A	PRIL 5, 2022
Revision:	
	07.07.2022
	09.08.2022
	11.10.2022
NEW SUBMITTAL	11.30.2023

sheet title

### ENLARGED UNITS FIRST FLOOR PLAN #1,2,3 & 5

North Point



scale 1/8" =1'-0"

WALL MOUNTED BIKE RACK sheet no.

LEGEND

 $\rightarrow$ 

APPROACH

ELECTRIC VEHICLE CHARGING STATION. SEE NOTE #1 UNDER


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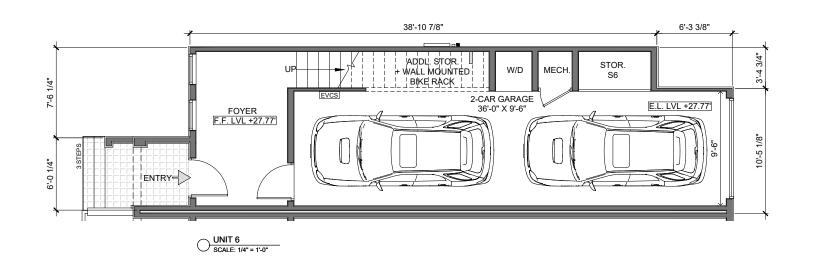
of PHASE II

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1885 El Camino Real, Palo Alto, CA 94306





### SHEET NOTES:

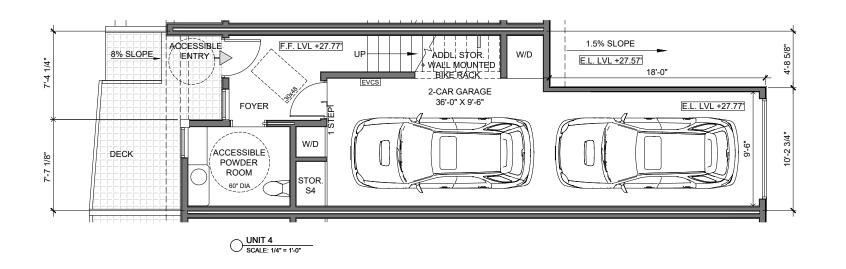LEGEND

APPROACH

WALL MOUNTED BIKE RACK

1. ALL PROPOSED PRIVATE GARAGES TO HAVE A LEVEL 2 EV READY CIRCUIT AND LEVEL 1 EV READY CIRCUIT , PER GBSC 4.106.4.1 AMENDED BY RWC



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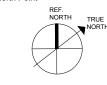
REDWOOD SQUARE TOWNHOMES
2338 EL CAMINO REAL,
REDWOOD CITY, CA 94063

PHASE II

date	APRIL 5, 2022		
Revision:			
	07.07.2022		
	09.08.2022		
	11.10.2022		
NEW SUBMITTAL	11.30.2023		
sheet title			

### ENLARGED UNITS FIRST FLOOR PLAN #4 & 6

North Point



EVCS ELECTRIC VEHICLE CHARGING STATION. SEE NOTE #1 UNDER SHEET NOTES.			
		scale	1/8" =1'-0"


sheet no.


A2.6


of PHASE II


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REDWOOD SQUARE TOWNHOMES
2335 EL CAMINO REAL,
REDWOOD CITY, CA 94063

Revision:

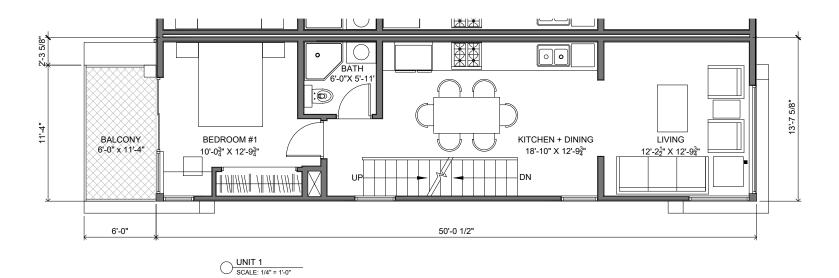PHASE II

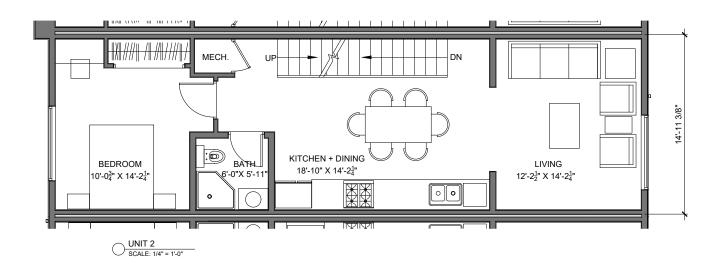NEW SUBMITTAL 11.30.2023

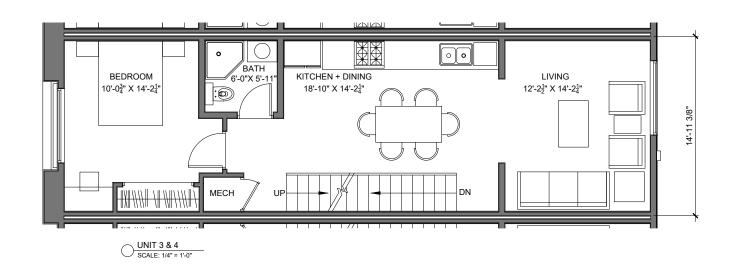sheet title

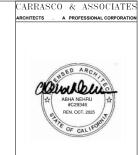**ENLARGED UNITS** SECOND FLOOR PLAN #1,2,3 & 4


North Point


1/8" =1'-0"

sheet no.

A2.7

PHASE II

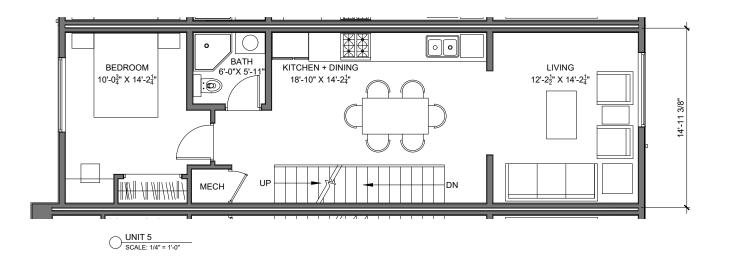

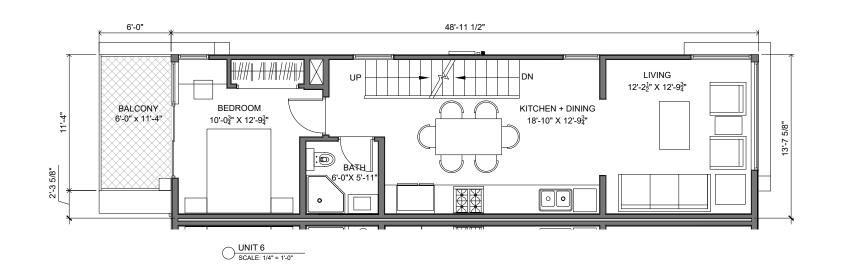

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REDWOOD SQUARE TOWNHOMES
2336 EL CAMINO REAL,
REDWOOD CITY, CA 94063

Revision:


PHASE II

NEW SUBMITTAL 11.30.2023

sheet title

ENLARGED UNITS SECOND FLOOR PLAN #5 & 6

North Point

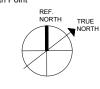



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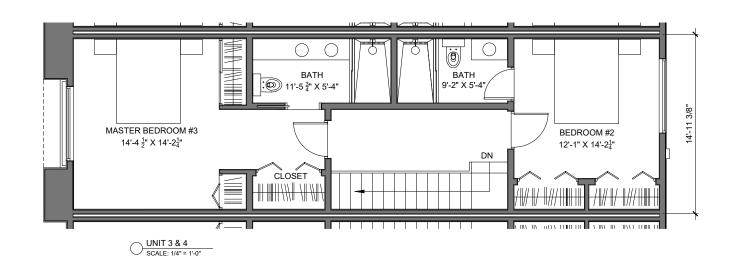
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A2.8

PHASE II





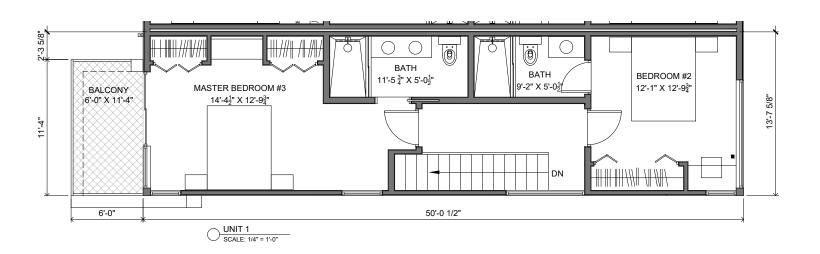

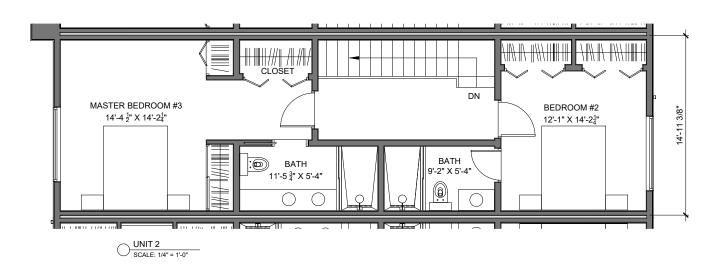

CARRASCO & ASSOCIATES

REDWOOD SQUARE TOWNHOMES
2335 EL CAMINO REAL,
REDWOOD CITY, CA 94063

BHASE III

 ⚠PC RESPONSE
 09.08.2022

 ⚠PC RESPONSE
 11.10.2022

 NEW SUBMITTAL
 11.30.2023

sheet title

### ENLARGED UNITS THIRD FLOOR PLAN #1,2,3 & 4

North Point

REF.
NORTH
TRU
NOF

scale 1/8" =1'-0"


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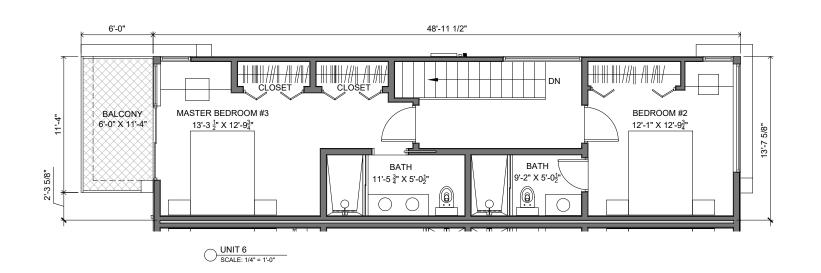
A2.9

of PHASE II

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REDWOOD CITY, CA 94063

REDWOOD CITY, CA 9.

PHASE II

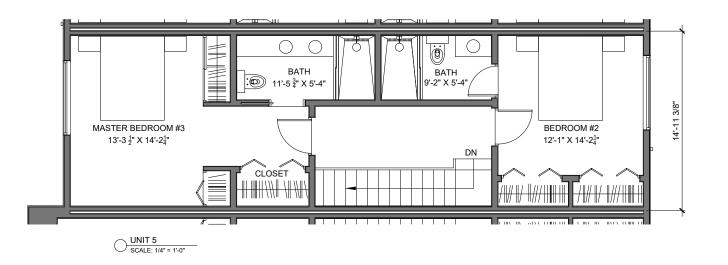Revision:

PC RESPONSE

PC RESPONSE

07.07.2022


09.08.2022

NEW SUBMITTAL 11.30.2023

sheet title

ENLARGED UNITS THIRD FLOOR PLAN #5 & 6

North Point

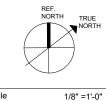

sheet no.


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A2.10


of PHASE II

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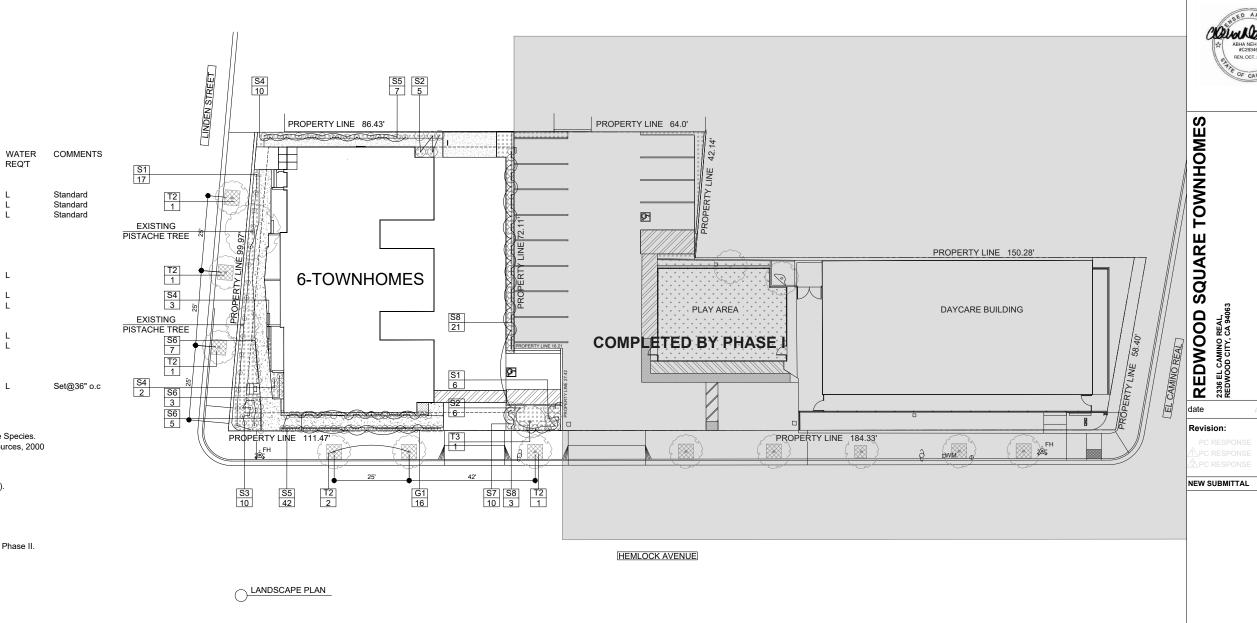






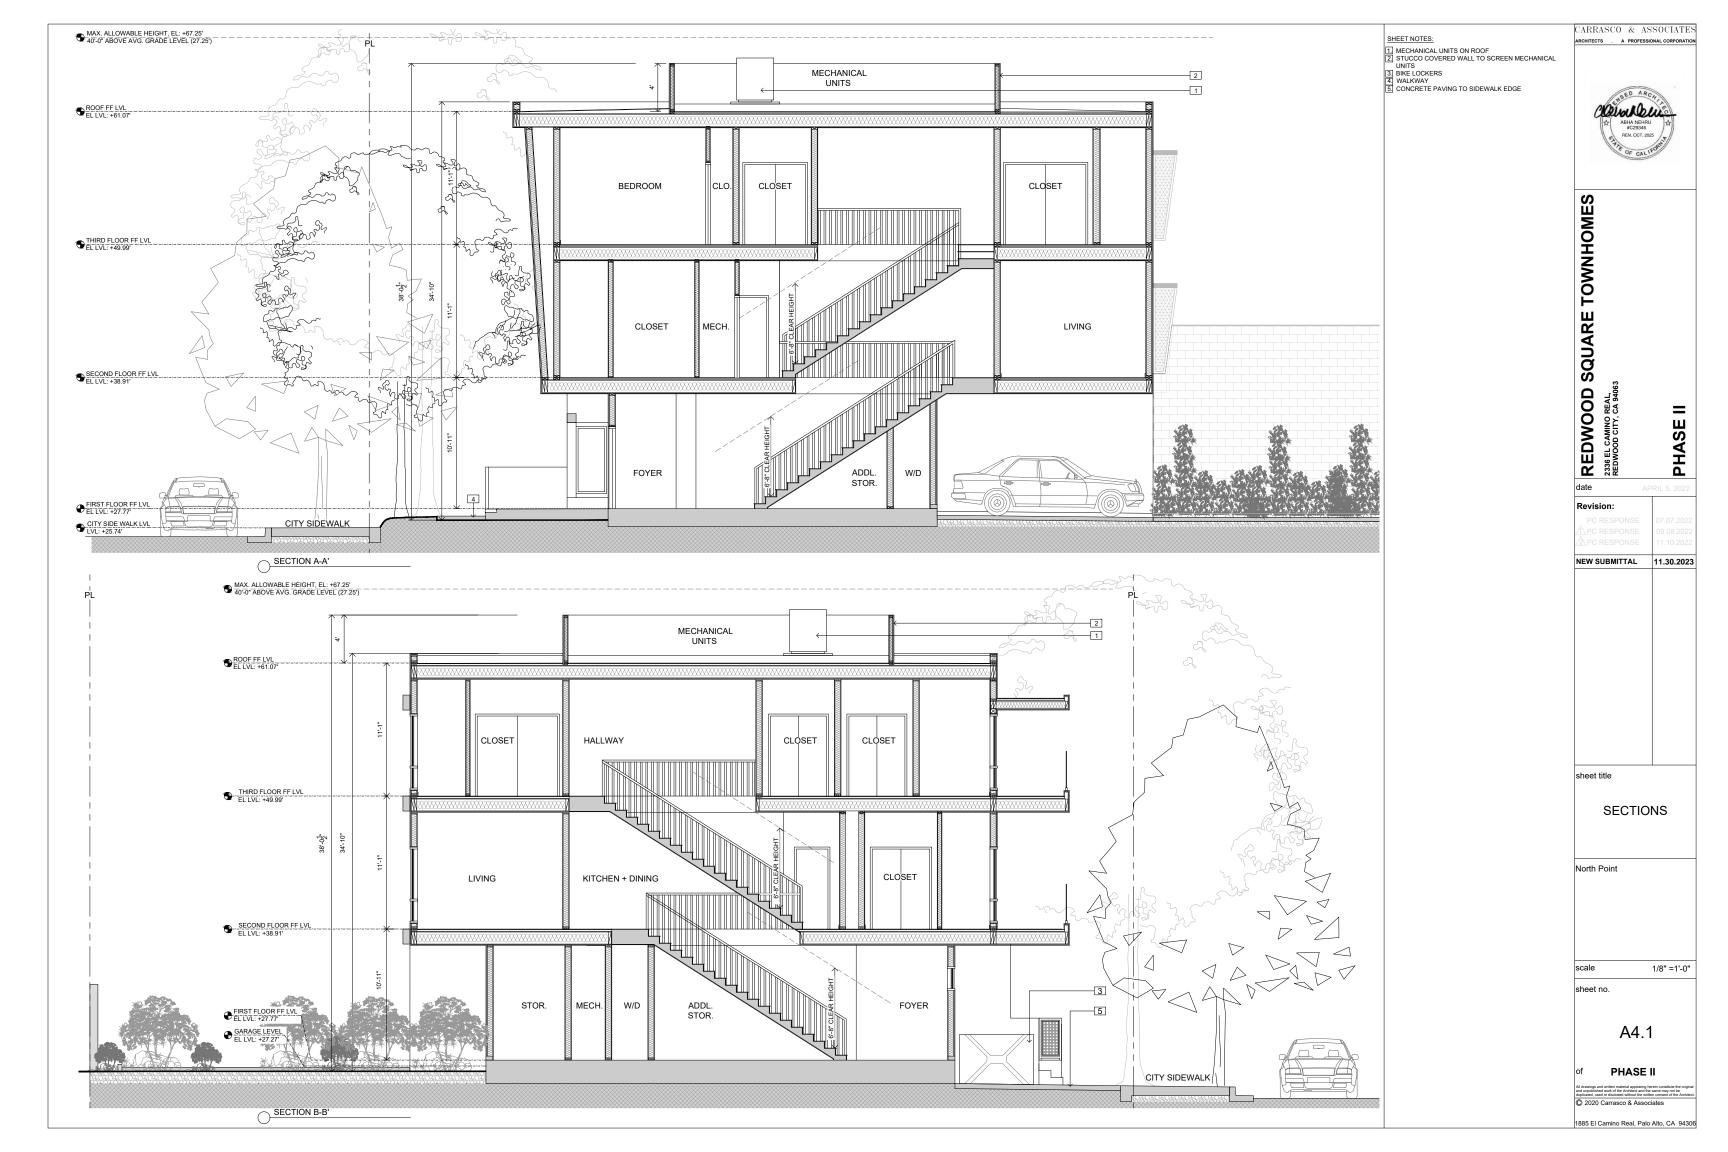

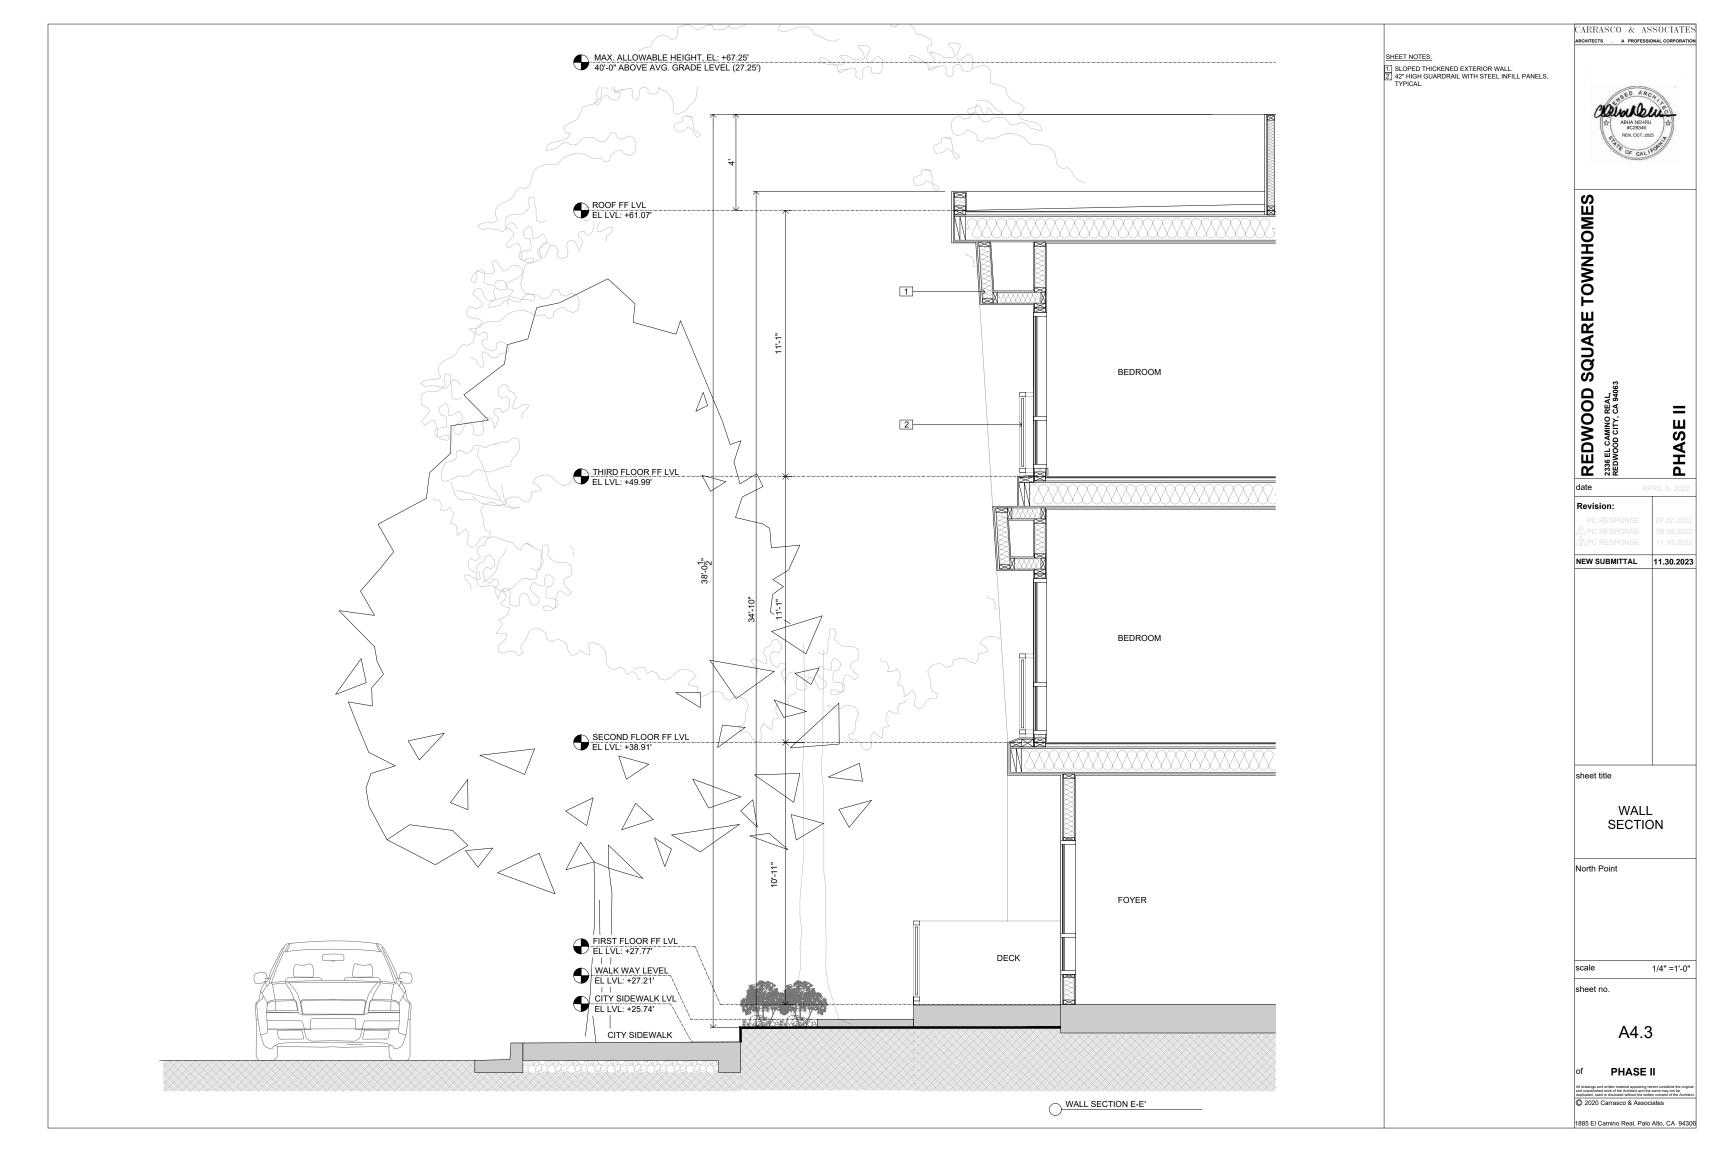11.30.2023



S8 - NANDINA D. HEAVENLY BAMBOO

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PHASE

11.30.2023

LANDSCAPE PLAN

L1.0

PHASE II

1885 El Camino Real, Palo Alto, CA 94306

1/32" =1'-0"

North Point

sheet no.



S7 - SALVIA M. SAGE

G1 - HELICTOTRICHONS- BLUE OAT GRASS

PLANT LEGEND:

TREES:

\* SEE NOTE #5

SHRUBS:

GROUNDCOVERS:

2. sindicates plant key indicates plant count

S5 - RHODODENDRON

KEY BOTANICAL & COMMON NAMES

T1 Lophostemon confertus / Brisbane box

T2 Pistacia c. "Keith Davies" / Chinese Pistache
 T3 Lagerstroemia X Biloxi/Crape Myrtle

S1 Bidens F. "Golden Eye" / Bidens
 S2 Coleonema P. "Sunset Gold" / Breath of Heaven
 S3 Loropetalum C. "Plum Delight" / Chinese Fringe Flower

S4 Polygala F. "petite butterfly" / sweet pea shrub
S5 Rhododendron

S6 Agapanthus Galaxy Blue S7 Salvia M. "Hot Lips"/ Sage S8 Nandina D. "Gulf Stream" / Heavenly Bamboo

Lantana montevidensis / Trailing Lantana

Helictotrichons. "Sapphire" / Blue Oat Grass

Water conservation classification is based on Water Use Classification of Landscape Species

Quantities in the Plant Legend are for general reference only (Verify count per Plan).

5. A total of 9 new Chinese Pistache trees to be planted after completion of Phase I & Phase II.

G2-TRAILING LANTANA

Location of trees and shrubs are schematic and shall be adjusted in the filed.
 TO avoid conflicts with utilities,tree roots, irrigation equipments, etc.
 Refer to Details and Specifications for further information.

(WUCOLS) prepared by WaterConvervation Office of the Department of Water Resources, 2000

SIZE

24" box

24" box 24" box

5 gl.

15gl. 15gl. 5gl. 5gl.

S6 - AGAPANTHUS GALAXY BLUE