

# NEW CONSTRUCTION OF BAYSHORE TECH PARK

Project Address 800, 1400, 1600 AND 3400 BRIDGE PKWY, 94065

Prepared for

REDWOOD LIFE

Developer



Issued information

04/22/21

## **REDWOOD LIFE**

PRE-PLANNING APPLICATION

#### **Project Description**

Located on approximately 84-acres between Belmont Slough and Marine Parkway, the Redwood LIFE project will transform the existing 20-building office park into a premier life sciences campus that thoughtfully engages its location and community. The Redwood LIFE project envisions the carefully sequenced development of research and development space (laboratory and office), a hotel with 150 keys, and several amenity spaces serving the campus and community - creating a vibrant 3.39 million square foot campus across four reconfigured parcels. Over the course of development, the existing 1990's-era buildings will be demolished and replaced with up to 16 new buildings. Parking will shift from existing surface parking to a thoughtful mix of above-grade garages and podium parking,

thereby allowing for a significant expansion of the site's open spaces, for both passive and active use. Access to the waterfront will also be enhanced.

The project will request an entitlements package centered around a new Redwood LIFE Precise Plan that will supersede the outdated Westport Specific Plan and provide a thoughtful, comprehensive, and cohesive set of design and development standards for the project area. The plans will include a comprehensive transportation demand management program to limit car trips and a vision for how the project will contribute to the region's affordable housing supply.

#### **Development Standards**

- 1. General Plan
- Land Use
- Commercial Office Professional/Technology
- Building Height
- General Plan Maximum Height: 5 stories; 8 stories as part of coordinated master plan
- Maximum 0.8 FAR;
- FAR Exempt: Child care center, public conference facilities and meeting rooms, mezzanine floor area, parking garages, car ports and parking structures.
- FAR Bonus: 0.2 FAR; Bonus conditions to be met:
- Allow public access to the shoreline and bay.
- Provide 10% of project area as public or quasi-public usable open space adjacent to the water's edge.
- Provide publicly-accessible pedestrian and bike paths along the water's edge, while connecting them to existing and planned networks.
- Docks and / or pedestrian and bike networks to connect the project to existing marinas when possible.
- Record a public access easement against the property to ensure public access to the project portion for the far bonus.
- 2. Redwood City Code of Ordinances
- Land Use: CP Commercial Park
- Setbacks
- o Front Yard Minimum: 25 ft., (For every 1 foot the building exceeding 35 ft in height, 1 additional foot of front yard shall be required. Minimum front yards shall be permanently landscaped.)
- O Side Yards: 30 ft. combined (No one side shall have a width of less than 10 ft. Side yards on the street side of corner lots shall be equal in depth to the front yard requirement specified herein, and the 10 feet of such side yard adjacent to the street shall be permanently landscaped.)
- o Rear Yard Minimum: 25 ft. (For every 1 foot the building exceeds 35 ft in height, 1 additional foot of rear yard shall be
- Pervious Area and Stormwater Requirements: Minimum 40% of each lot to be composed of landscaping, vegetated open space, or permeable paving materials.
- Parking
  - Vehicular Spaces by Use
  - R&D labs and offices: 1 space per 250 SF gross floor area devoted to office and administrative uses; plus 1 space per every 2 employees on the maximum work shift (but not less than 1 space per 600 SF gross floor area) for areas devoted to laboratory, manufacturing or assembly; plus 1 space per every 1,000 SF gross floor area devoted to warehouse use.
  - Hotels: 1 space per living or sleeping unit + spaces for other uses such as restaurants per requirements for those
  - Restaurants (not fast food): 1 space per each 3 seats
  - Retail: 1 space per 200 SF gross floor area
  - Vehicular Parking Types
  - EV Parking (Primary Office Use (R&D Office)
  - Level 2 EVCs equipped spaces When 10 or more parking spaces are constructed, 10% of the available parking spaces on site shall be equipped with Level 2 EVCS.
  - Level 1 EV Ready Spaces An additional 10% shall be provided with at least Level 1 EV ready spaces.
  - At Least EV Capable An additional 30% shall be at least EV Capable.
  - EV Parking Primary Non-Office Use (R&D Lab)
  - Level 2 EVCs equipped spaces When 10 or more parking spaces are constructed, 6% of the available parking spaces on site shall be equipped with Level 2 EVCS.
  - Level 1 EV Ready Spaces An additional 5% shall be at least Level 1 EV Ready.
  - Clean Air Vehicle Parking: EVCS qualify as designated parking as described in Section 5.106.5.2 Designated parking for clean air vehicles.
  - Carpool and/or Vanpool Parking: 10% of Total Stalls for Professional Office Use.
  - ADA Parking
  - 1,001 spaces and over: 20 Stalls, plus 1 for every 100 Stalls, or fraction thereof, over 1,000. 1 Van for every 6 or Fraction of 6 ADA Parking.
  - 501-1,000 spaces: 2% of total, plus 1 Van for every 6 Accessible Parking.
  - Motorcycle Parking: 5% of Required Parking Spaces in a Parking Area with 100 or more Cars.
  - Bicycle Parking: No less than one (1) bicycle parking space per five thousand (5,000) square feet of floor area. For those uses which require carpool parking, two (2) carpool spaces may be eliminated for every off-street bicycle parking area that allows for the storage of five (5) bicycles. However, no more than twenty (20) percent of
- designated carpool parking spaces shall be eliminated and substituted for bicycle parking.

### 3. The Green Building Code

- Bicycle Parking
  - Short-term CalGreen: If the new project or an addition or alteration is anticipated to generate visitor traffic, provide permanently anchored bicycle racks within 200 feet of the visitors' entrance, readily visible to passers-by, for 5 percent of new visitor motorized vehicle parking spaces being added, with a minimum of one two-bike capacity rack. Exception: Buildings with less than 9 visitor parking spaces do not require short-term bike parking.
  - Long Term CalGreen: For new buildings with tenant spaces that have 10 or more tenant-occupants, provide secure bicycle parking for 5 percent of the tenant-occupant vehicular parking spaces with a minimum of one bicycle parking facility.

#### **Project Data Summary**

Net Site Area	79.66 acs	3,470,267 SF
Drainage Easement on Site	4.62 acs	201,219 SF
Site Area	84.28 acs	3,671,486 SF

#### **Site Calculation**

**Existing Parcel Areas** 

Parcel A (APN: 095-012-220)	8.00 acs		
Parcel B (APN: 095-012-450)	17.68 acs		
Parcel C (APN: 095-012-460)	56.45 acs		
Parcel D (APN: 095-012-150)	2.15 acs		
Total	84.28 acs		
Proposed Parcel Areas	Parcel Area	Drainage Facement Area	Net Area for FAR
	raicei Aica	Drainage Easement Area	NELAIEA IOI FAR
Parcel 1 (Oak)	25.99 acs	2.70 acs	23.29 acs
•		•	

5.18 acs

84.28 acs

0.59 acs

4.62 acs

4.58 acs

79.66 acs

#### Site Coverage Summary

Parcel 4 (Amenity Center)

Total

Pervious Area	40%	33.66 acs
Open Space	11%	9.27 acs
Open Space on top of Landfill Cap	26%	21.71 acs
Open Space on top of Podium	3%	2.68 acs
Impervious Area	60%	50.62 acs
Building and Garage Footprints	33%	27.53 acs
Plazas and Sidewalks	10%	8.79 acs
Streets	17%	14.31 acs

#### **Proposed Development**

Proposed Number of Buildings	16
Proposed Garages	3
Maximum Building Height from Existing Grade	100 Ft
Number of Stories	4 - 7 Stories
Proposed Land Use	R&D Office, R&D Lab, Hotel, Amenities
Proposed Building Area SF	3,398,400 SF
R&D Office SF	1,620,600 SF
R&D Lab SF	1,620,600 SF
Hotel SF	75,000 SF
Amenity Center SF	82,200 SF
Proposed Density FAR	0.98
Proposed SF per Employee	
R&D Office	350 SF/Employee
R&D Lab	625 SF/Employee
Total Number of Employees	7,574 Employees

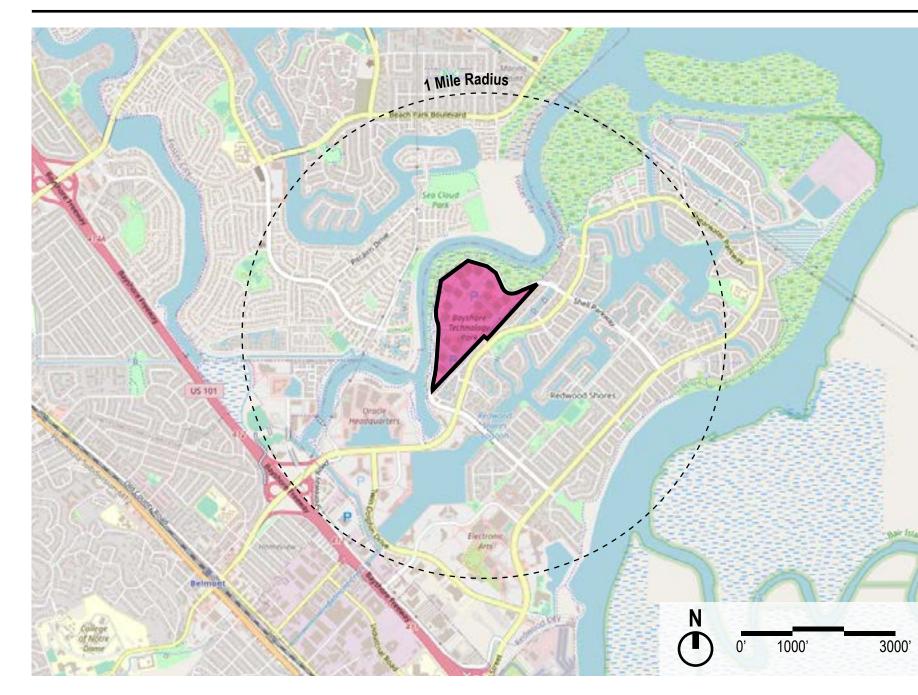
#### Parking

Required Spaces	Proposed Spaces
6,482	4,164
2,701	2,701
150	150
451	173
9,784	7,188
	6,482 2,701 150 451

Parking Types	Required Spaces	<b>Proposed Spaces</b>
Vehicular Space Types	9,784	7,188
Standard Spaces	5,064	2,416
EV Parking	3,604	3,604
Level 2 EVCs equipped spaces	846	846
Level 1 EV Ready Spaces	813	813
At Least EV Capable	1,945	1,945
Carpool and/or Vanpool Parking	978	978
ADA Parking	138	138
ADA Car Parking	118	118
ADA Van Parking	20	20
Visitor Parking (Space count over City / Green Building Code requirements)	-	52
Motorcycle Parking Spaces	489	489

Bike Parking		
City Required	680	(
Short-Term	min 3	
Long-Term	min 487	(

#### Site Plan





**BAYSHORE TECH PARK Project Address** 

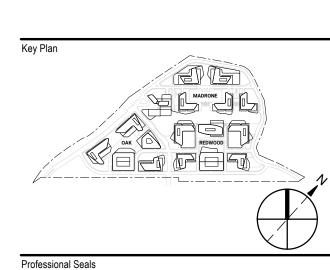
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#### **Sheet List**

SHEET NUMBER	SHEET NAME
GENERAL	
G0.00	COVER
G1.01	SHEET INDEX, PROJECT INFORMATION, AREA CALCULATIONS
G1.02	EXISTING CONDITIONS + SITE PHOTOS
G1.03	PROPOSED SITE PLAN
G1.04	PROPOSED PARCEL PLAN
G1.05	PROPOSED SITE PLAN - BASEMENT LEVEL
G1.06	PROPOSED SITE PLAN - LEVEL 1
G1.07	PROPOSED SITE PLAN - TYPICAL LEVEL
CIVIL	
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ARCHITECTURE	
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A2.01	OVERALL MATERIAL PALETTE
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A2.06	EXTERIOR ELEVATIONS - BUILDING N3 - NORTH & WEST
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A2.08	EXTERIOR ELEVATIONS - BUILDING N9 - NORTH & WEST
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3D ILLUSTRATIONS	
A9.01	VIEW 1 - WATERFRONT SW
A9.02	VIEW 2 - WATERFRONT SE
A9.03	VIEW 3 - GATEWAY
A9.04	VIEW 4 - THE COMMONS

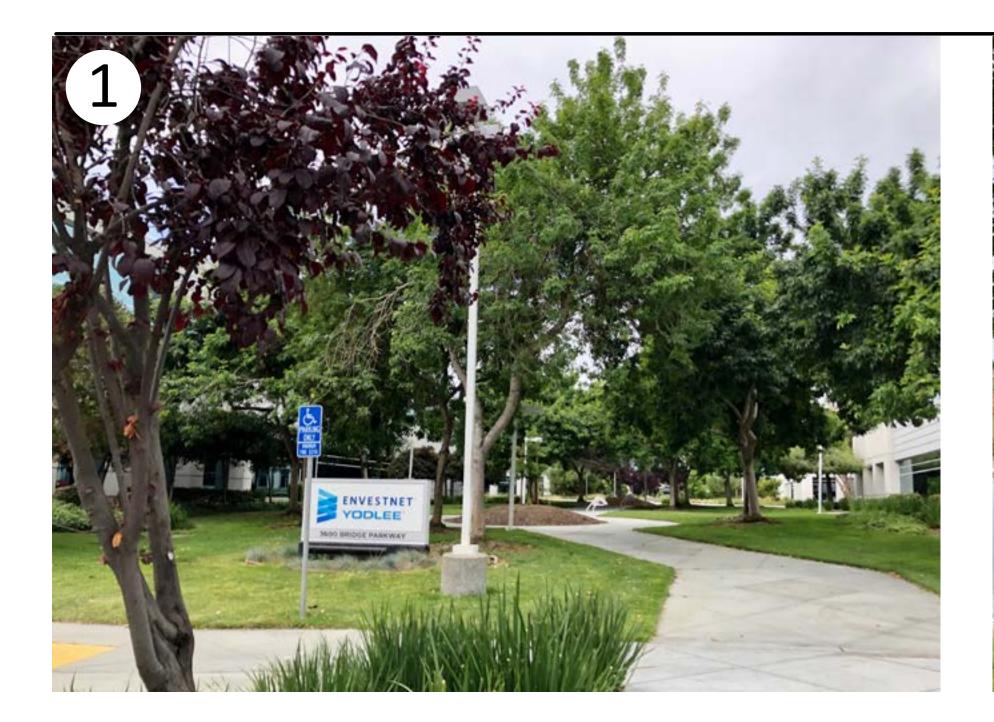


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No.	Description	D
Α	PRE-APP SUBMITTAL	2021-04
Project No:	20.04009.00	

SHEET INDEX, PROJECT INFORMATION, AREA **CALCULATIONS** 

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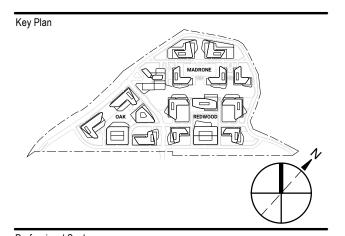


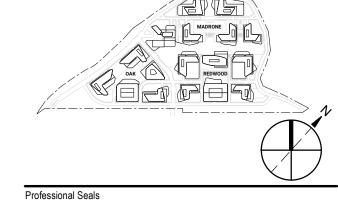
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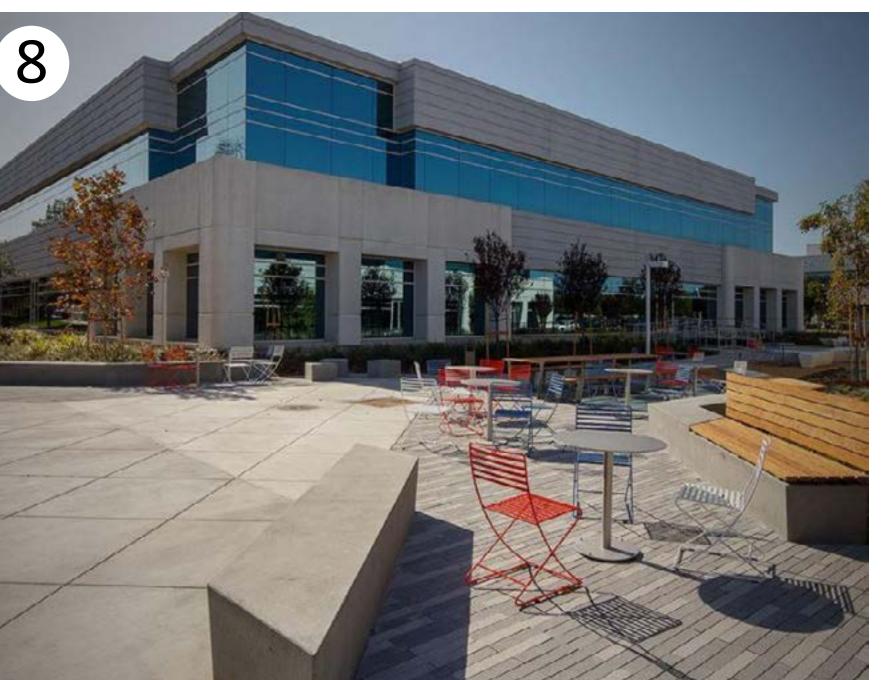


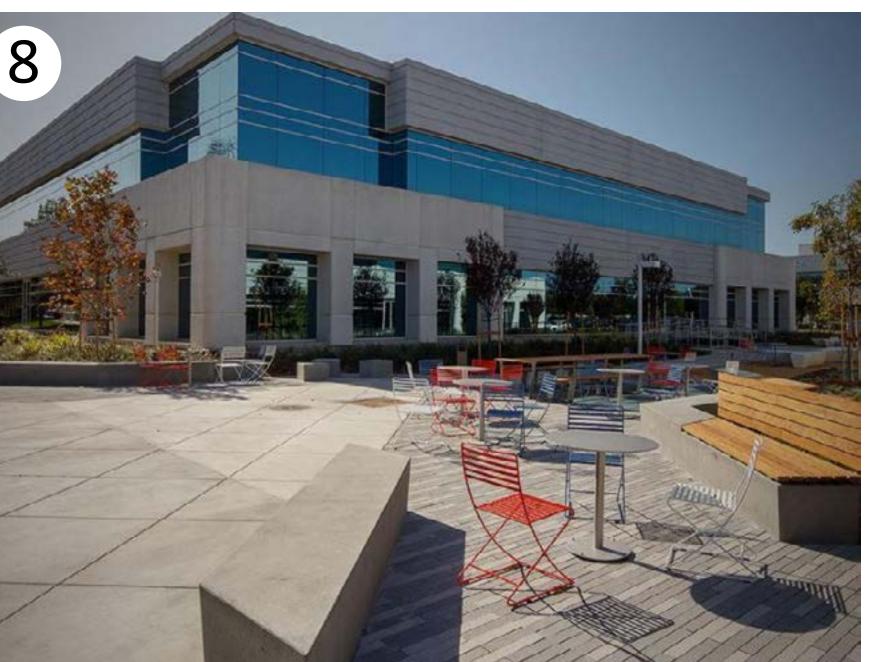
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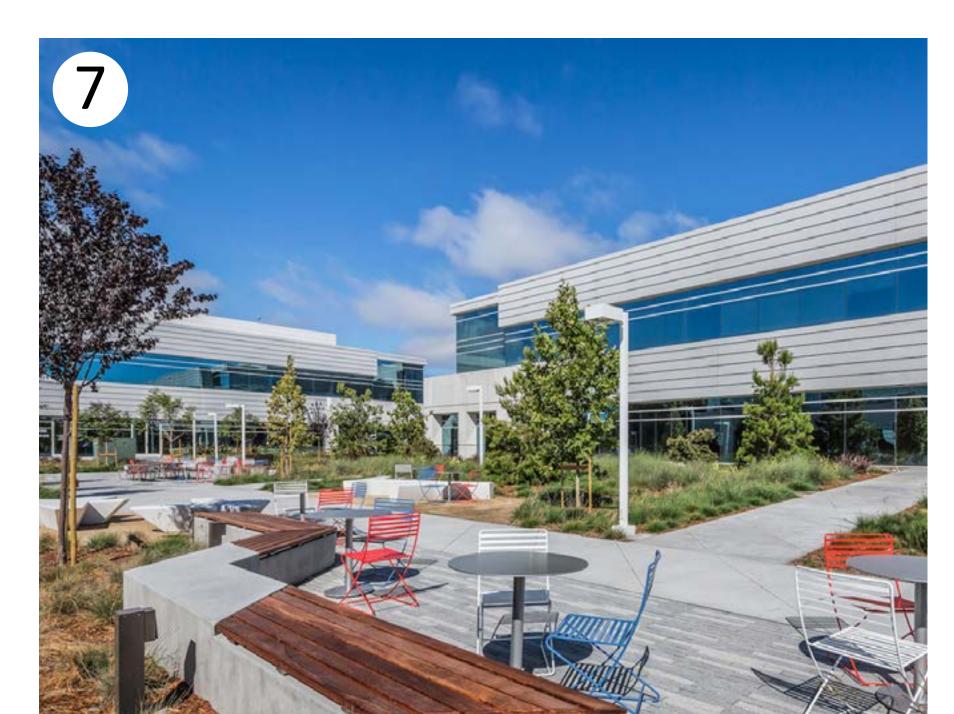
Description	Date
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EXISTING CONDITIONS + SITE PHOTOS













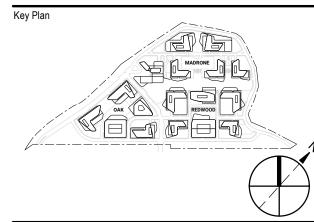


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PROPOSED SITE PLAN

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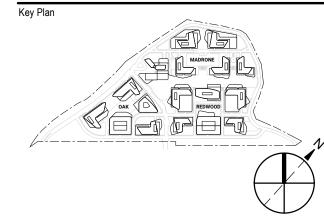


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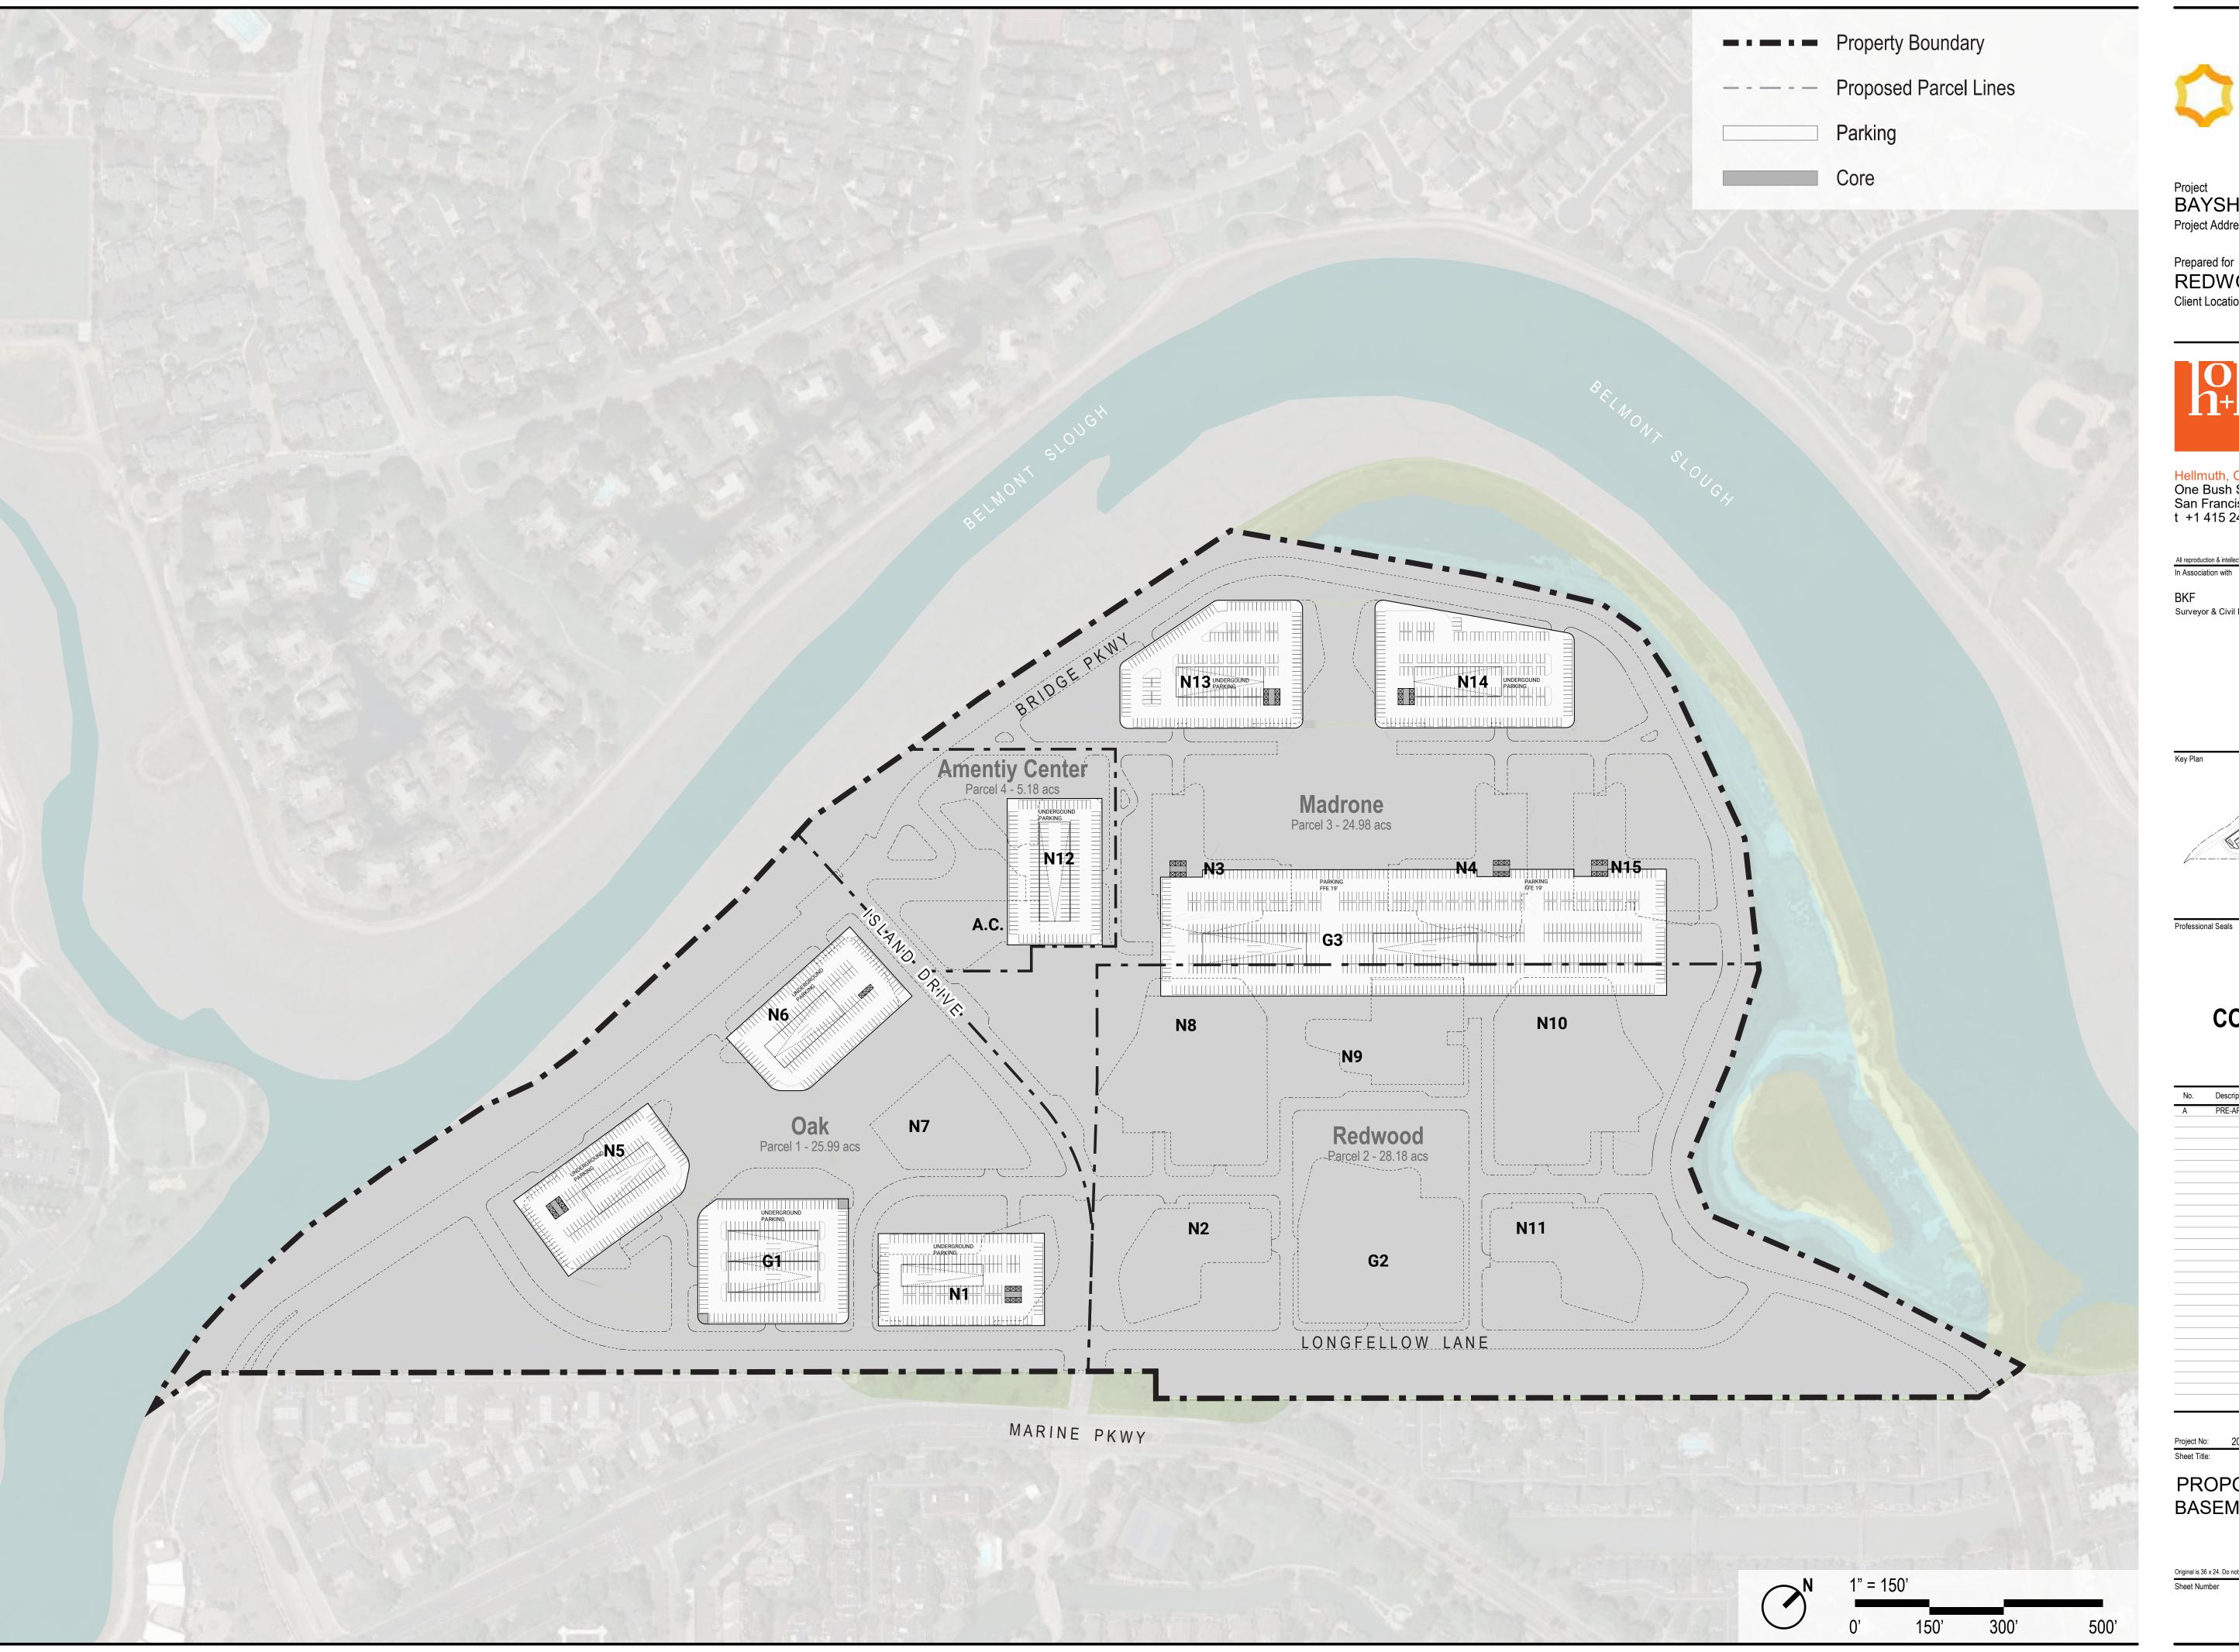
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No.	Description	Date
Α	PRE-APP SUBMITTAL	2021-04-22

PROPOSED PARCEL PLAN

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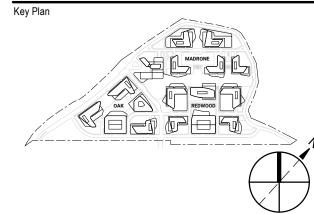


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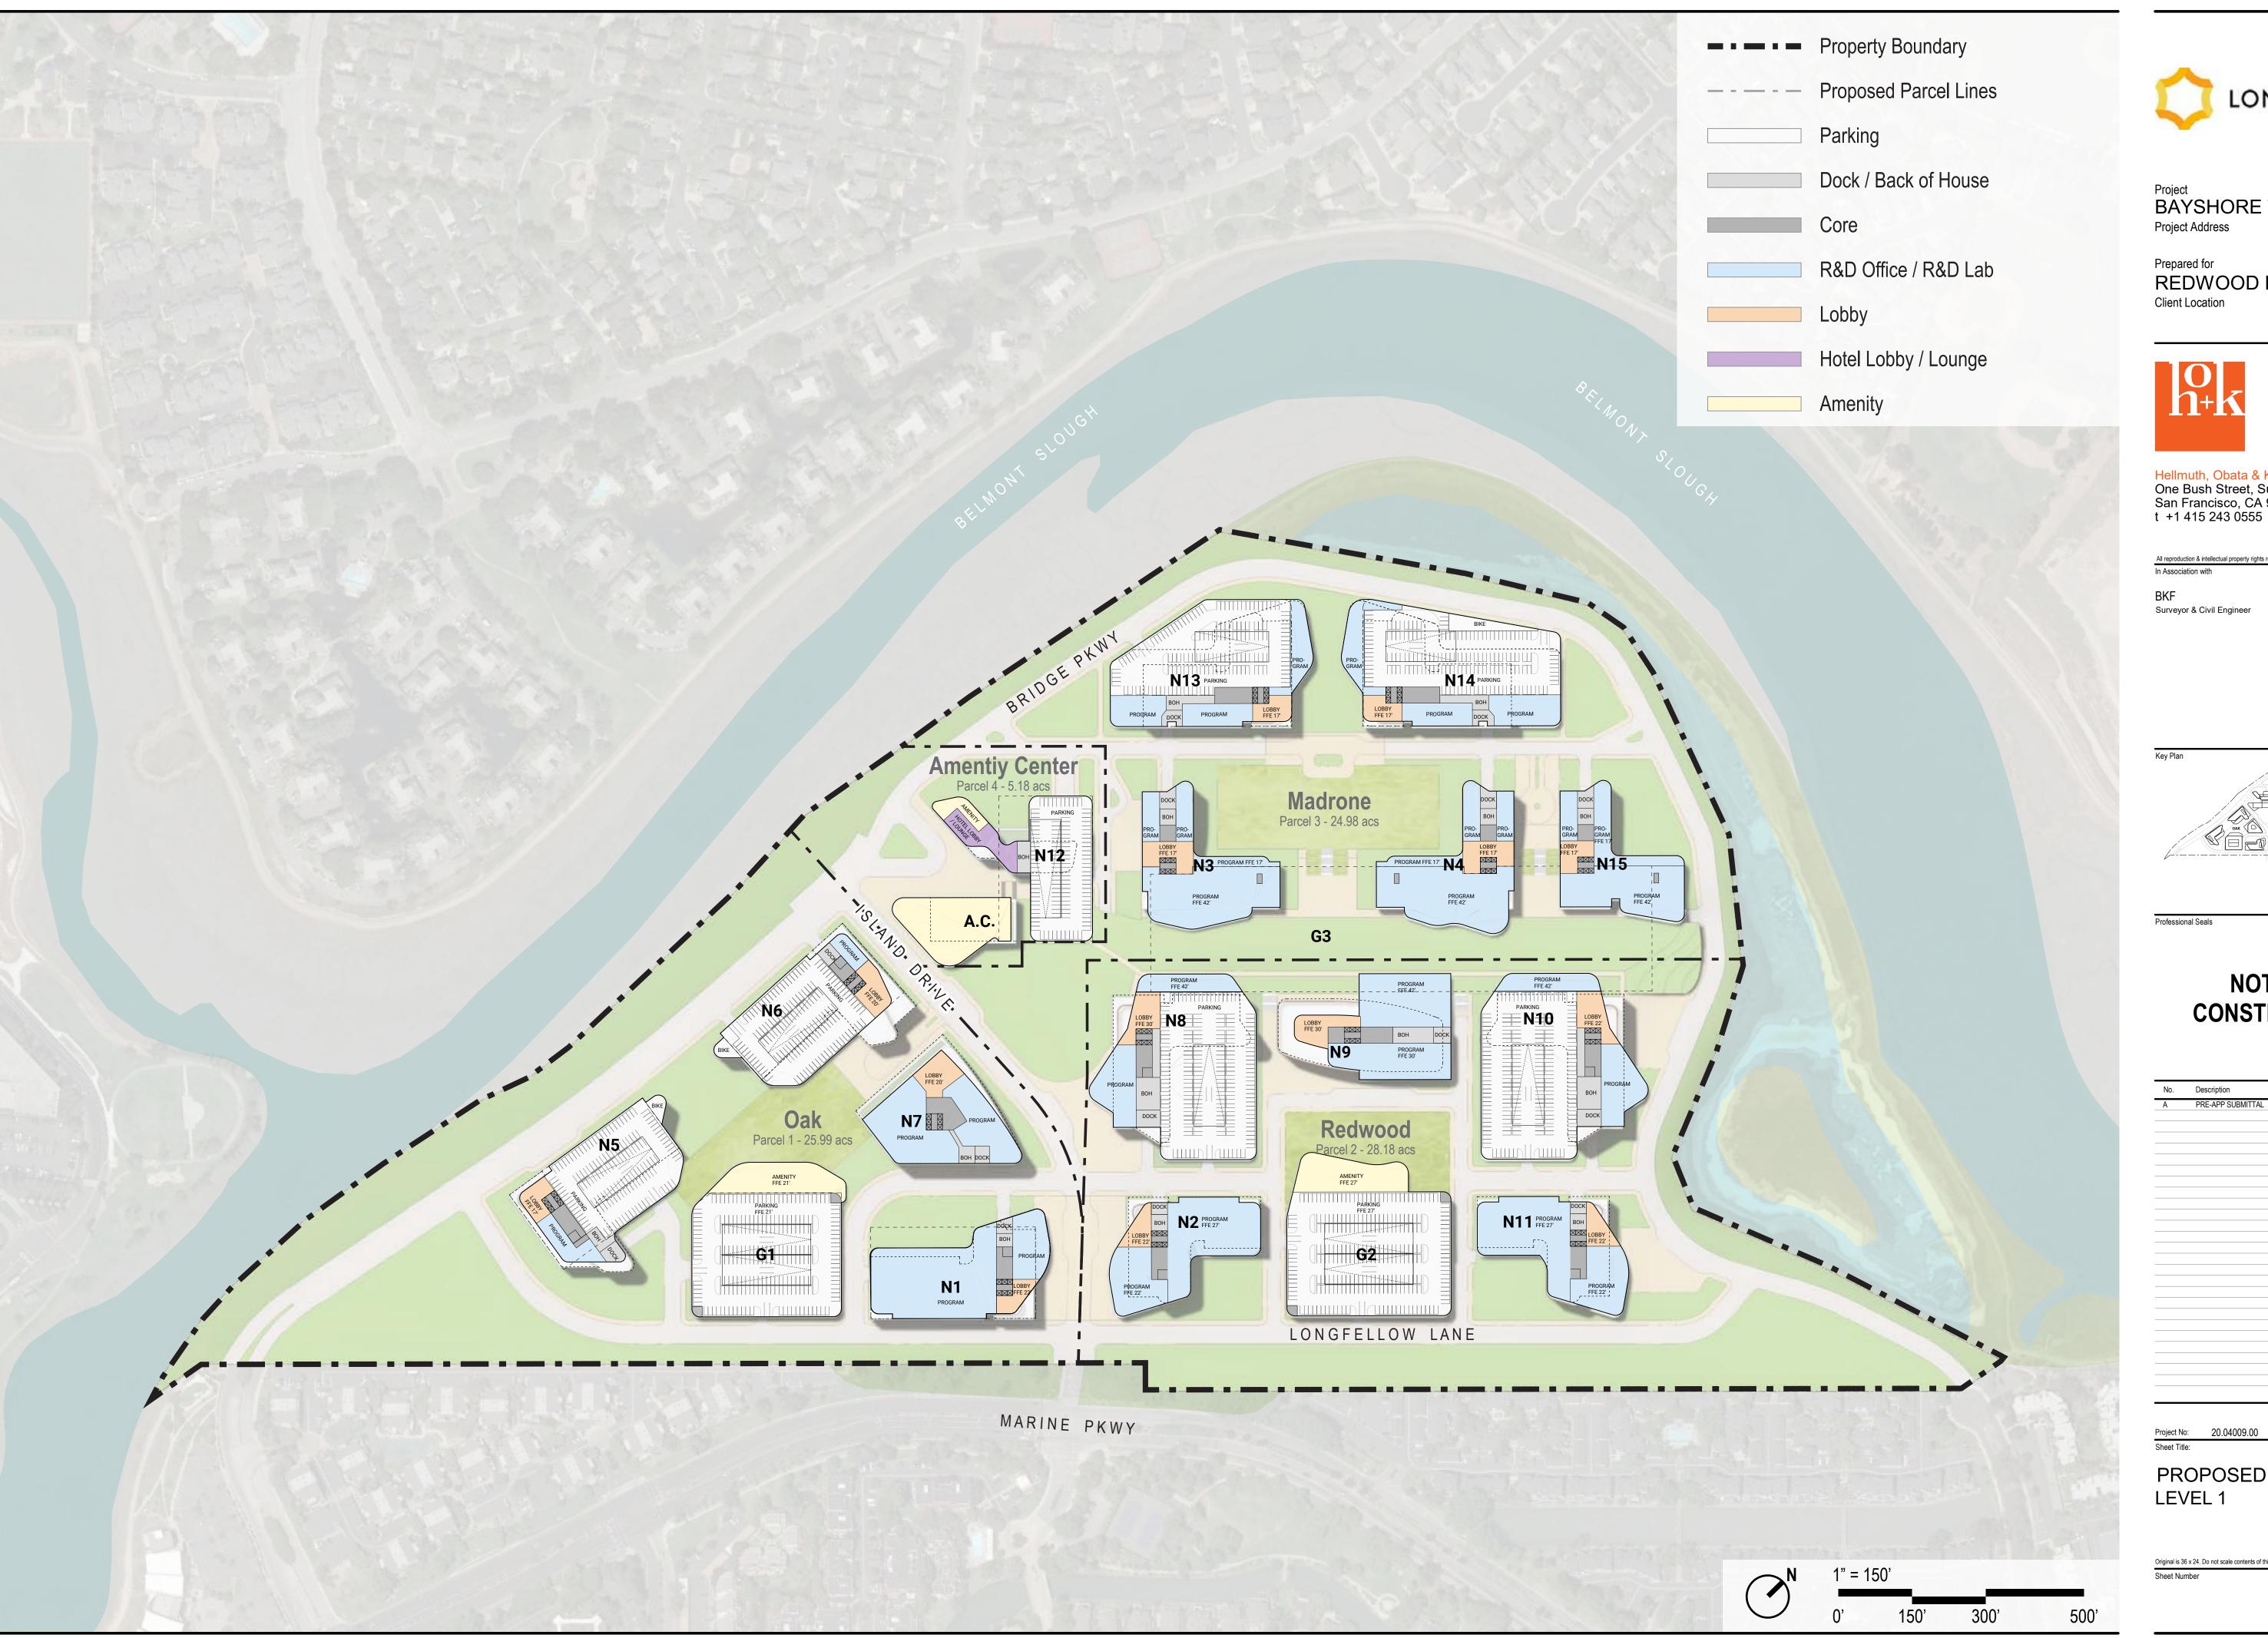
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PROPOSED SITE PLAN BASEMENT LEVEL

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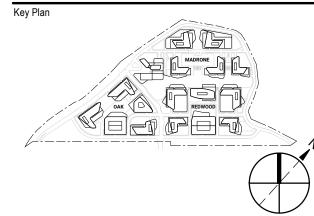


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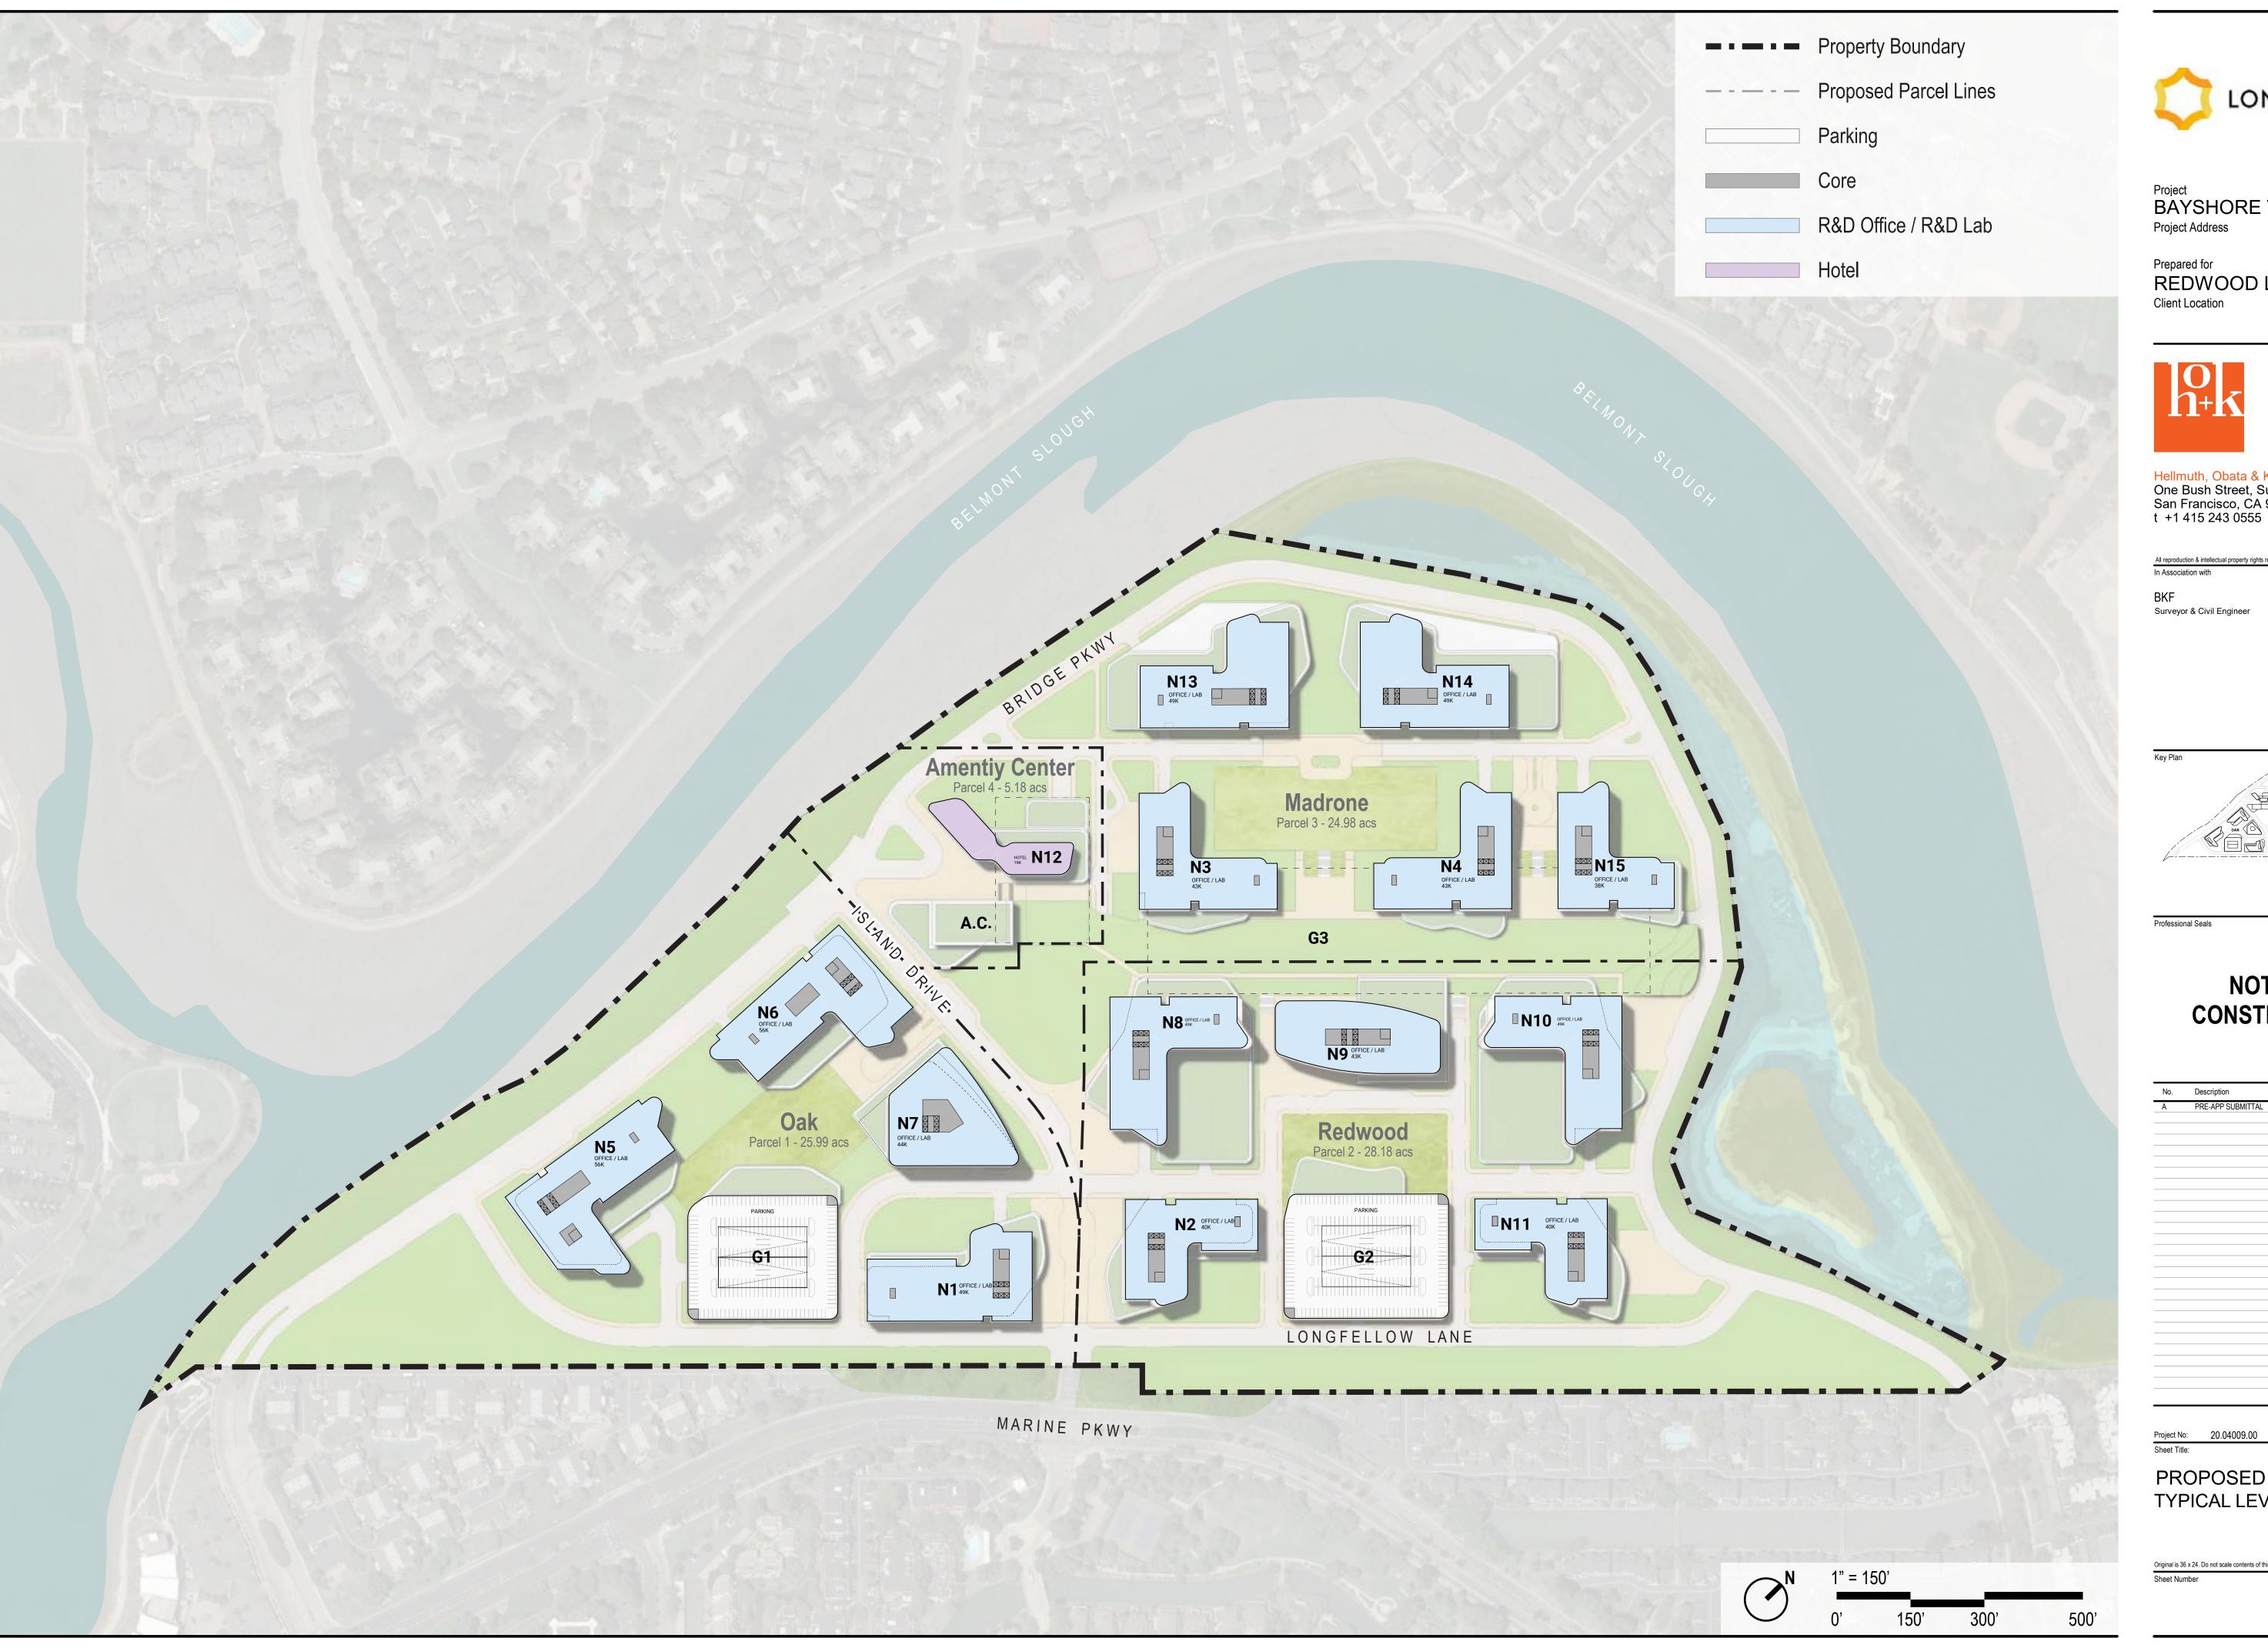
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PROPOSED SITE PLAN LEVEL 1

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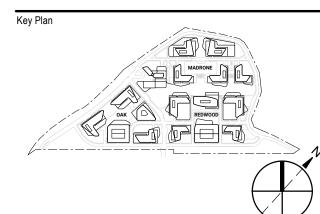


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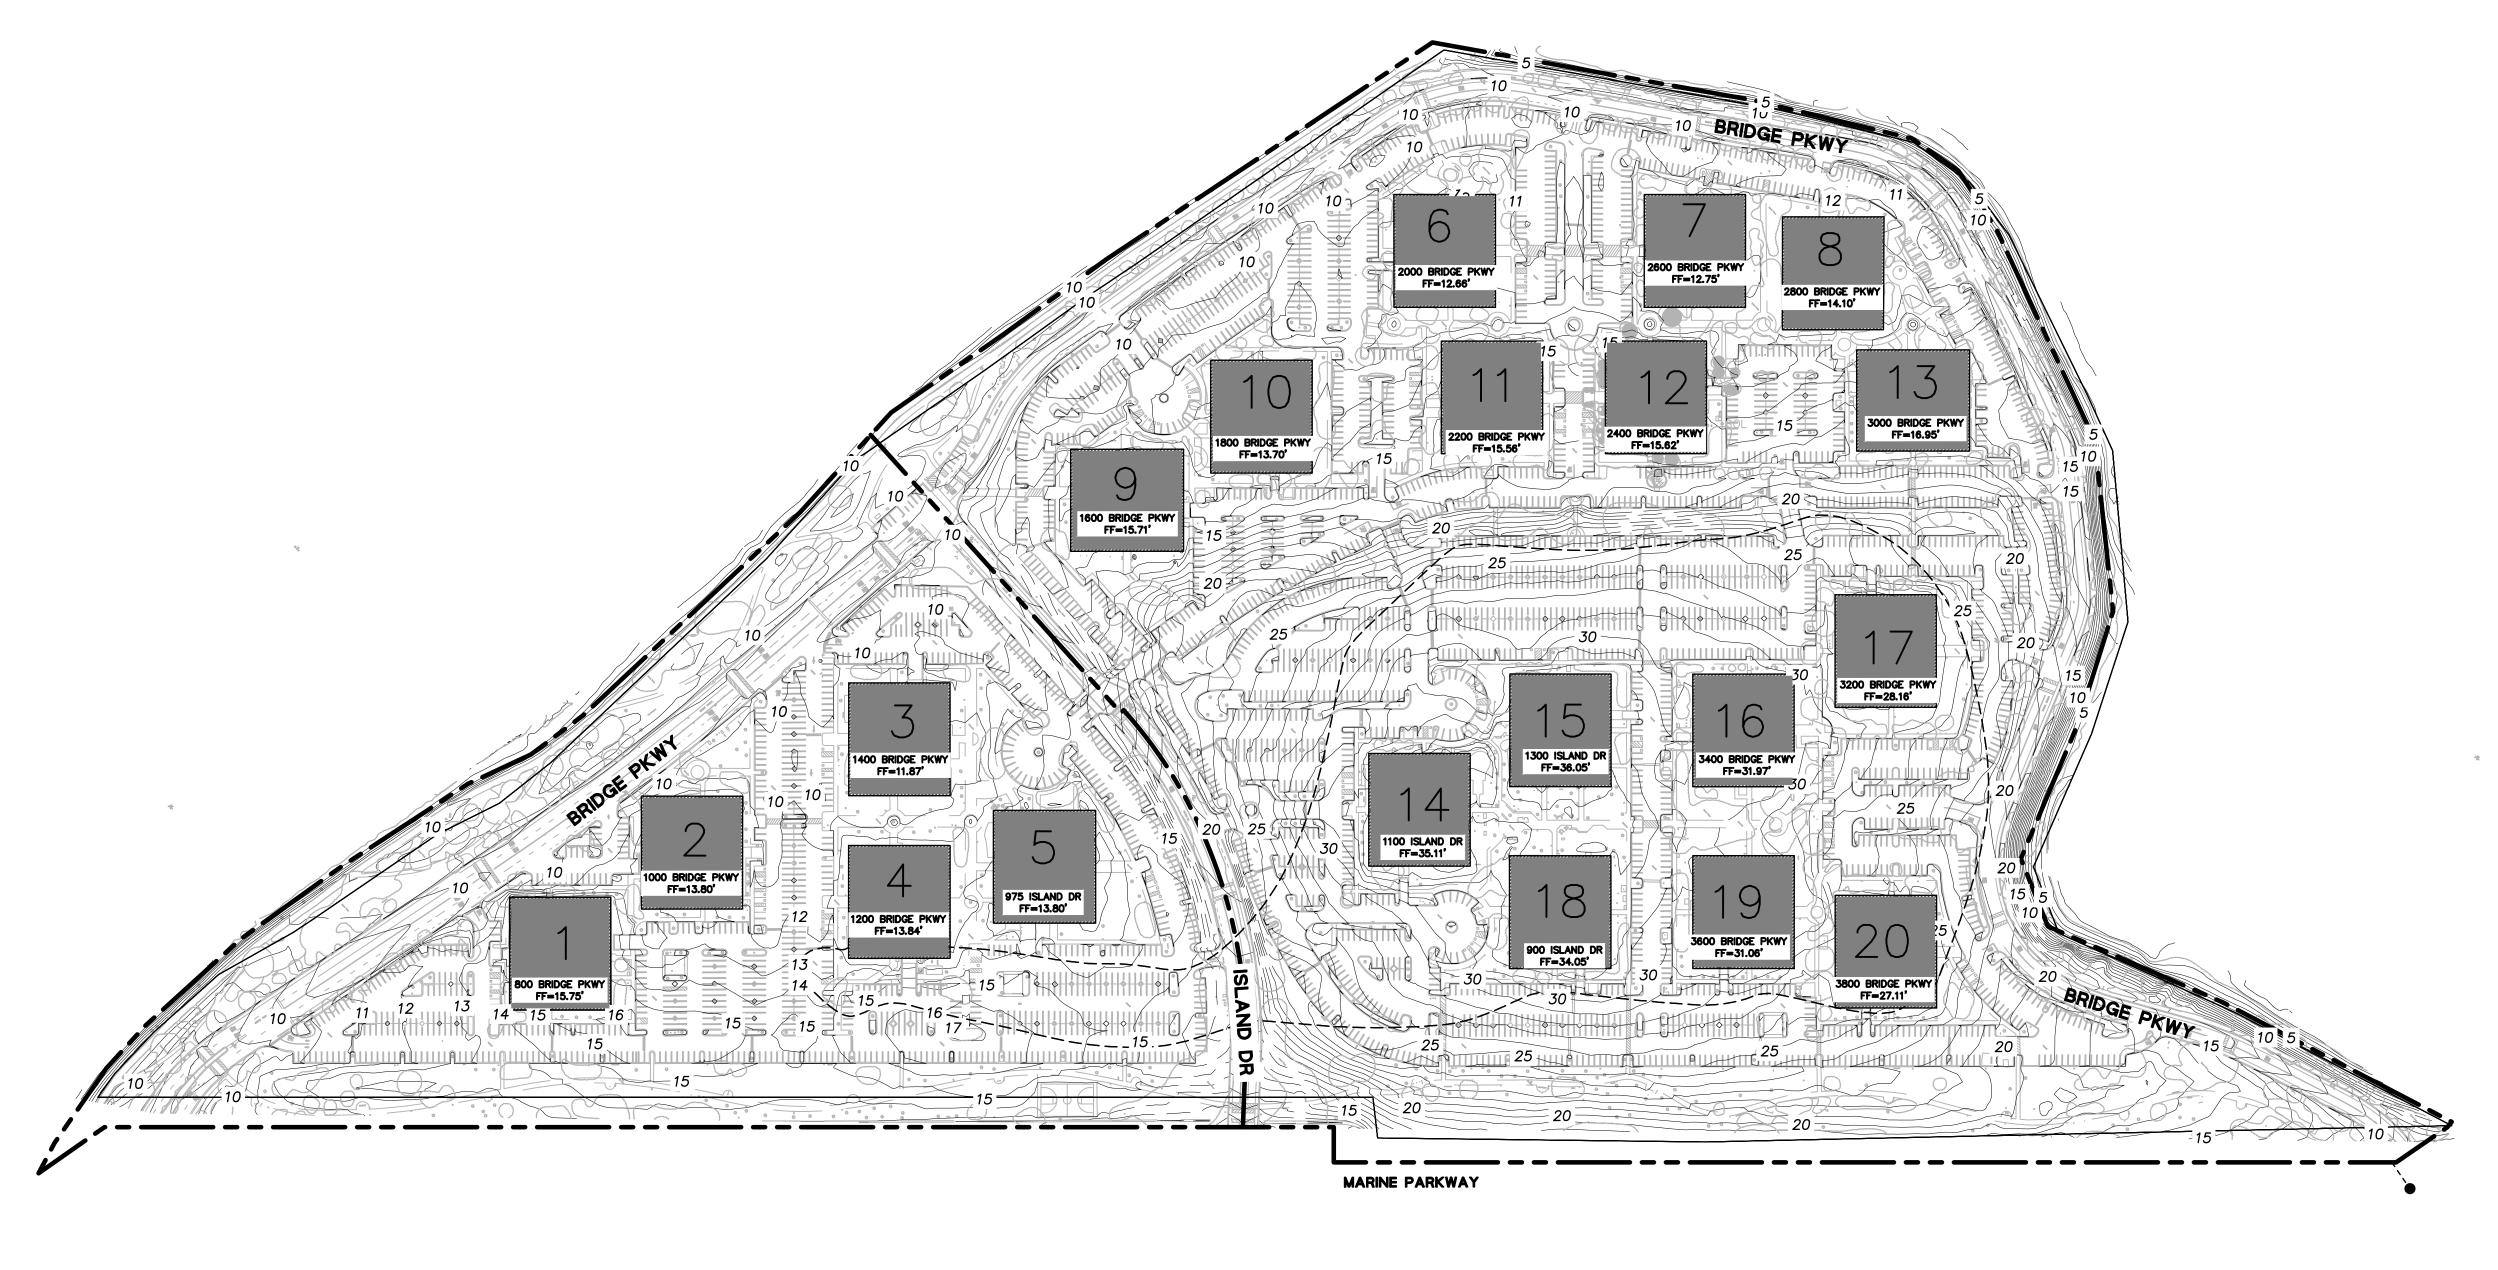
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PROPOSED SITE PLAN TYPICAL LEVEL

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### **NOTES:**

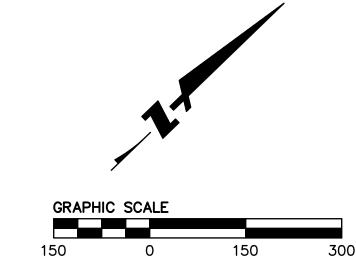
- 1. EXISTING BOUNDARY AND EASEMENT INFORMATION IS BASED ON A REVIEW OF AVAILABLE RECORD MAPS AND TITLE REPORTS FOR THE PROJECT AREA.
- 2. EXISTING TOPOGRAPHIC INFORMATION SHOWN ON THESE PLANS IS BASED ON AN AERIAL SURVEY PERFORMED BY TETRA TECH GEOMATIC TECHNOLOGIES ON SEPTEMBER 27, 2016.
- THE CALCULATED BEARING OF NORTH 48°54'10" EAST BETWEEN TWO FOUND MONUMENTS ALONG MONUMENT LINE OF MARINE PARKWAY, AS SHOWN ON THAT PARCEL MAP FILED FOR RECORD ON JULY 22, 1976 IN BOOK 100 OF PARCEL MAPS AT PAGE 33, SAN MATEO COUNTY RECORDS, WAS USED AS THE BASIS OF ALL BEARINGS SHOWN ON THIS MAP.
- 4. PROJECT BENCHMARK:

#### ELEVATION= FEET DATUM = NAVD88

5. EXISTING UTILITIES AND SITE CONDITIONS SHOWN ON THIS PLAN ARE BASED ON AVAILABLE RECORD INFORMATION AND FIELD SURVEYS. SHOULD FIELD CONDITIONS DIFFER FROM WHAT IS SHOWN ON THESE PLANS, CONTACT THE OWNER'S REPRESENTATIVE FOR DIRECTION AND CLARIFICATION PRIOR TO PROCEEDING WITH CONSTRUCTION ACTIVITIES.

### **LEGEND**.

PROPERTY LINE





Project
BAYSHORE TECH PARK Project Address

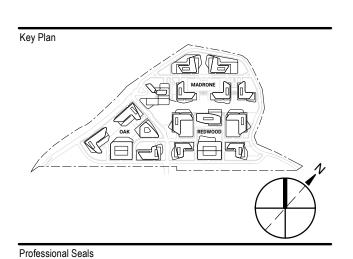
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TOPOGRAPHIC SURVEY

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#### <u>NOTES:</u>

- 1. EXISTING BOUNDARY AND EASEMENT INFORMATION IS BASED ON A REVIEW OF AVAILABLE RECORD MAPS AND TITLE REPORTS FOR THE PROJECT
- 2. EXISTING TOPOGRAPHIC INFORMATION SHOWN ON THESE PLANS IS BASED ON AN AERIAL SURVEY PERFORMED BY TETRA TECH GEOMATIC TECHNOLOGIES ON SEPTEMBER 27, 2016.
- 3. BASIS OF BEARING: THE CALCULATED BEARING OF NORTH 48°54'10" EAST BETWEEN TWO FOUND MONUMENTS ALONG MONUMENT LINE OF MARINE PARKWAY, AS SHOWN ON THAT PARCEL MAP FILED FOR RECORD ON JULY 22, 1976 IN BOOK 100 OF PARCEL MAPS AT PAGE 33, SAN MATEO COUNTY RECORDS, WAS USED AS THE BASIS OF ALL BEARINGS SHOWN ON THIS MAP.
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ELEVATION= FEET DATUM = NAVD88

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- 6. LEACHATE LIMIT, EXTENT OF REFUSE MATERIAL AND EXTENT OF LANDFILL CAP PROVIDED BY ROUX DATED AUGUST 21, 2020.

#### **LEGEND**:

EASEMENT APPROXIMATE EXTENT OF LANDFILL CAP APPROXIMATE LEACHATE LIMIT APPROXIMATE EXTENT OF REFUSE MATERIAL LIMIT

### HATCH LEGEND:

INGRESS, EGRESS, AND DRAINAGE EASEMENT (DN 2006-128077)

PUBLIC DRAINAGE AND WATERWAY EASEMENT (B5604 P117 & B5604 P128) PUBLIC ACCESS EASEMENT

(B7860 P1947, B7859 P2166, B7859 P2190) PUBLIC SERVICE EASEMENT FOR WATER UTILITIES (DN 99-090684)

> PUBLIC SERVICE EASEMENT FOR SEWER AND WATER UTILITIES (DN 98-203792)

WATER, SEWER, & RECYCLED WATER EASEMENT (DN 2008-079970)



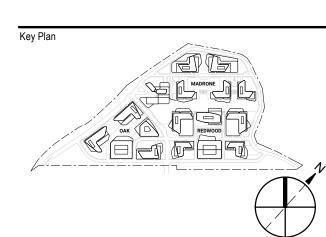
Project
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**EXISTING EASEMENTS** 

C1.02

LONGFELLOW

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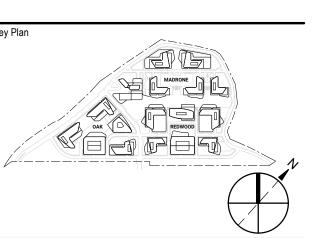
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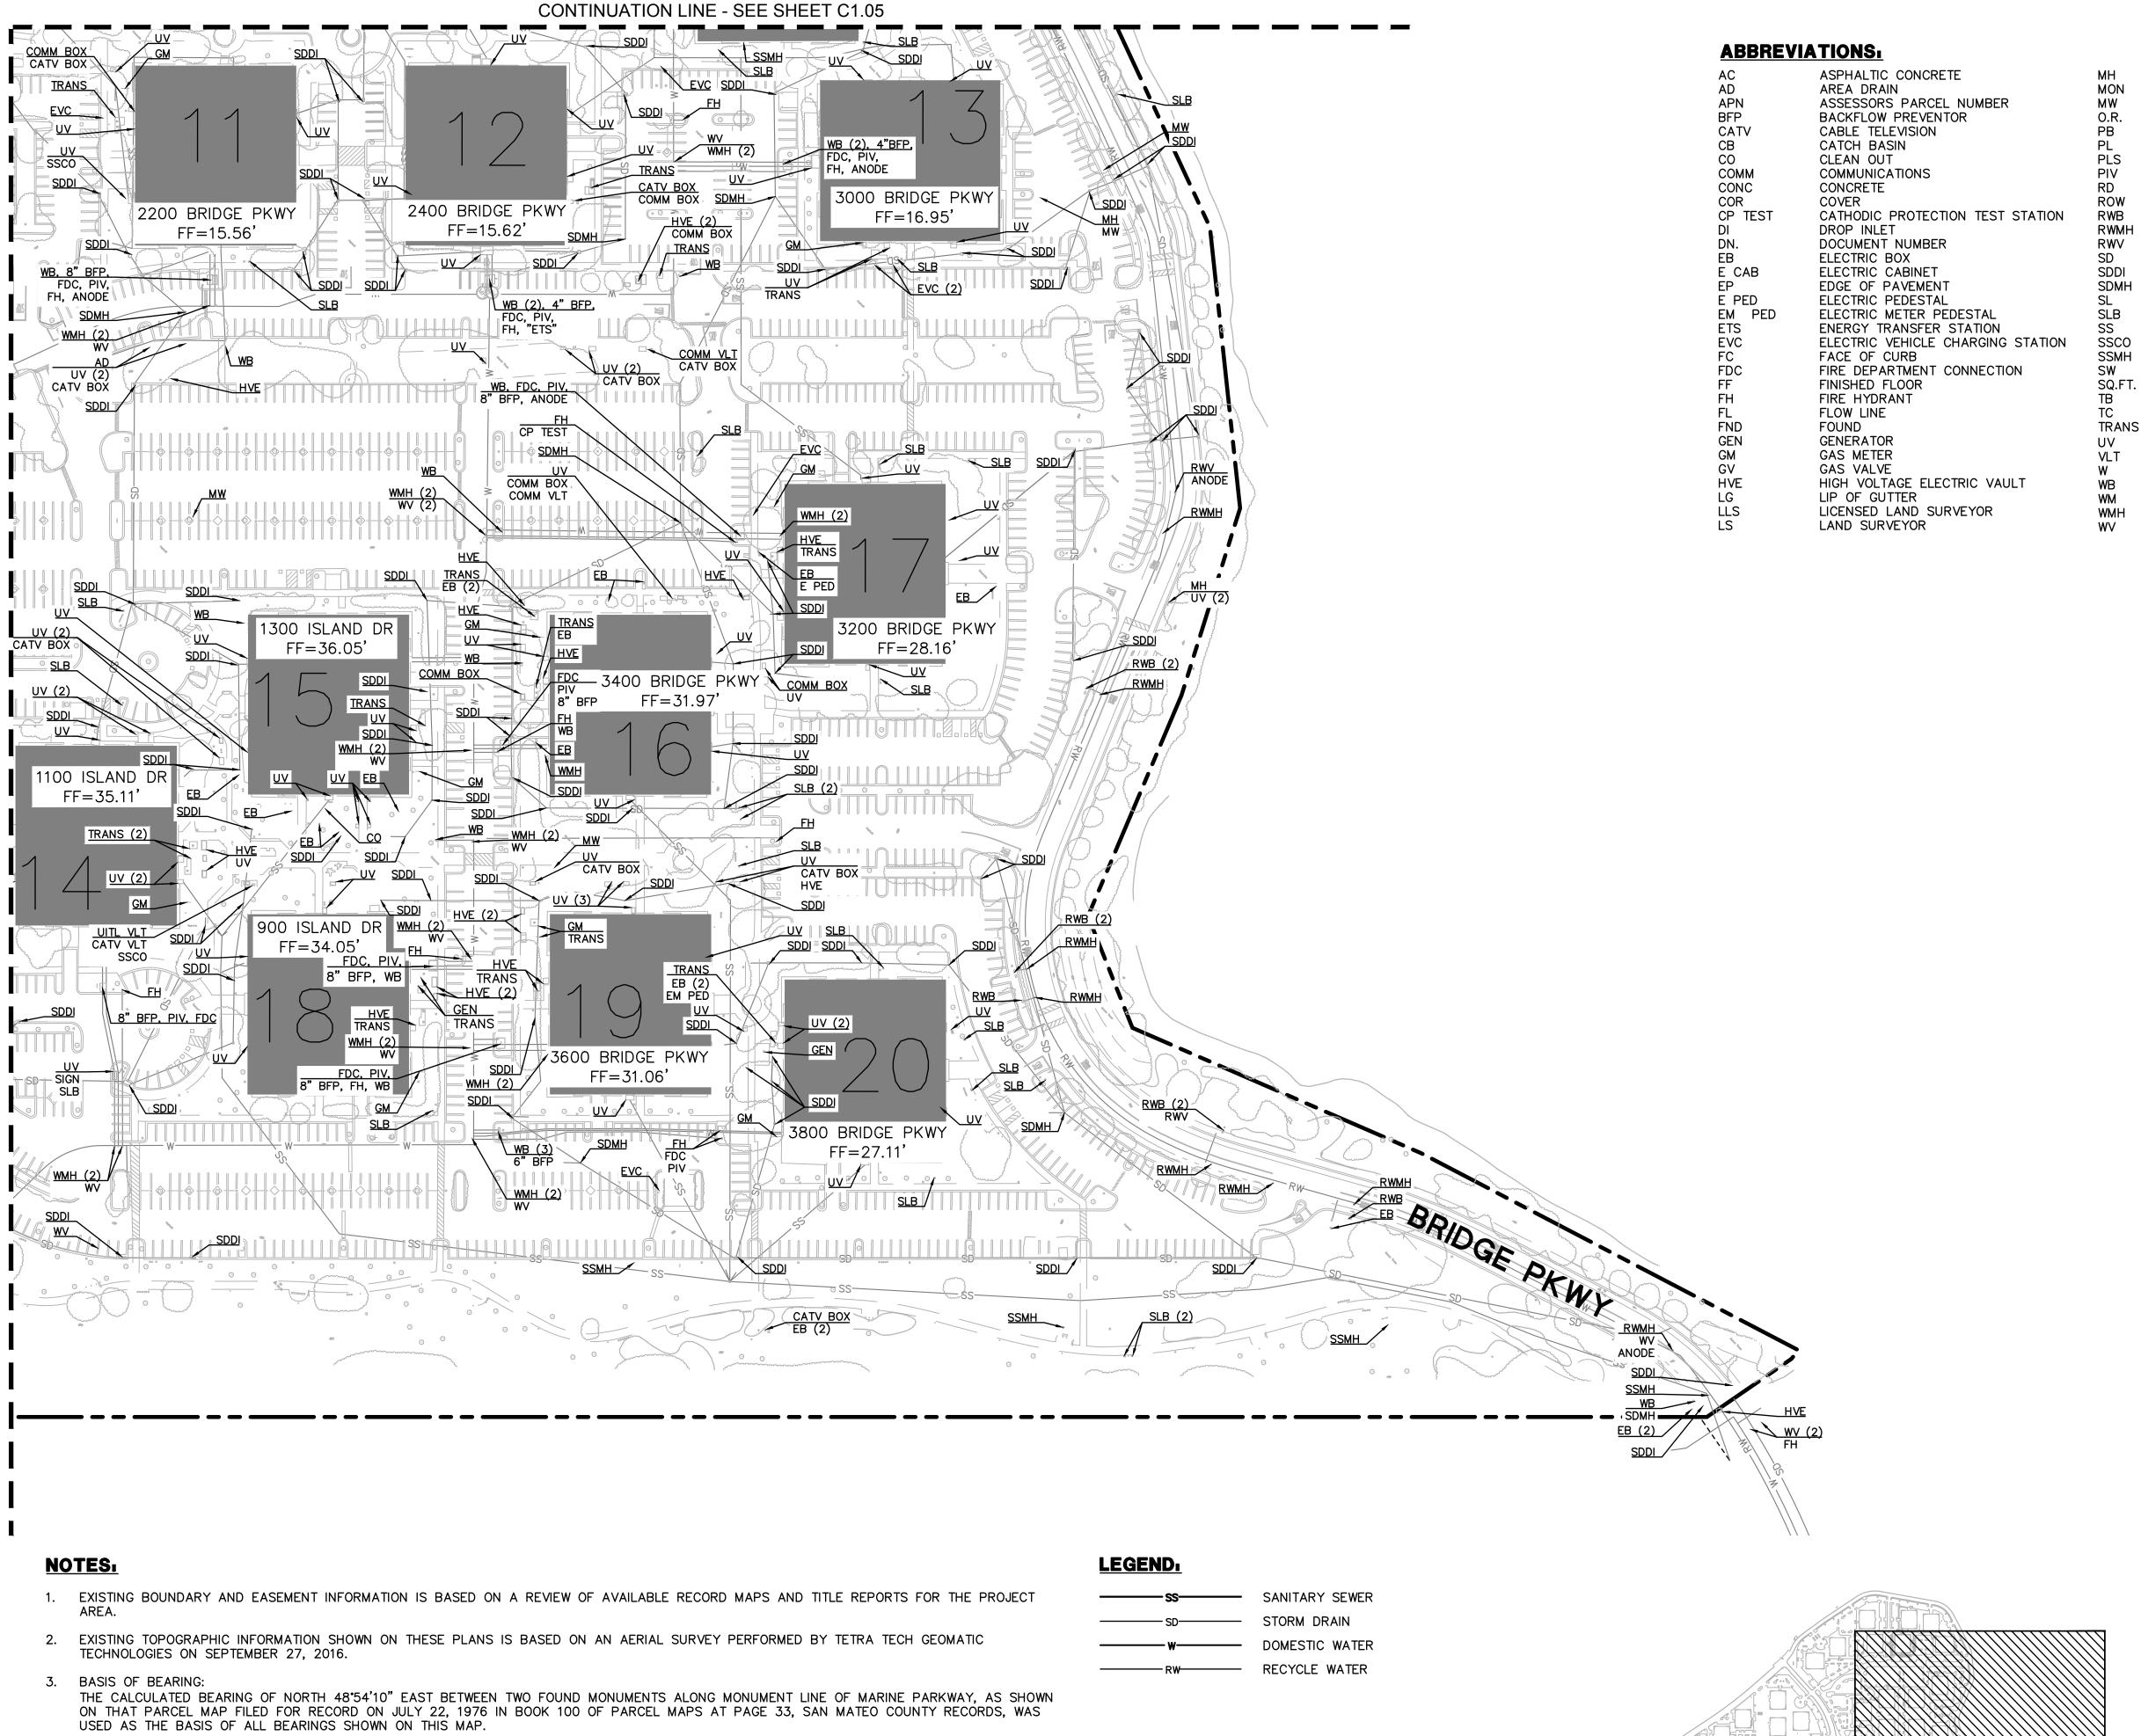
**EXISTING/DEMOLITION** PLAN - PARCEL 1

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C1.03

5. EXISTING UTILITIES AND SITE CONDITIONS SHOWN ON THIS PLAN ARE BASED ON AVAILABLE RECORD INFORMATION AND FIELD SURVEYS. SHOULD FIELD CONDITIONS DIFFER FROM WHAT IS SHOWN ON THESE PLANS, CONTACT THE OWNER'S REPRESENTATIVE FOR DIRECTION AND CLARIFICATION

PRIOR TO PROCEEDING WITH CONSTRUCTION ACTIVITIES.





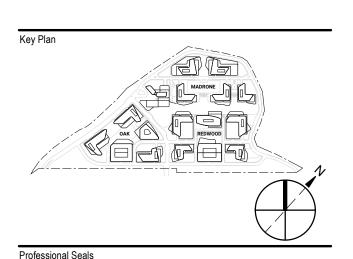
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EXISTING/DEMOLITION PLAN - PARCEL 2

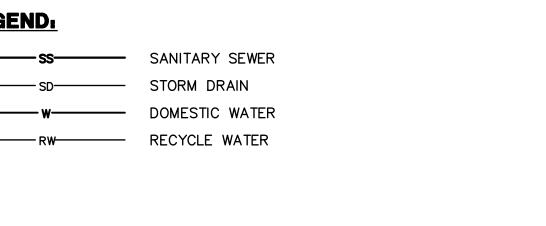
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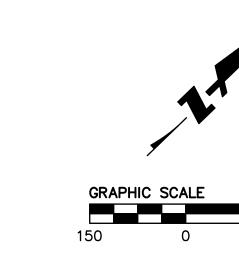
C1.04

4. PROJECT BENCHMARK:

ELEVATION= FEET DATUM = NAVD88

5. EXISTING UTILITIES AND SITE CONDITIONS SHOWN ON THIS PLAN ARE BASED ON AVAILABLE RECORD INFORMATION AND FIELD SURVEYS. SHOULD FIELD CONDITIONS DIFFER FROM WHAT IS SHOWN ON THESE PLANS, CONTACT THE OWNER'S REPRESENTATIVE FOR DIRECTION AND CLARIFICATION PRIOR TO PROCEEDING WITH CONSTRUCTION ACTIVITIES.





KEY MAP

MANHOLE

MONUMENT

PULL BOX

MONITORING WELL

OFFICIAL RECORDS

POST INDICATOR VALVE

RECLAIMED WATER BOX

RECLAIMED WATER MANHOLE

RECLAIMED WATER VALVE

STORM DRAIN DROP INLET

SANITARY SEWER CLEANOUT

SANITARY SEWER MANHOLE

UTILITY VAULT (UNKNOWN)

STORM DRAIN MANHOLE

PROFESSIONAL LAND SURVEYOR

PROPERTY LINE

RIGHT OF WAY

STORM DRAIN

STREET LIGHT

SIDEWALK

SQUARE FOOT

TELEPHONE BOX

TOP OF CURB

TRANSFORMER

WATER BOX

WATER METER

WATER MANHOLE

WATER VALVE

VAULT

WATER

STREET LIGHT BOX

SANITARY SEWER

## LONGFELLOW

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**EXISTING/DEMOLITION** PLAN - PARCEL 3

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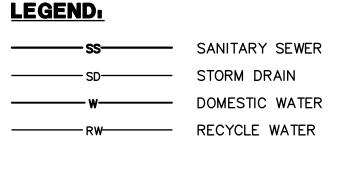
C1.05

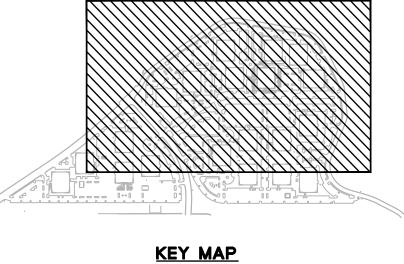
#### <u>NOTES:</u>

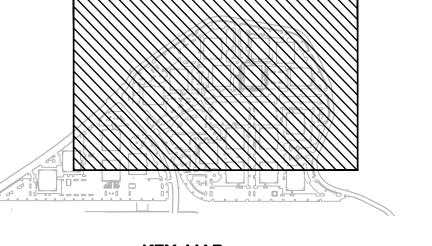
- 1. EXISTING BOUNDARY AND EASEMENT INFORMATION IS BASED ON A REVIEW OF AVAILABLE RECORD MAPS AND TITLE REPORTS FOR THE PROJECT
- 2. EXISTING TOPOGRAPHIC INFORMATION SHOWN ON THESE PLANS IS BASED ON AN AERIAL SURVEY PERFORMED BY TETRA TECH GEOMATIC
- TECHNOLOGIES ON SEPTEMBER 27, 2016. 3. BASIS OF BEARING:
- THE CALCULATED BEARING OF NORTH 48°54'10" EAST BETWEEN TWO FOUND MONUMENTS ALONG MONUMENT LINE OF MARINE PARKWAY, AS SHOWN ON THAT PARCEL MAP FILED FOR RECORD ON JULY 22, 1976 IN BOOK 100 OF PARCEL MAPS AT PAGE 33, SAN MATEO COUNTY RECORDS, WAS USED AS THE BASIS OF ALL BEARINGS SHOWN ON THIS MAP.
- 4. PROJECT BENCHMARK:

ELEVATION= FEET DATUM = NAVD88

5. EXISTING UTILITIES AND SITE CONDITIONS SHOWN ON THIS PLAN ARE BASED ON AVAILABLE RECORD INFORMATION AND FIELD SURVEYS. SHOULD FIELD CONDITIONS DIFFER FROM WHAT IS SHOWN ON THESE PLANS, CONTACT THE OWNER'S REPRESENTATIVE FOR DIRECTION AND CLARIFICATION PRIOR TO PROCEEDING WITH CONSTRUCTION ACTIVITIES.











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PUBLIC DRAINAGE

AND WATERWAY EASEMENT

PUBLIC ACCESS EASEMENT

WATER, SEWER, AND RECYCLED WATER EASEMENT

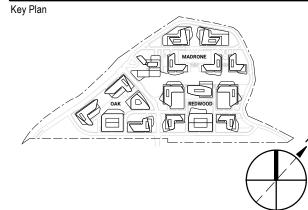
GRAPHIC SCALE



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### NOT FOR **CONSTRUCTION**

PRE-APP SUBMITTAL	2021-04-22

Project No: 20.04009.00

STORM WATER MANAGEMENT PLAN

Original is 36 x 24. Do not scale contents of this drawing Sheet Number

C2.00

2. EXISTING TOPOGRAPHIC INFORMATION SHOWN ON THESE PLANS IS BASED ON

THE BASIS OF ALL BEARINGS SHOWN ON THIS MAP.

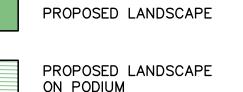
4. PROJECT BENCHMARK:

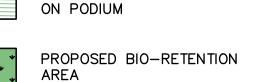
ELEVATION= FEET DATUM = NAVD88

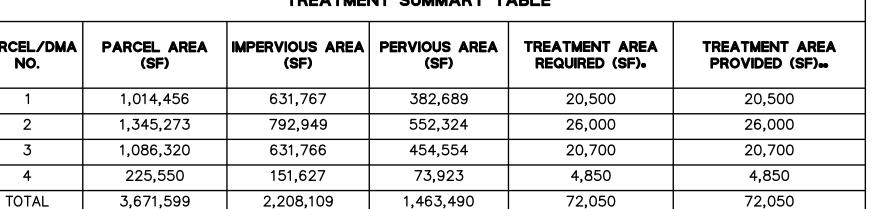
5. EXISTING UTILITIES AND SITE CONDITIONS SHOWN ON THIS PLAN ARE BASED ON AVAILABLE RECORD INFORMATION AND FIELD SURVEYS. SHOULD FIELD CONDITIONS DIFFER FROM WHAT IS SHOWN ON THESE PLANS, CONTACT THE OWNER'S REPRESENTATIVE FOR DIRECTION AND CLARIFICATION PRIOR TO PROCEEDING WITH CONSTRUCTION ACTIVITIES.

PROPOSED BUILDING

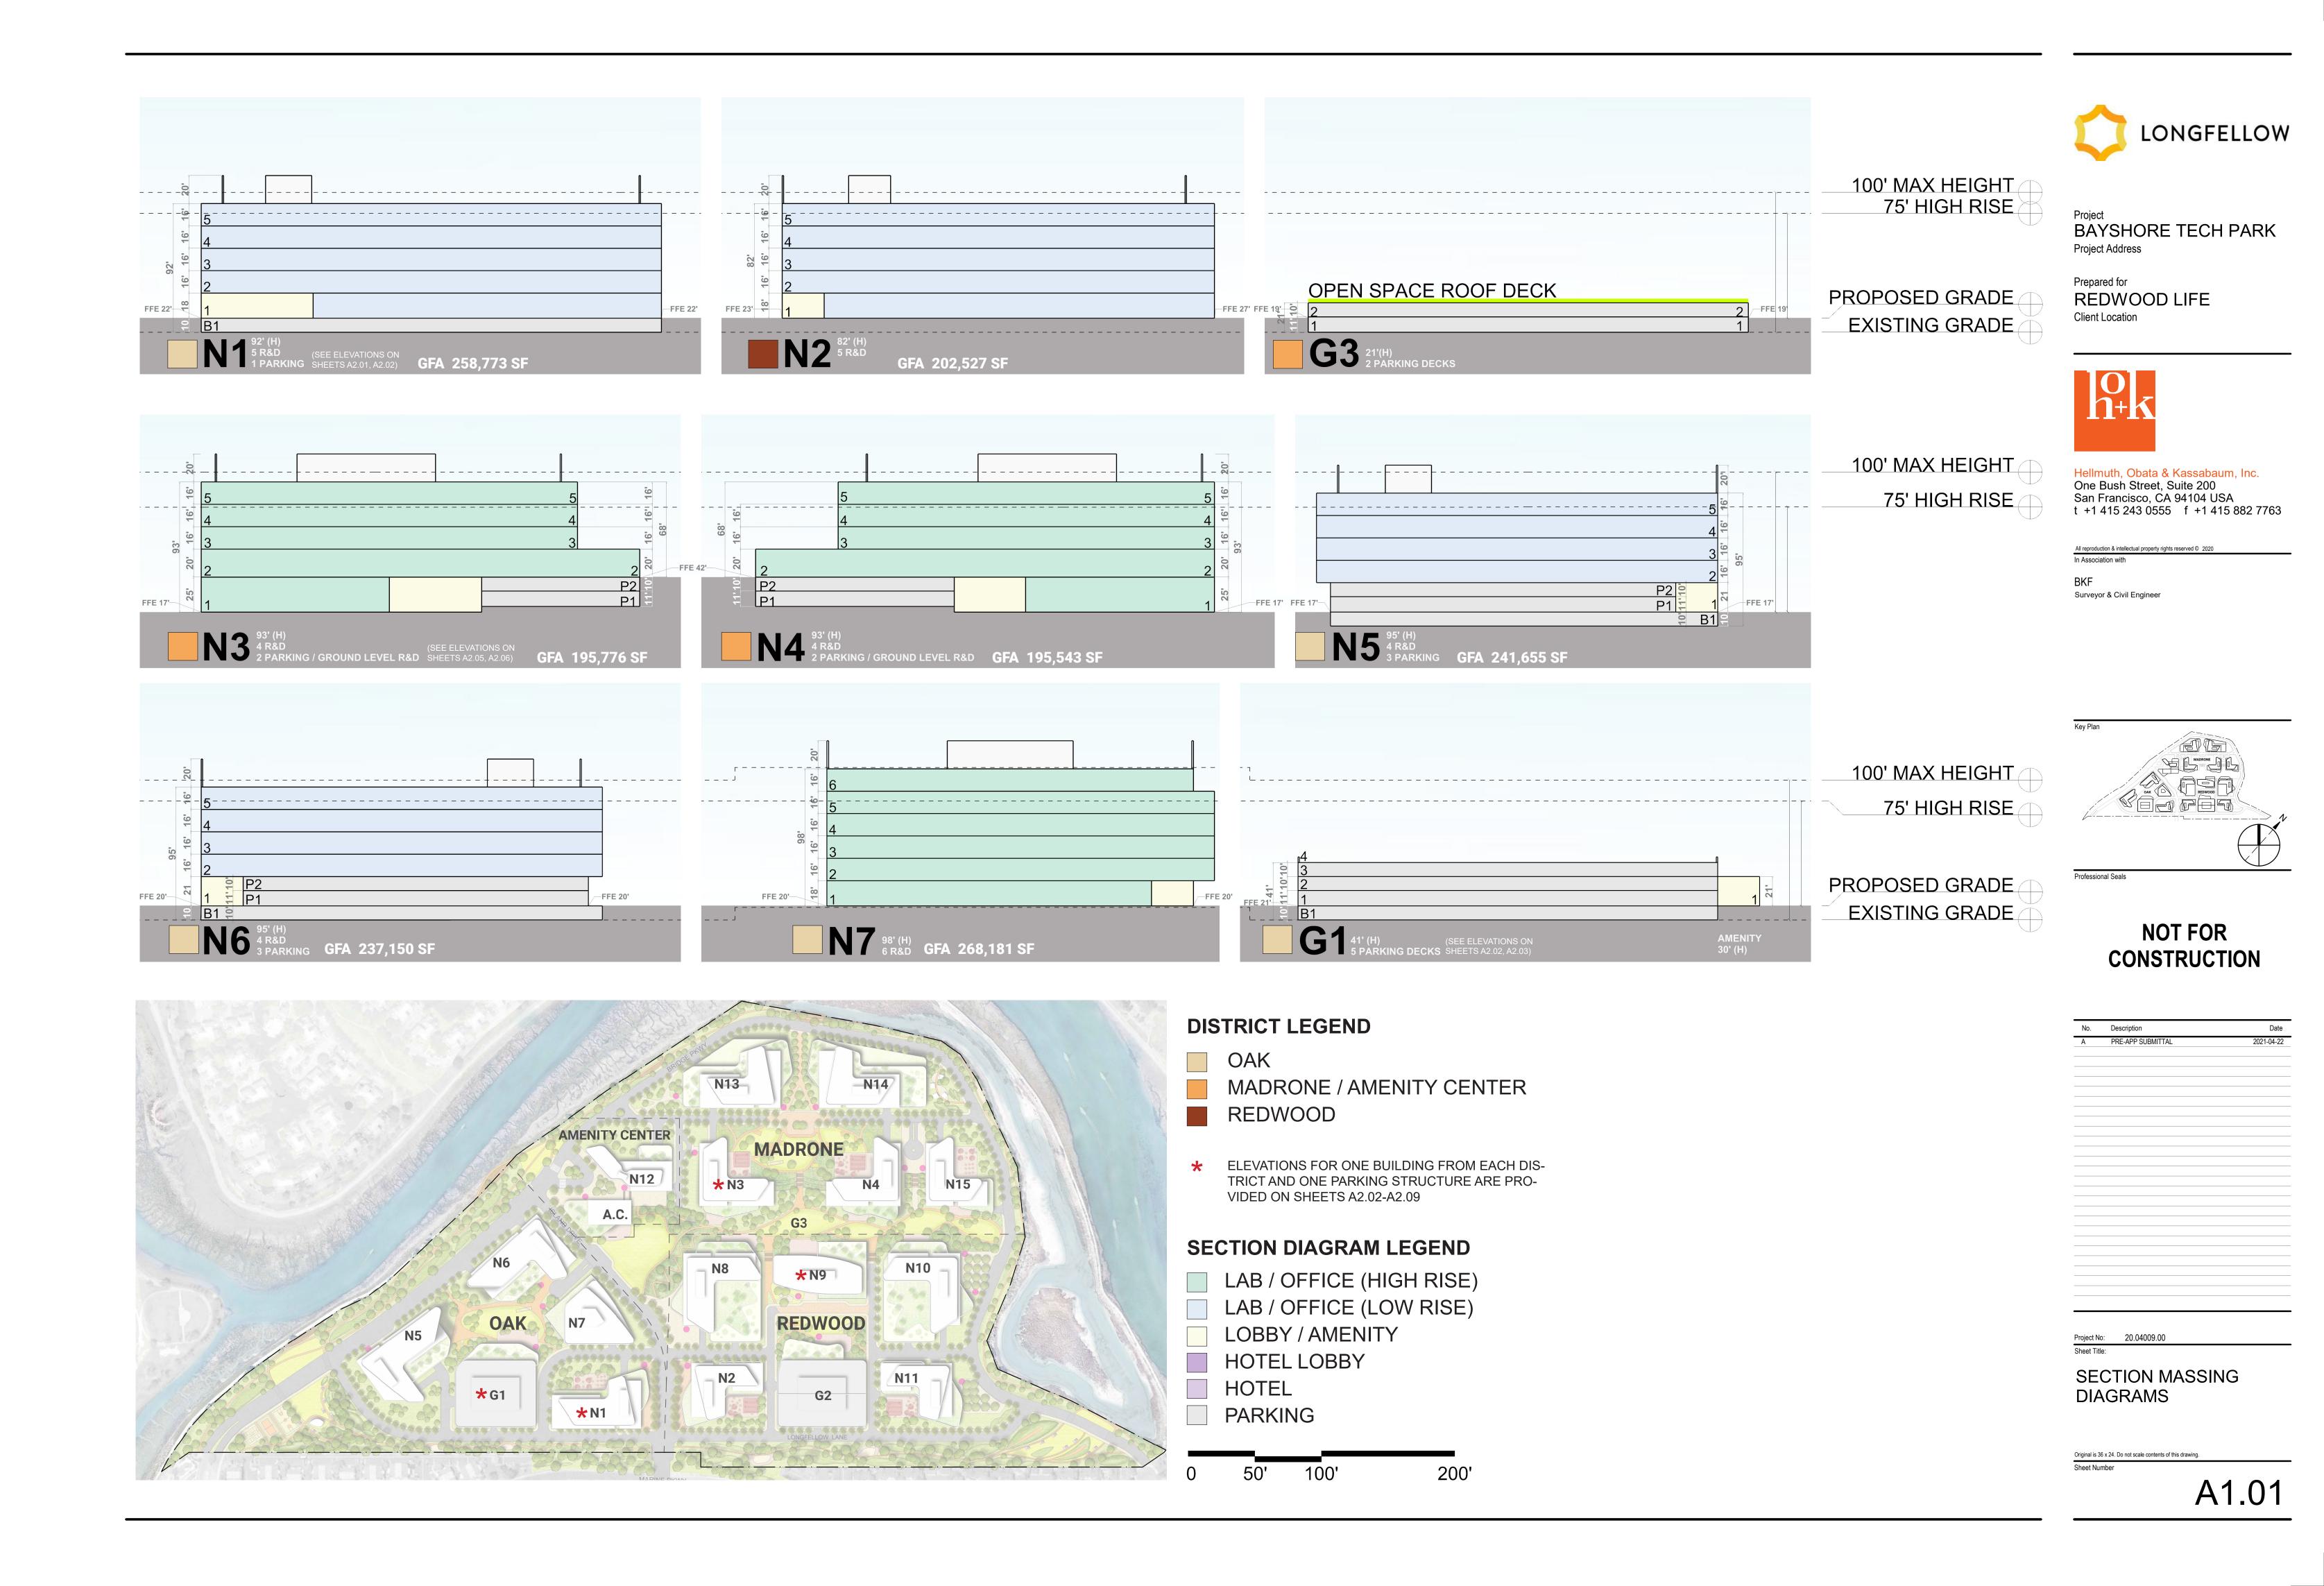
PROPOSED PARKING GARAGE PARCEL TREATMENT AREA ID

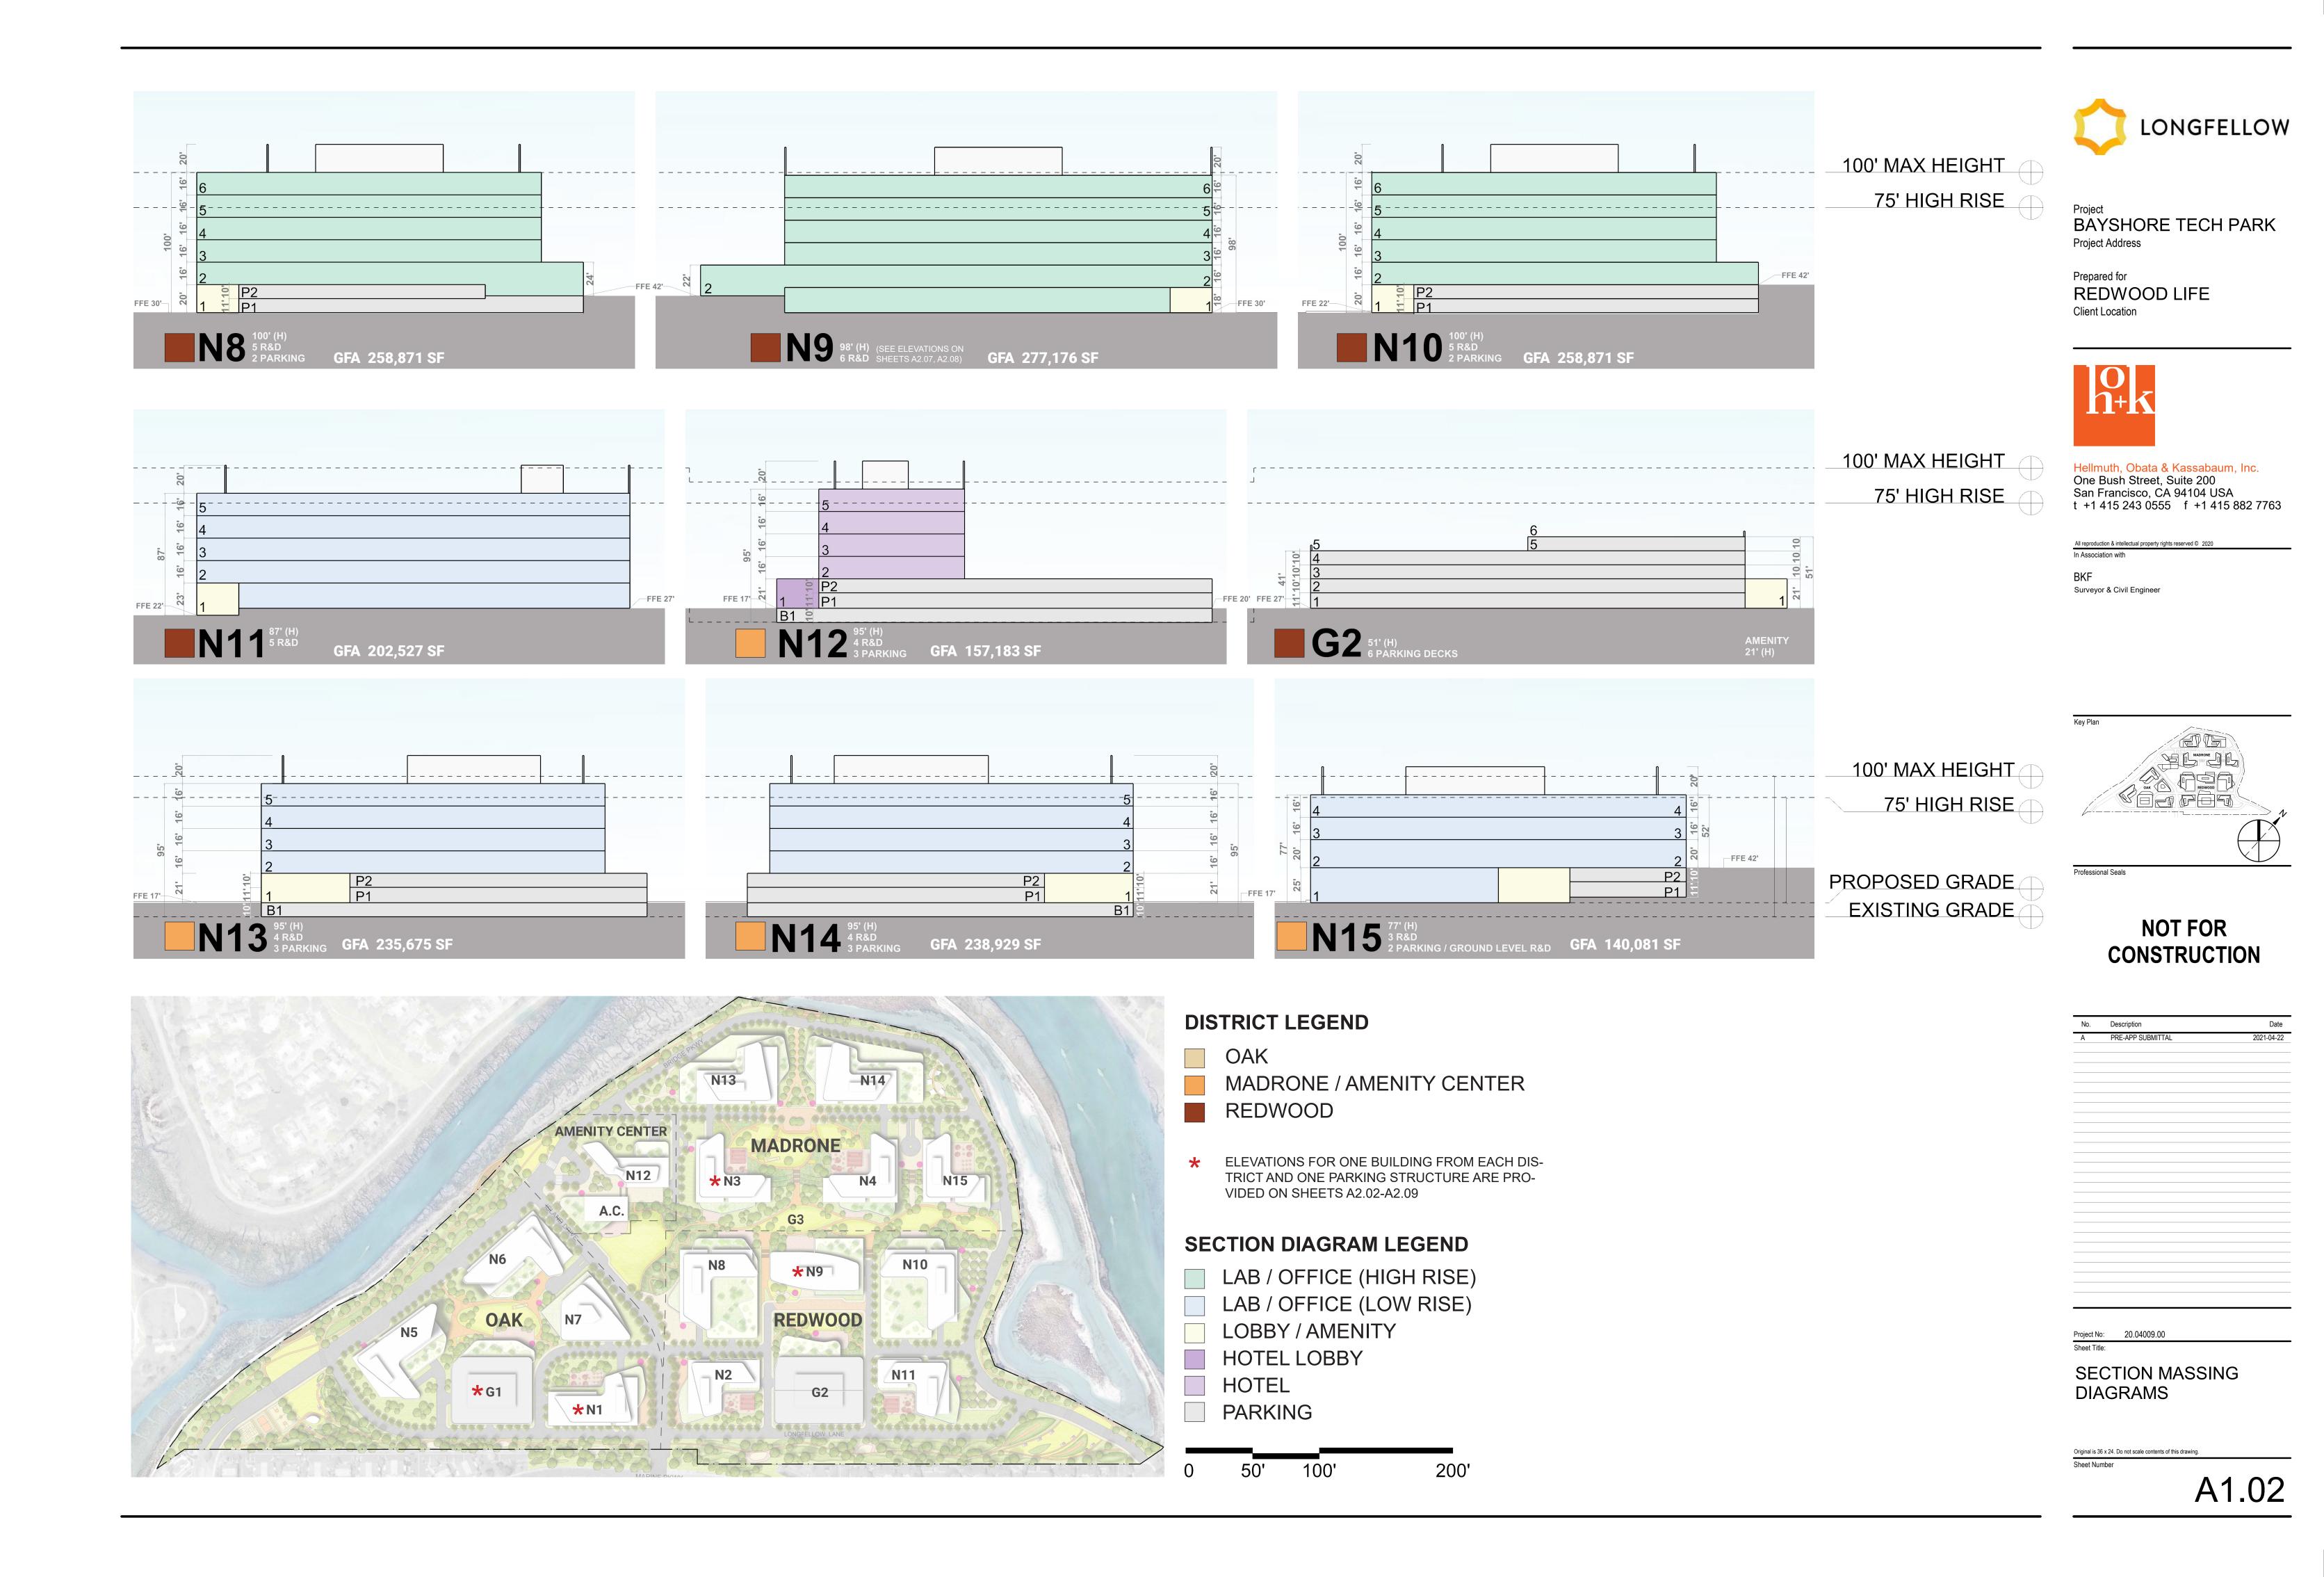


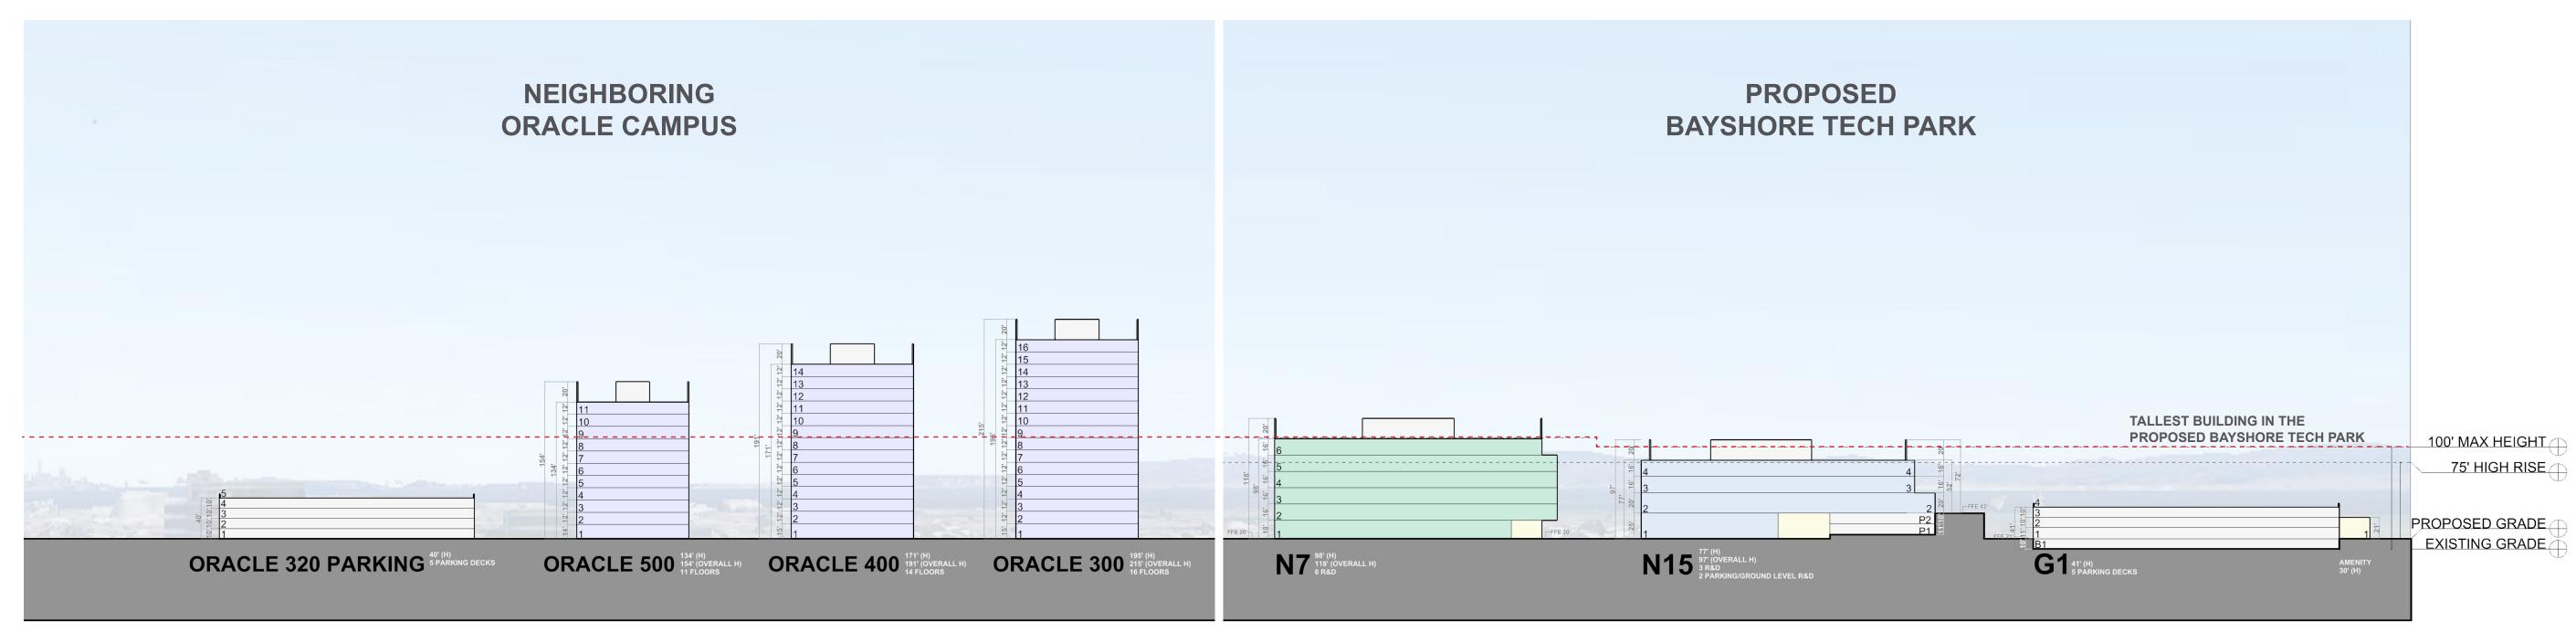




PROJECTS WITHIN SAN MATEO COUNTY LIMITS ARE SUBJECT TO LOCAL MUNICIPAL AND MUNICIPAL REGIONAL STORMWATER PERMIT REQUIREMENTS AS PART OF THE NATIONAL POLLUTANT DISCHARGE ELIMINATION SYSTEM PERMIT. -BIO-RETENTION TREATMENT AREAS IN THIS CONCEPTUAL DESIGN WERE SIZED USING THE COMBINATION FLOW AND VOLUME METHOD WORKSHEET PROVIDED BY THE SAN MATEO COUNTYWIDE WATER POLLUTION PREVENTION PROGRAM.









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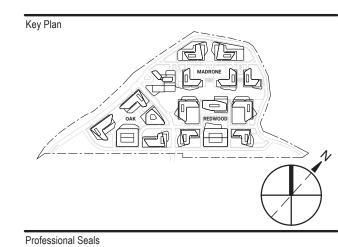


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No.	Description	Dat
Α	PRE-APP SUBMITTAL	2021-04-2
Project No:	20.04009.00	
Sheet Title:		
BUI	LDING HEIGH	Τ
COI	MPARISON WI	ΙП
NEL	GHBORING CA	AMPUS
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SE	CTION DIAGRAM LEGEND
	LAB / OFFICE (HIGH RISE)

LAB / OFFICE (LOW RISE) LOBBY / AMENITY PARKING

ORACLE CAMPUS OFFICE

PARKING

200'

A1.03



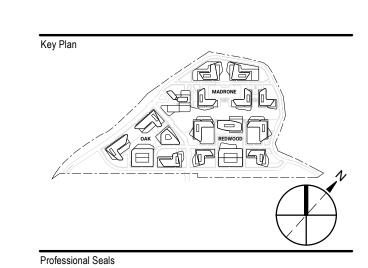
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No.DescriptionDateAPRE-APP SUBMITTAL2021-04-22

CONSTRUCTION

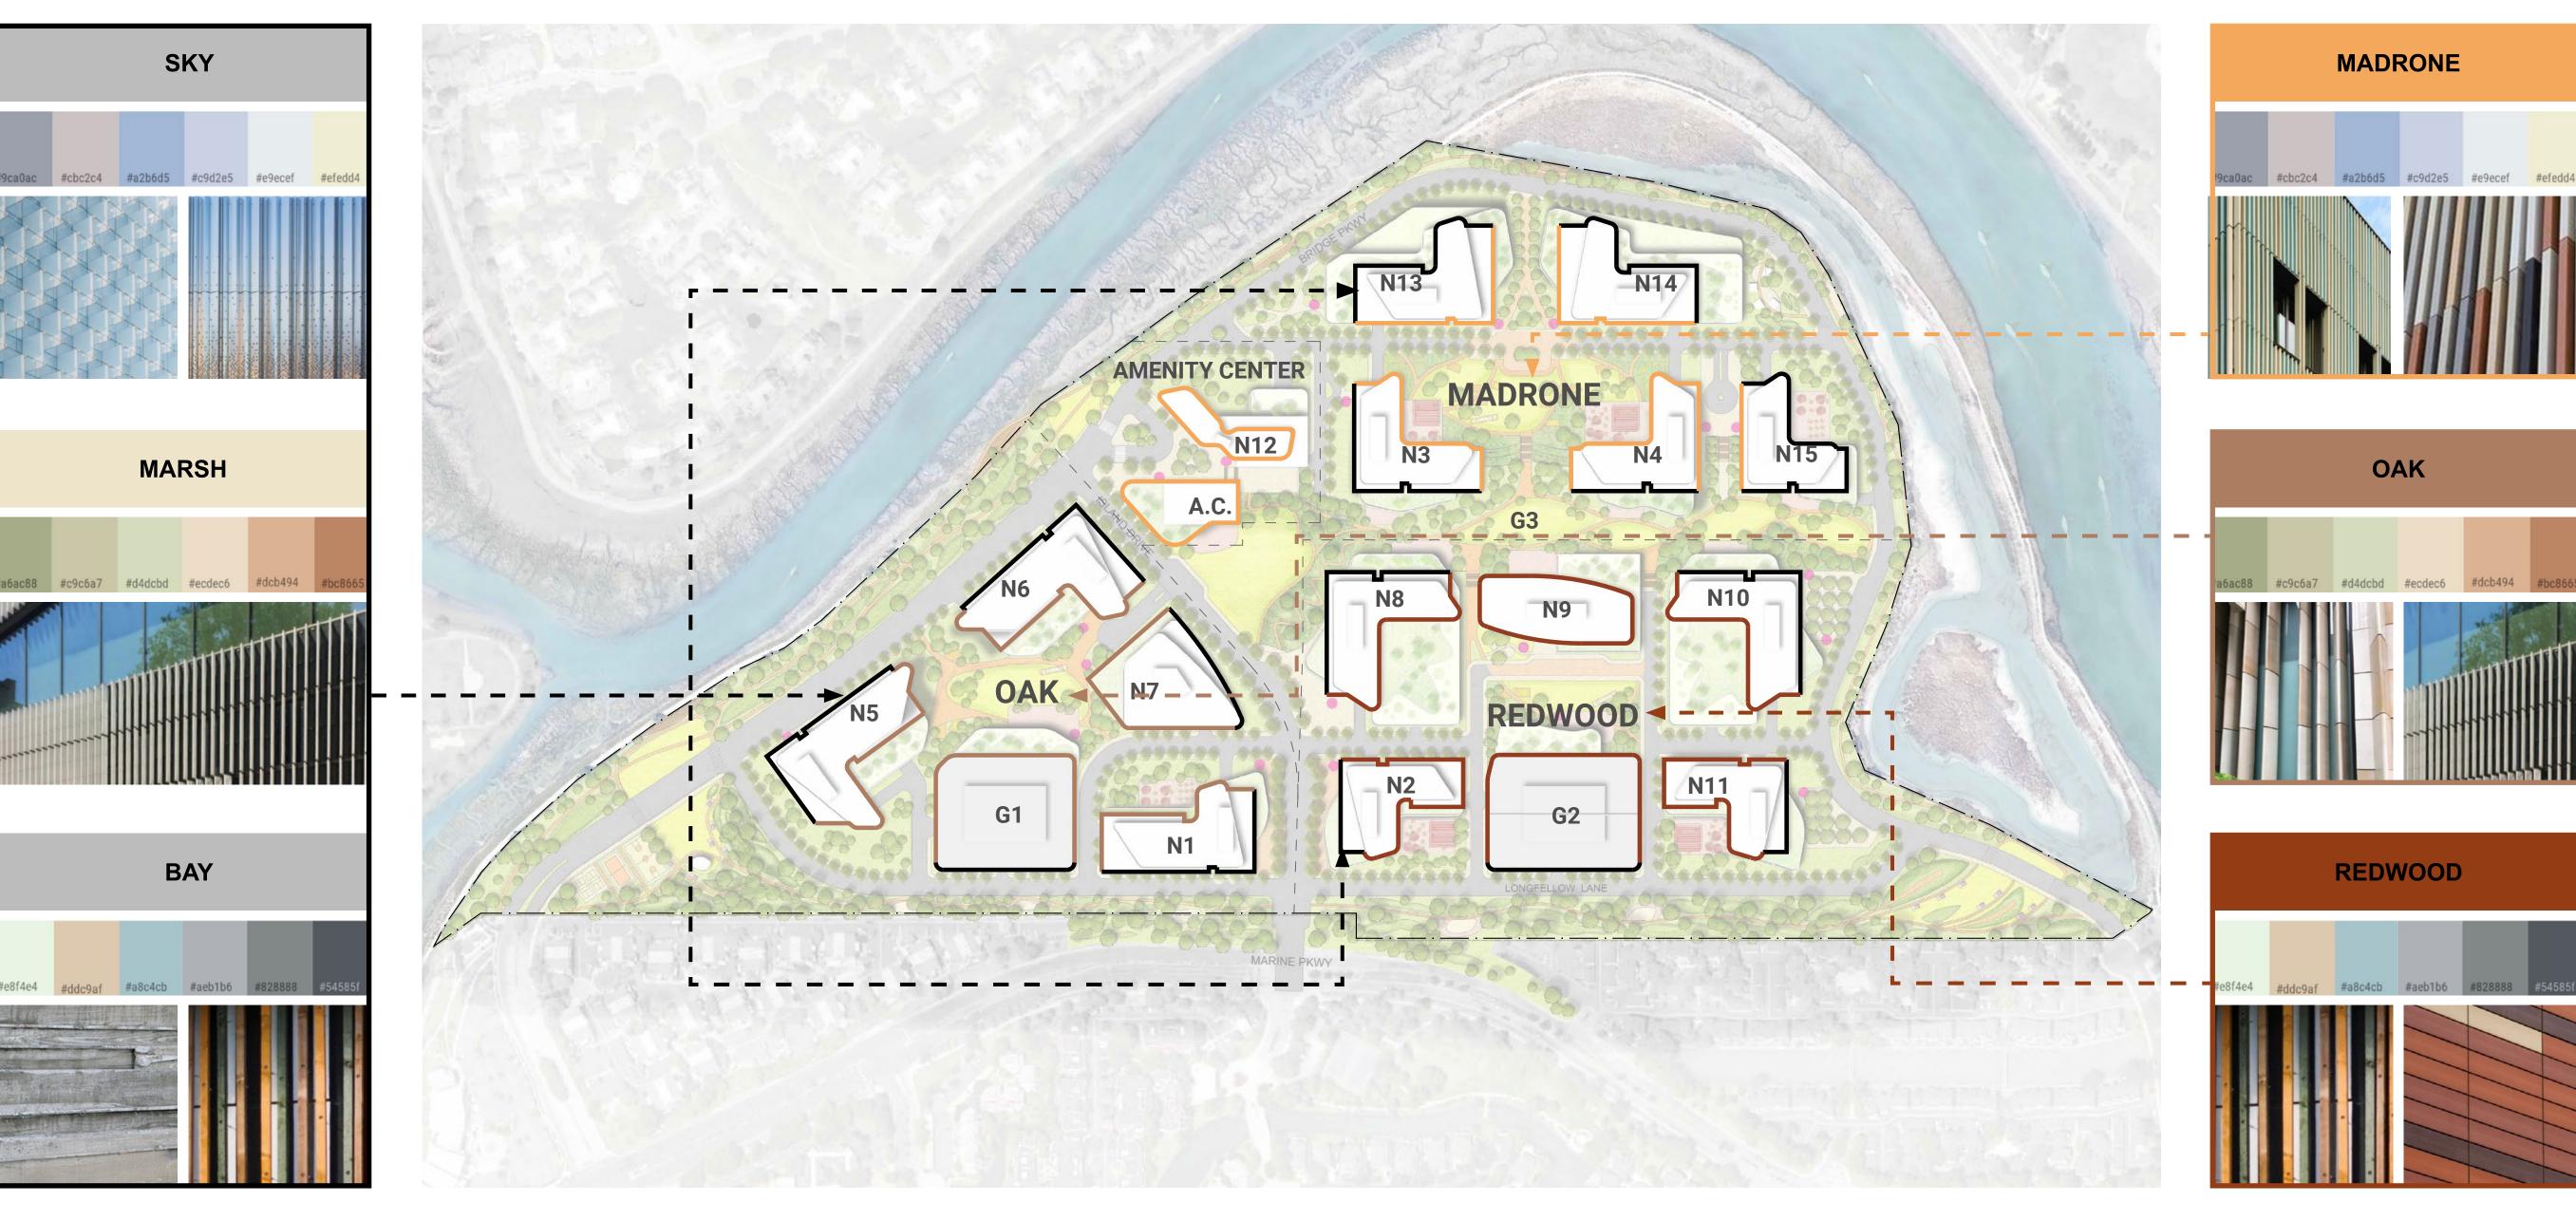
Project No: 20.04009.00

Sheet Title:

OVERALL MATERIAL PALETTE

Original is 36 x 24. Do not scale contents of this drawing.











BUILDING N1 - WEST ELEVATION

1/16" = 1'-0"



Project
BAYSHORE TECH PARK
Project Address

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Key Plan

N1

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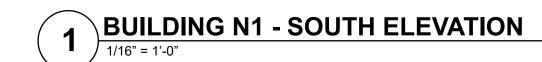
No.	Description	Dat
Α	PRE-APP SUBMITTAL	2021-04-2

Project No: 20.04009

EXTERIOR ELEVATIONS - BUILDING N1 - NORTH & WEST

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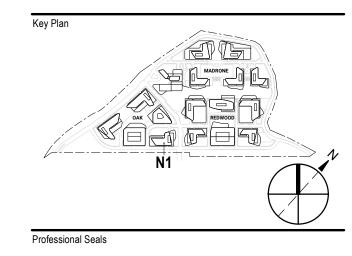
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Α	PRE-APP SUBMITTAL	2021-04-2
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Project No: 20.04009.0

Sheet Title:

EXTERIOR ELEVATIONS - BUILDING N1 - SOUTH & EAST

Original is 36 x 24. Do not scale contents of this drawing.

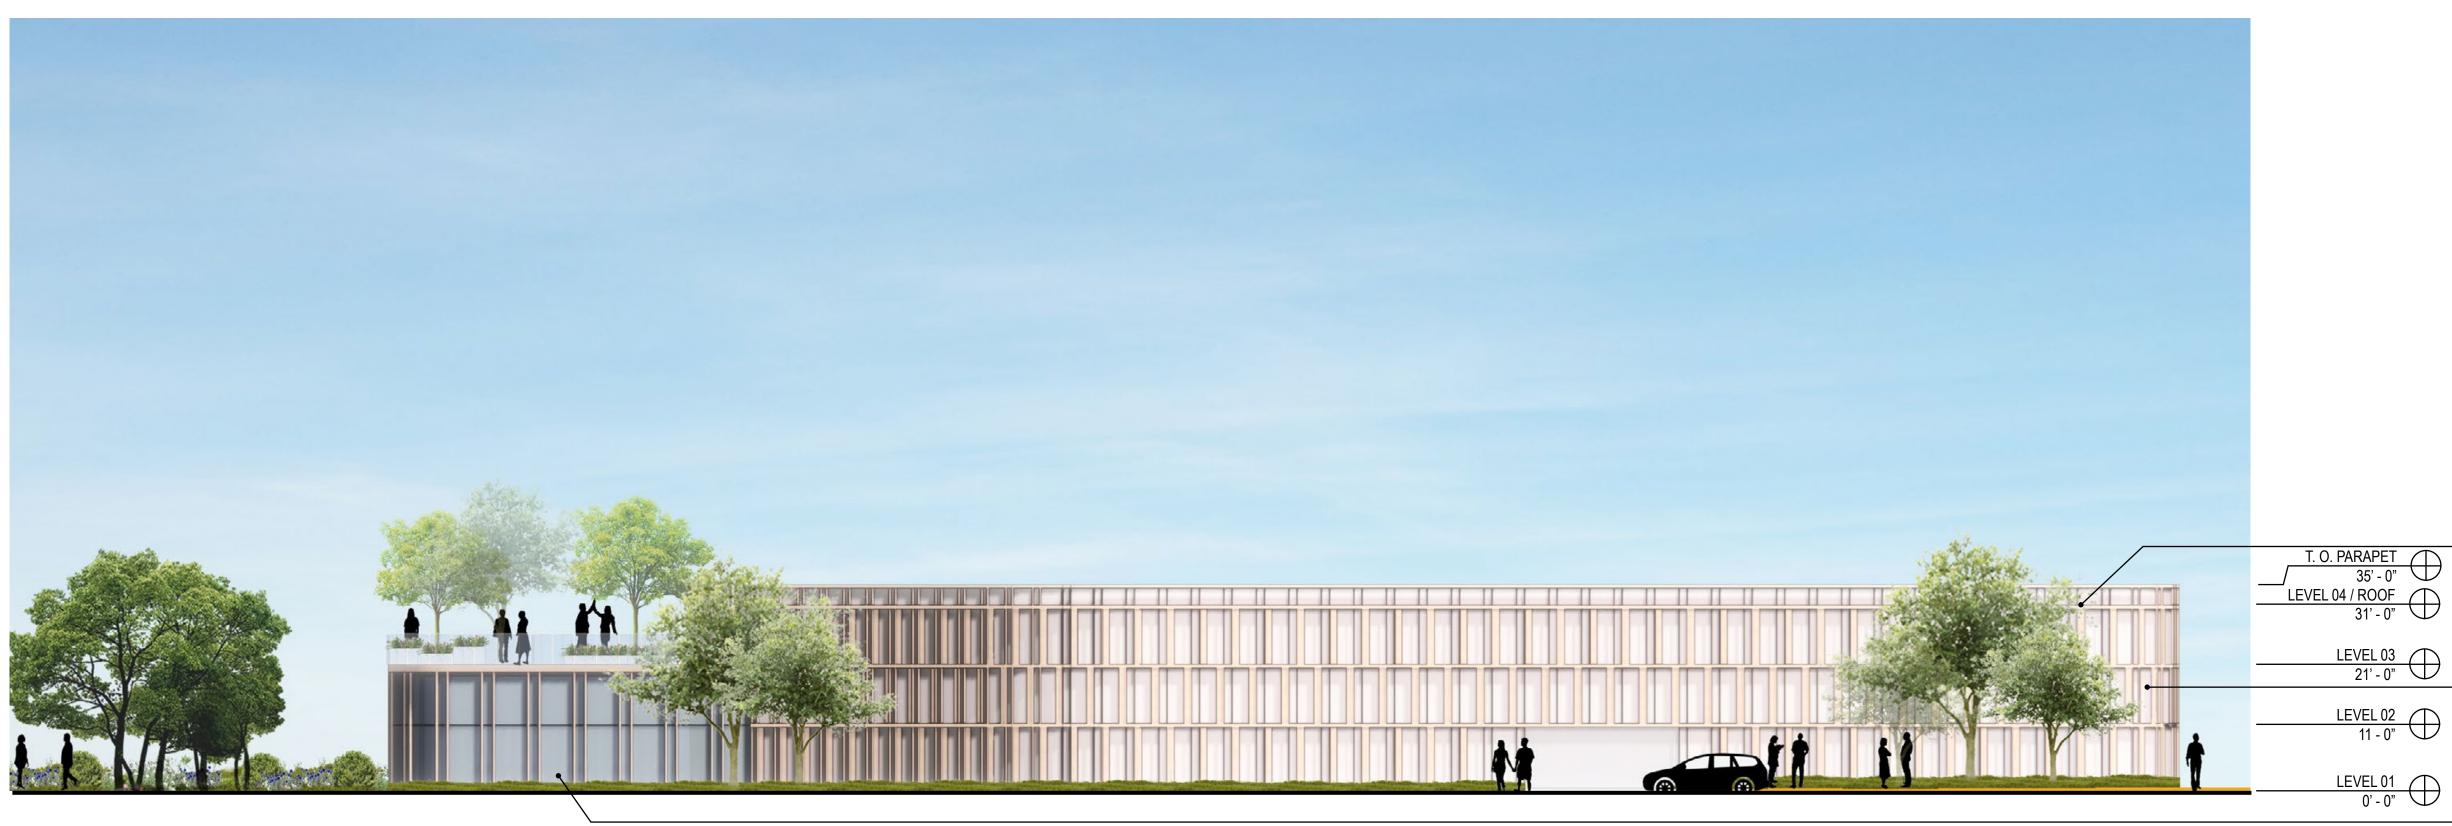


1 BUILDING G1 - NORTH ELEVATION

1/16" = 1'-0"

2 BUILDING G1 - WEST ELEVATION

1/16" = 1'-0"



OAK DISTRICT COLOR PALETTE







Project
BAYSHORE TECH PARK Project Address

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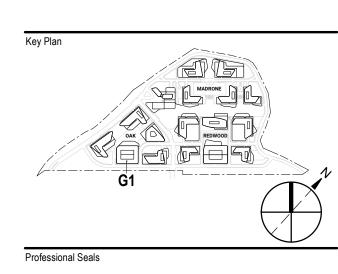


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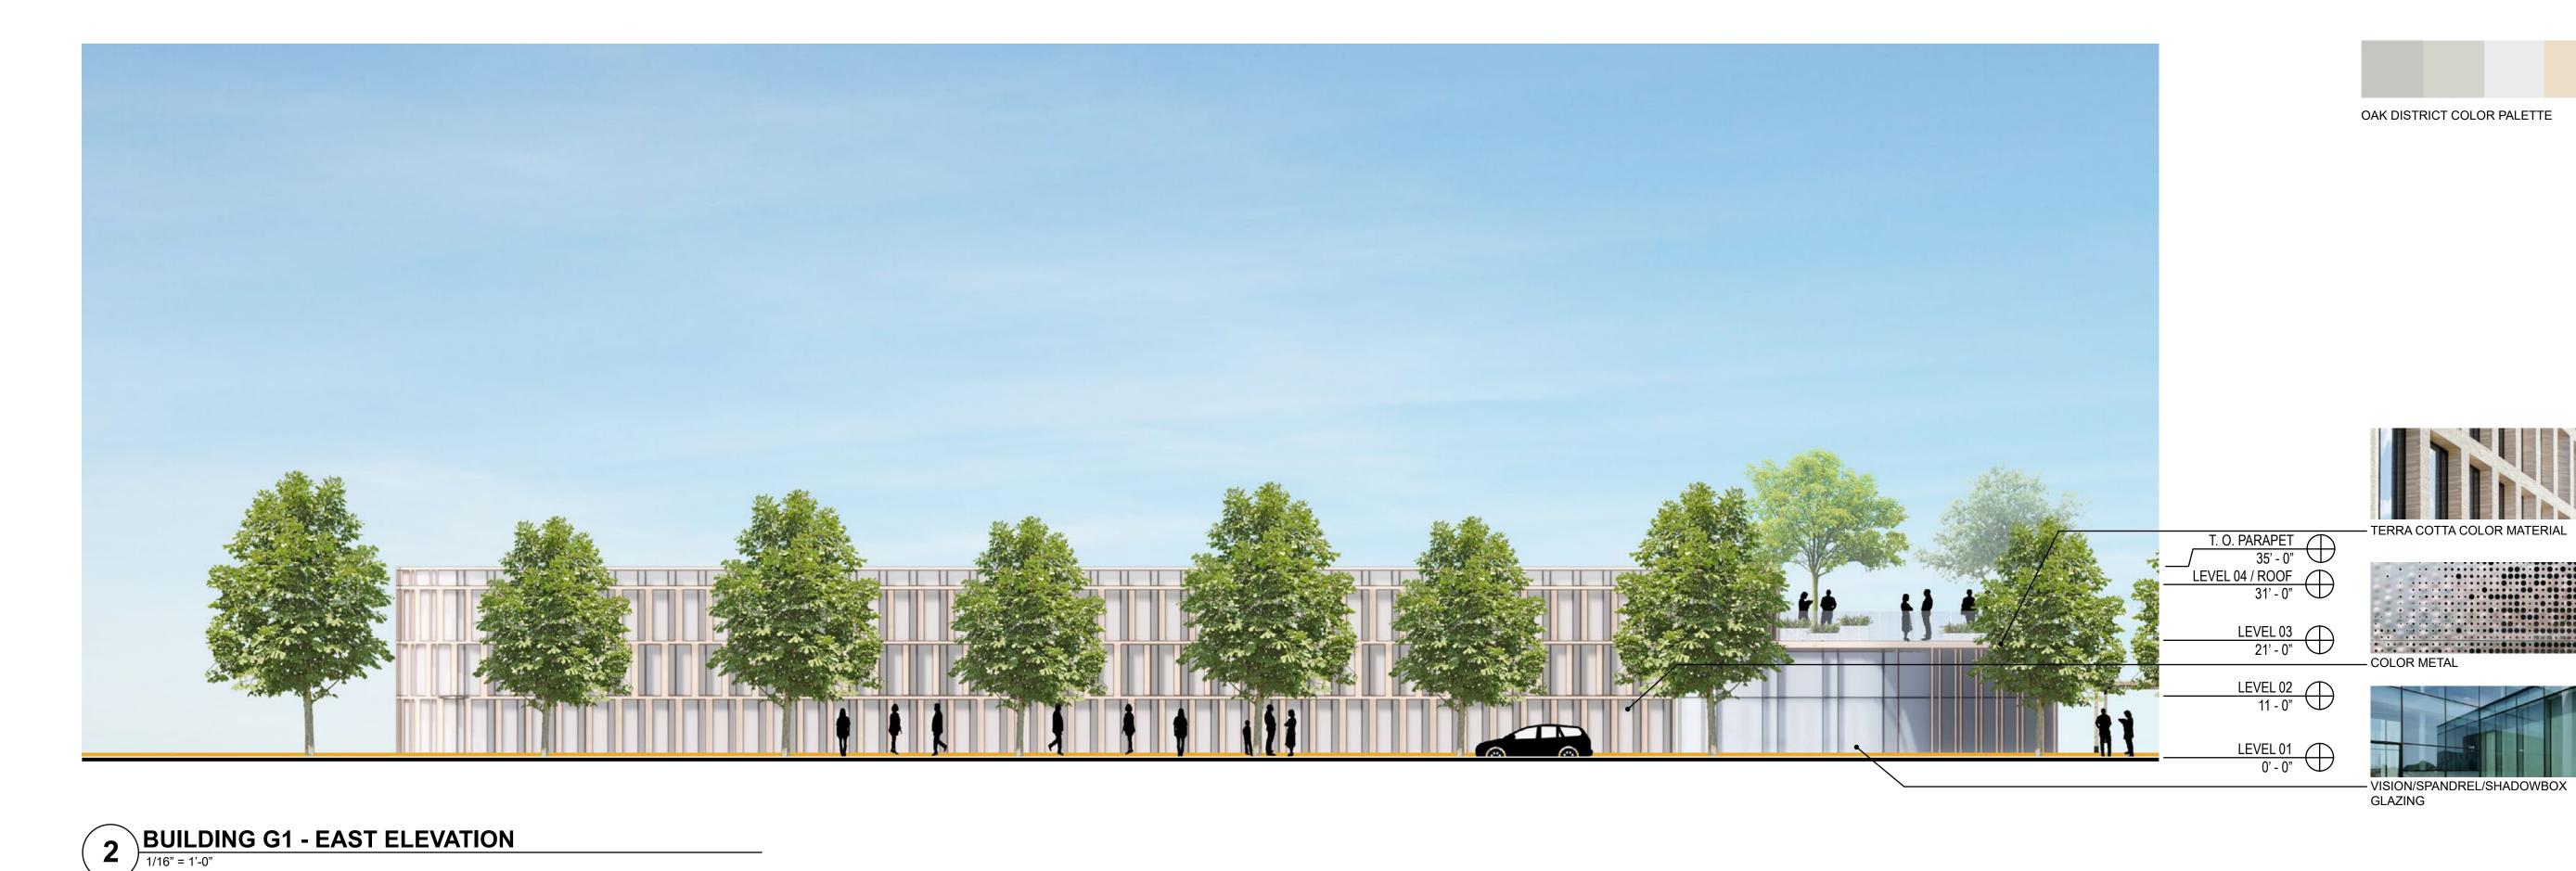
Original is 36 x 24. Do not scale contents of this drawing.

EXTERIOR ELEVATIONS - BUILDING G1 - NORTH & WEST



1 BUILDING G1 - SOUTH ELEVATION

1/16" = 1'-0"



N3-SOUTH

Project
BAYSHORE TECH PARK

LONGFELLOW

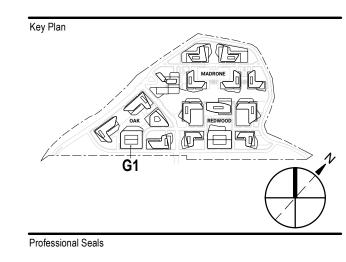
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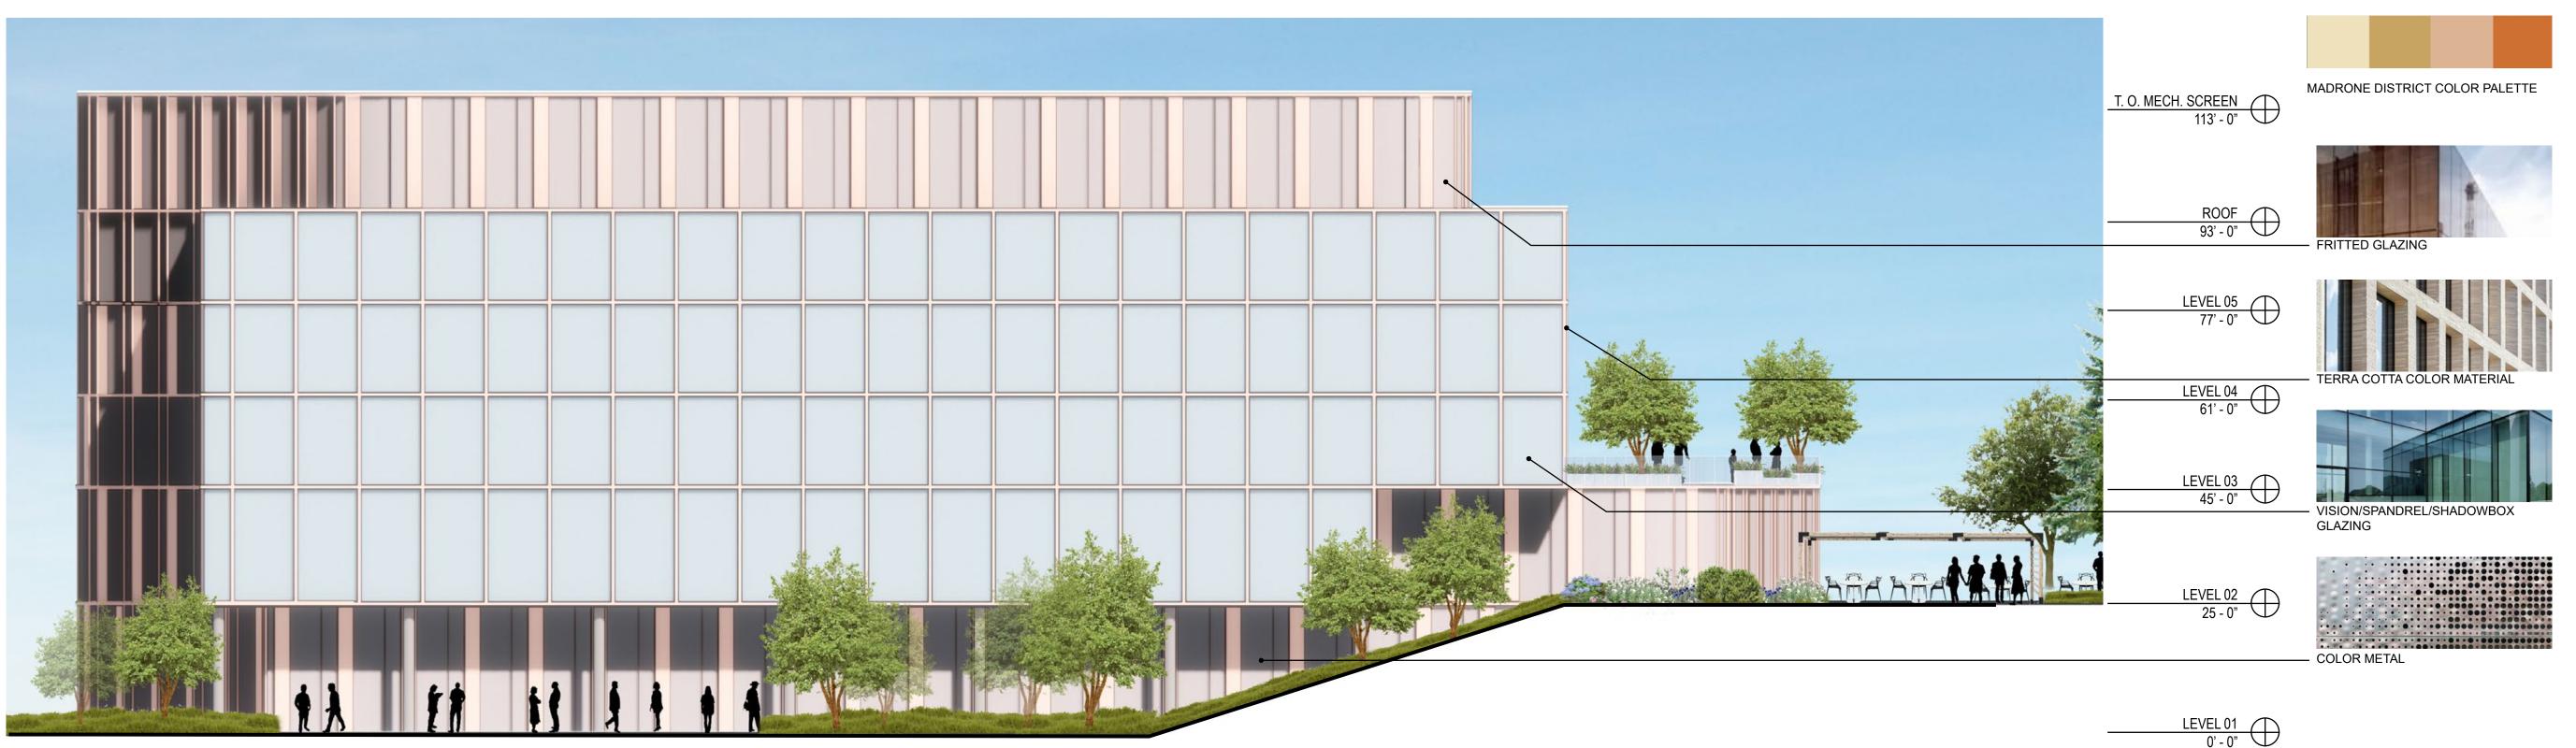
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EXTERIOR ELEVATIONS - BUILDING G1 - SOUTH & EAST

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1 BUILDING N3 - NORTH ELEVATION
1/16" = 1'-0"



**BUILDING N3 - WEST ELEVATION**1/16" = 1'-0"



Project
BAYSHORE TECH PARK Project Address

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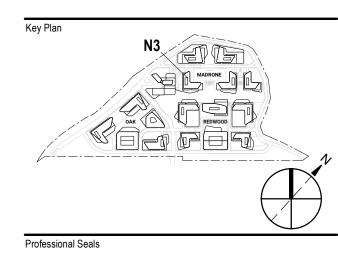


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Sheet Title:

EXTERIOR ELEVATIONS - BUILDING N3 - NORTH & WEST

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Project No:	20.04009.00	

EXTERIOR ELEVATIONS - BUILDING N3 - SOUTH & EAST

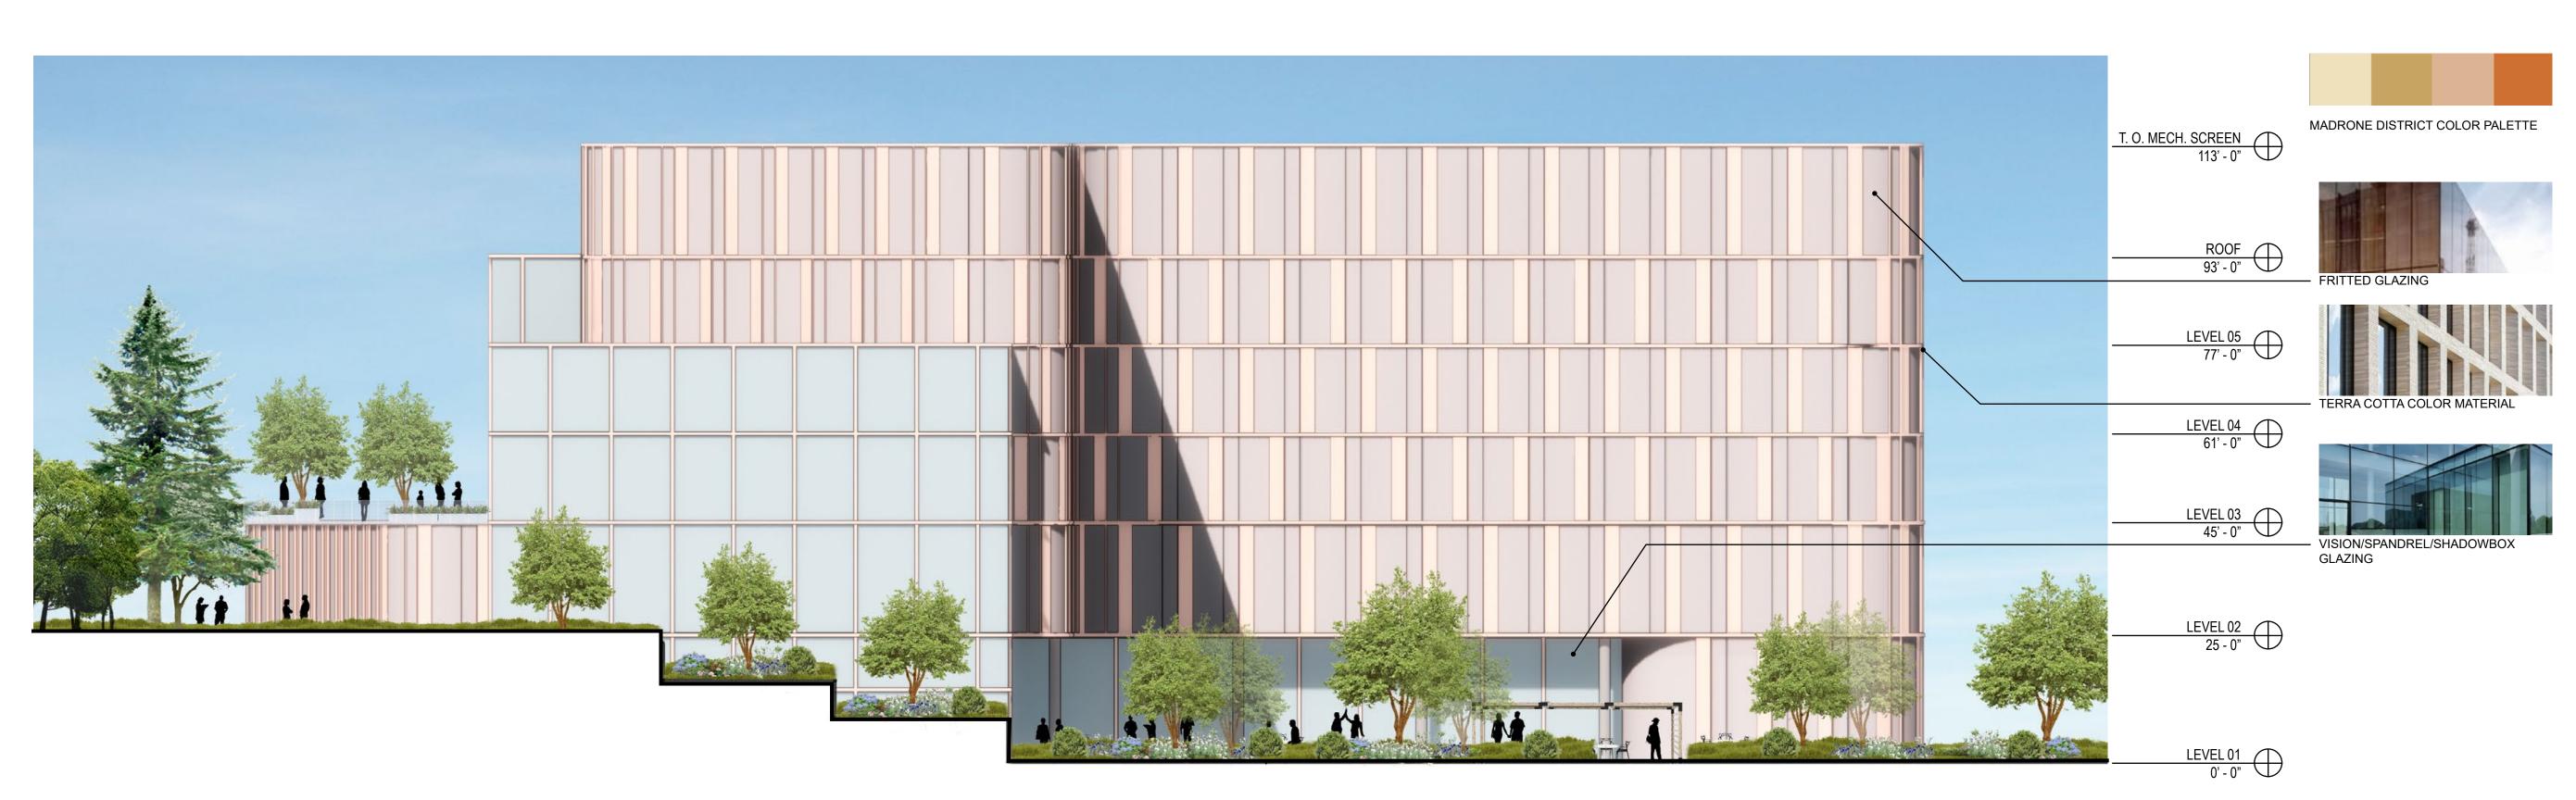
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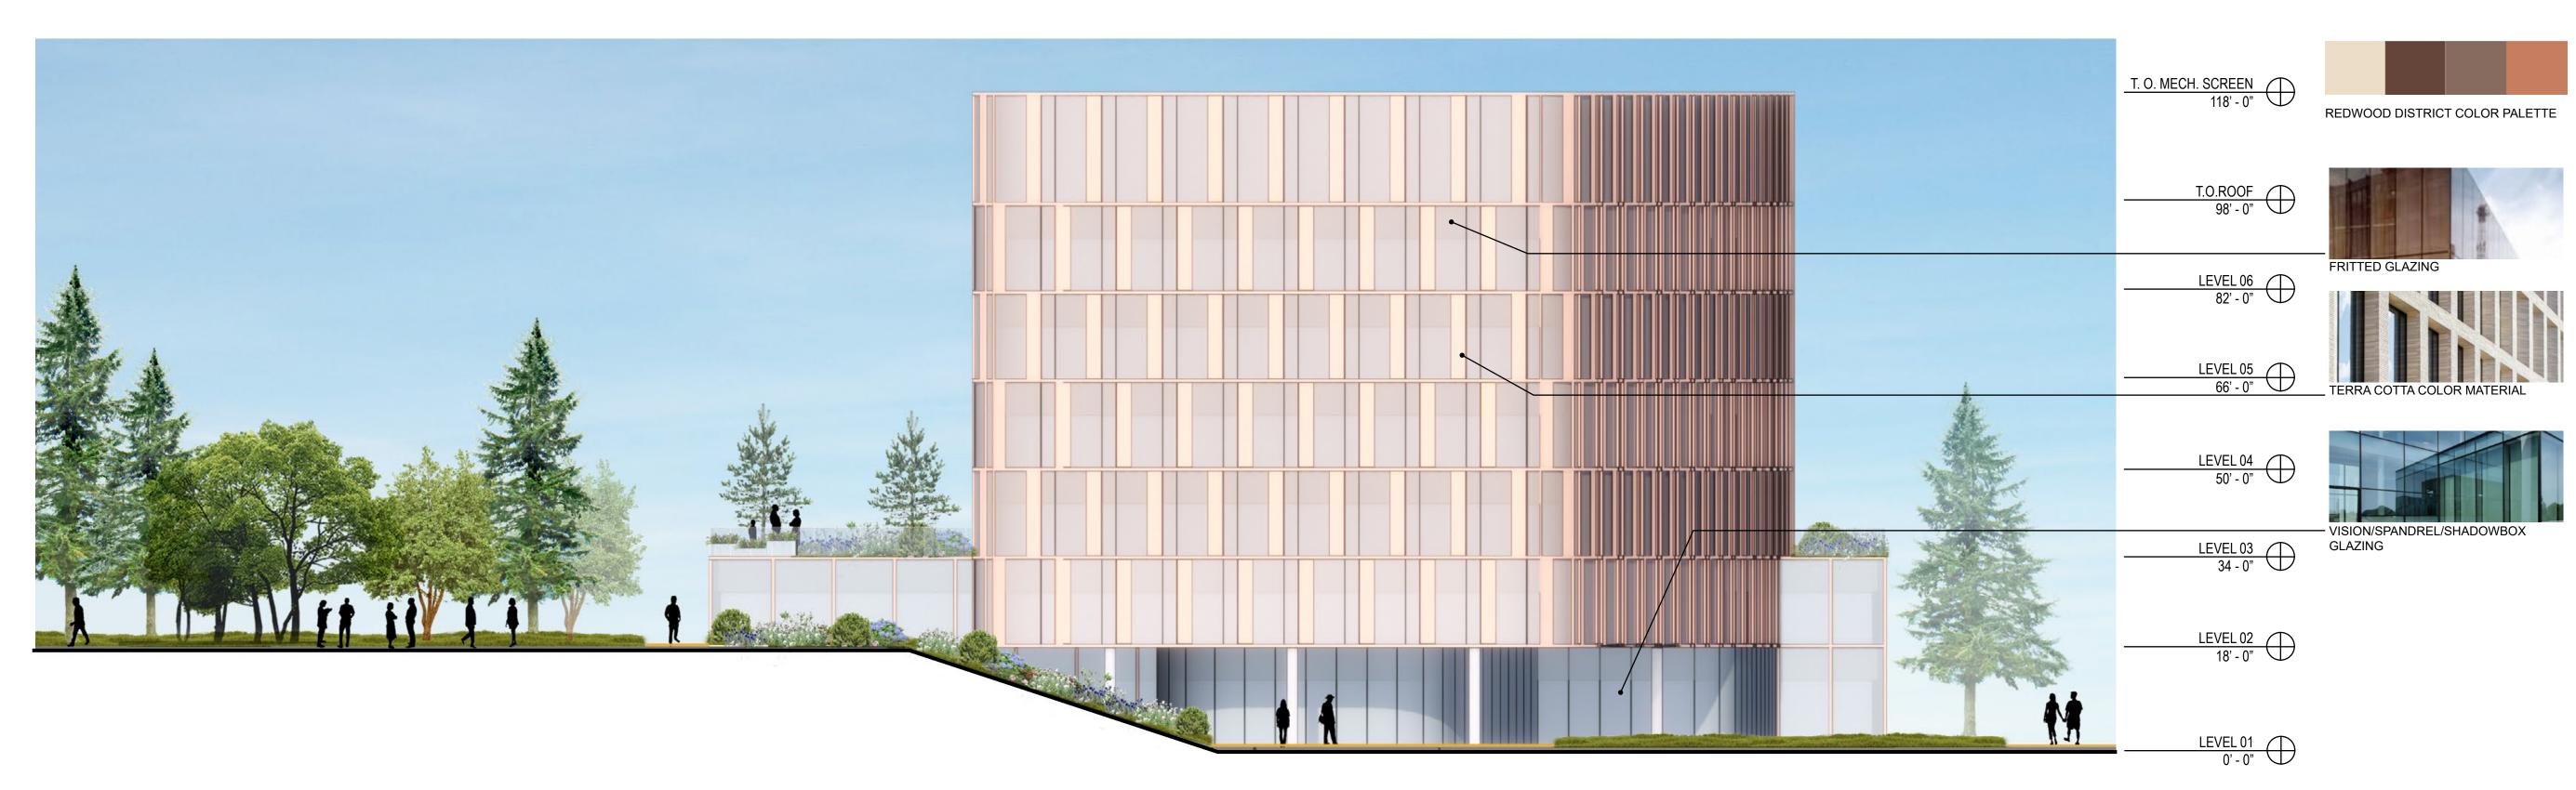
1 BUILDING N3 - SOUTH ELEVATION

1/16" = 1'-0"









2 BUILDING N9 - WEST ELEVATION

1/16" = 1'-0"



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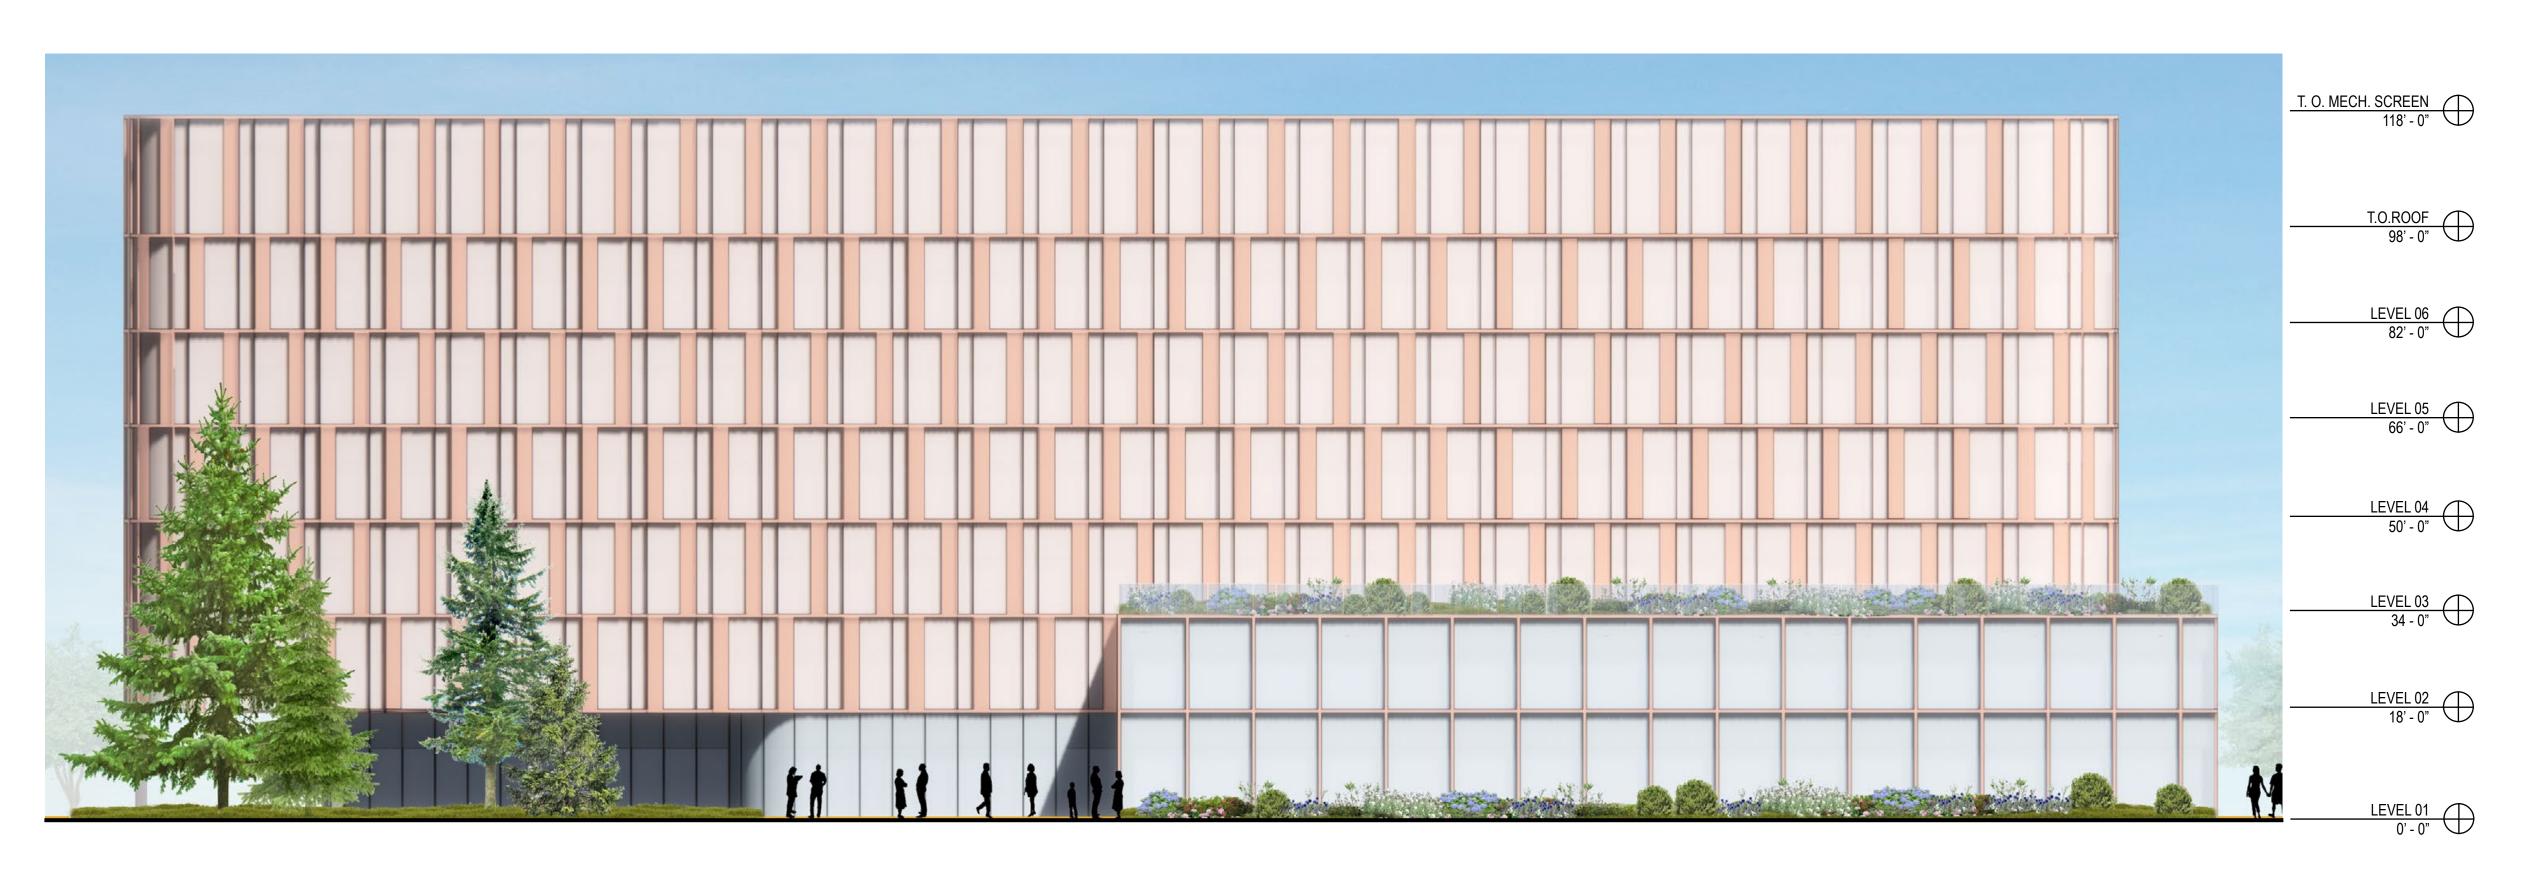
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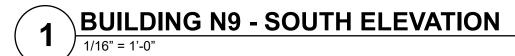
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No.	Description	Date 2024 04 22
Α	PRE-APP SUBMITTAL	2021-04-22

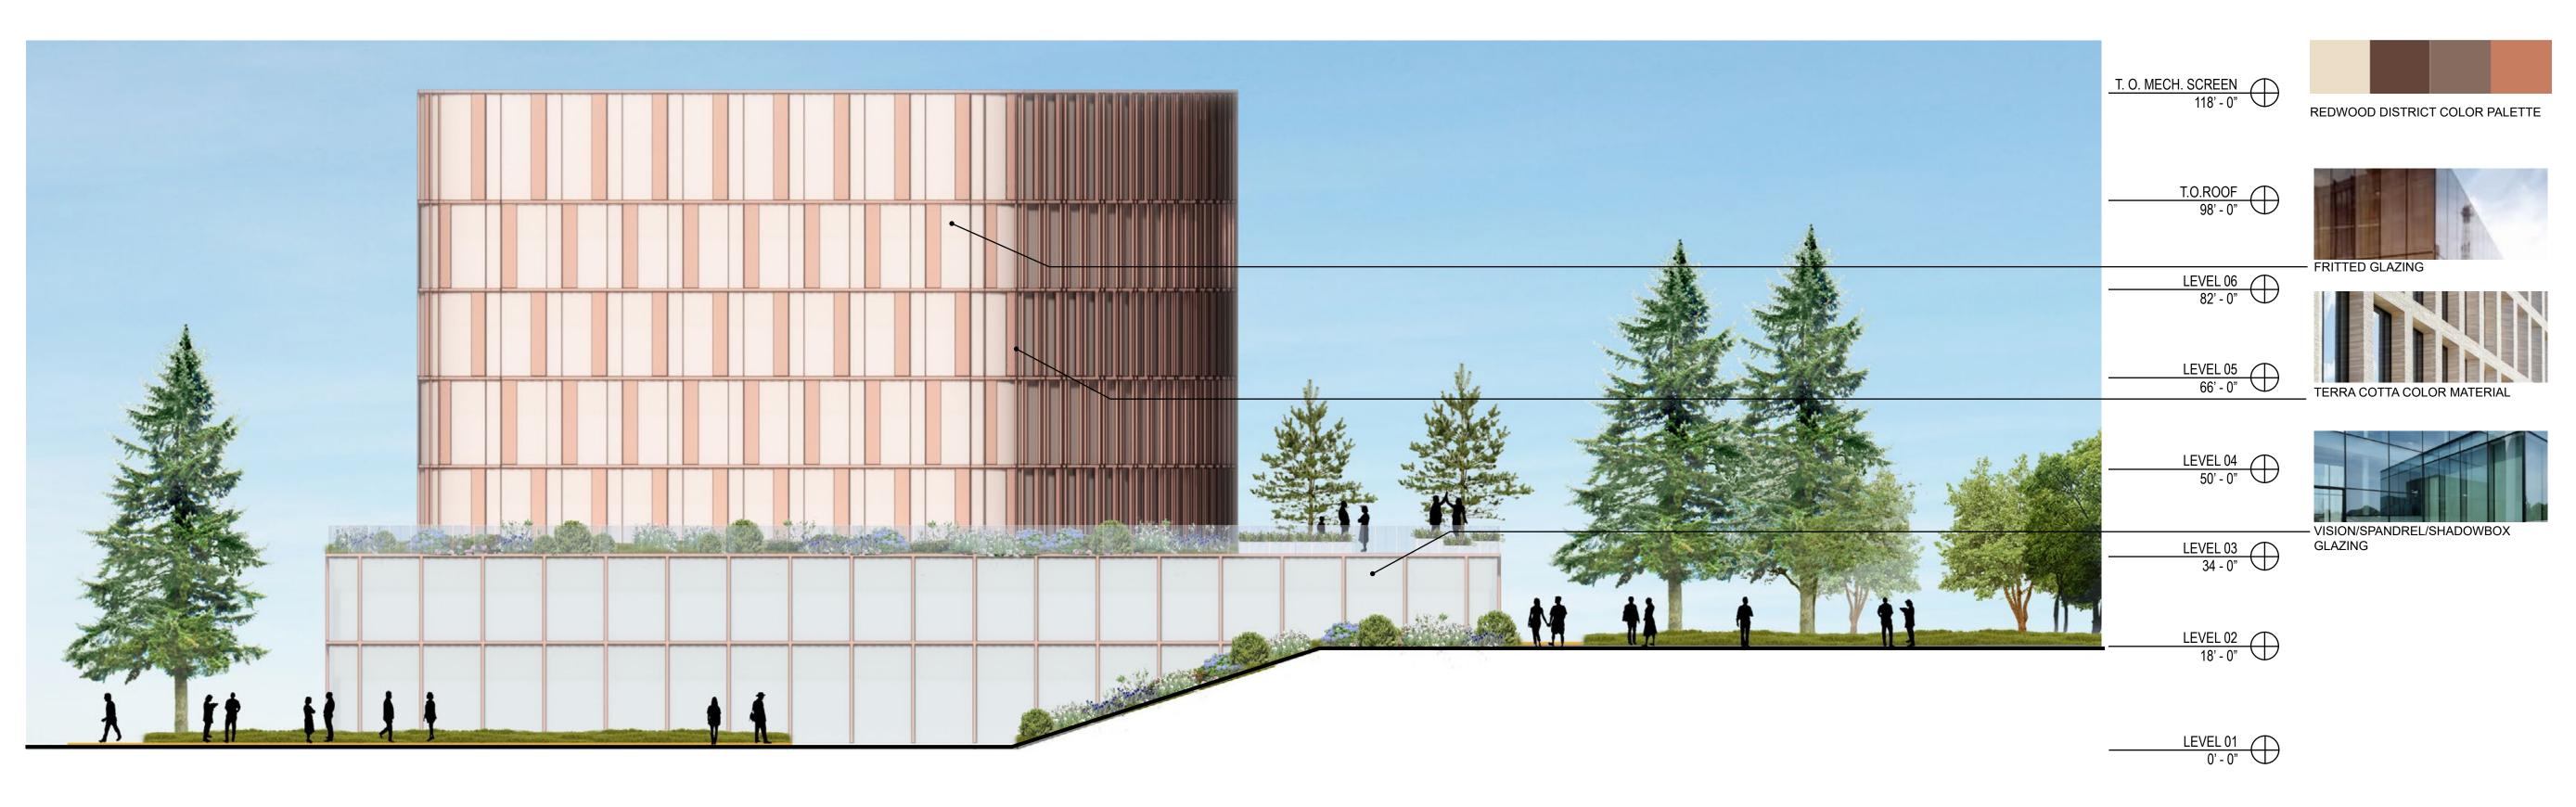
EXTERIOR ELEVATIONS - BUILDING N9 - NORTH & WEST

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**BUILDING N9 - EAST ELEVATION**1/16" = 1'-0"





Project
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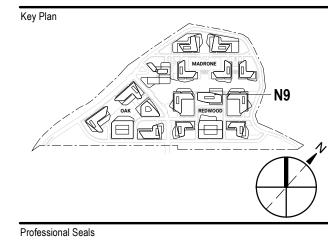


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roject No:	20.04009.00	

EXTERIOR ELEVATIONS
- BUILDING N9 - SOUTH & EAST

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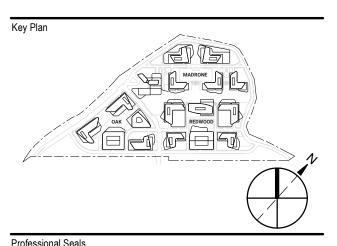
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Description	Date
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	·

VIEW 1 -WATERFRONT SW







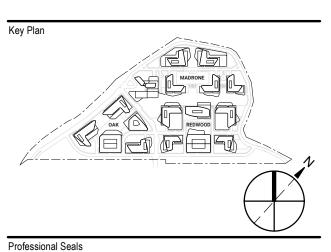
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VIEW 2 -

WATERFRONT SE







Project
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Project Address

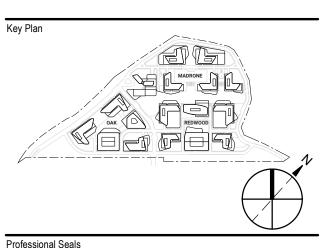
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oject No: 20.04009.00

VIEW 3 -GATEWAY

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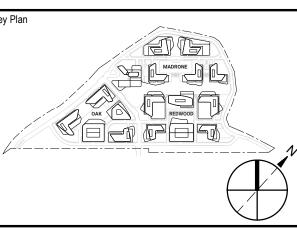
Project
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VIEW 4 -THE COMMONS

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